

			LEGEND				
LABEL	SYMBOL	PROJECT TOTAL	DESCRIPTION & SPECIFICATION	LABEL	SYMBOL	PROJECT TOTAL	DESCRIPTION & SPECIFICATION
(1)	Ö	27	Small Uplight (Remote Transformer) Kim EL700F3-7L4KUV/DB With AGS71 / JBR4 7W LED	(4)	⊠	٦	Building Mounted Sconce Re: Arch for Exact Locations
0	界	10	Building Mounted Flood Light Re: Arch for Exact Locations	٥	p p p p	202 LF	String Lights (Field Measure for Exact Run Lengths), American Lighting Festoon - LFS-12V-1.5W-LED-WW
				NOT	ES:		
٥	Þ	13	Step/Niche Lights Nora NSW800 / NSW851/32-BZ LED	2. / 3. 8	notes. Above fi	xture PF	thing plans for detailed lighting layouts / ROJECT totals are for ENTIRE site. ctrical plans for exterior architectural
(1)	Ø	4	Pole Light Global Lighting Perspectives (GLP) - GC7030-120LED with GP210-10 - BK Textured Black Finish		99.		



Architecture + Planning

888.456.5849


ktgy.com







EXHIBIT NO.25A6

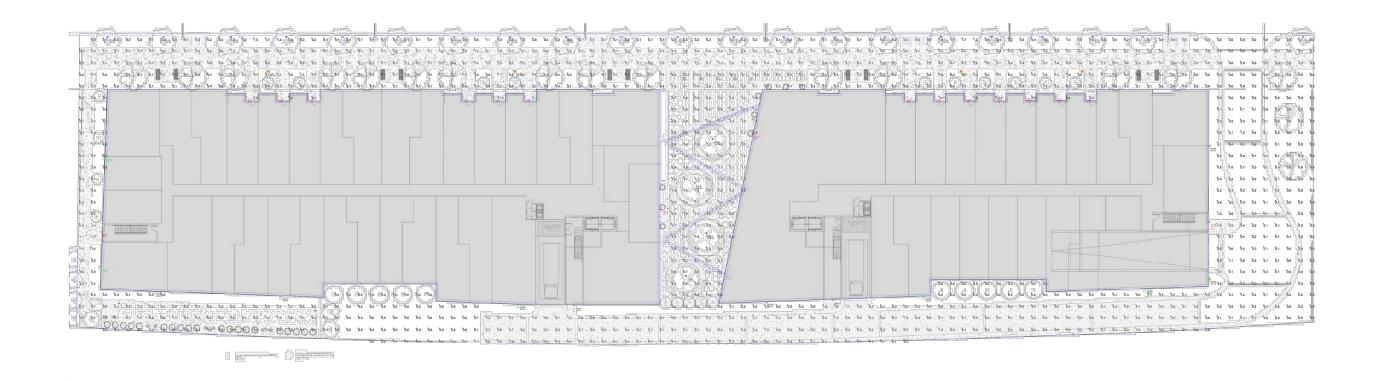

Luminaire S						
Symbol	Qty	Label	Arrangement	Lum. Lumens	LLF	Description
•	5	BOL	SINGLE	1224	1.000	XBVR-ID-LED-24-400-NW-UE
→	6	EA-LG	SINGLE	1624	1.000	7176-34-H16LED-40K
-O	10	FLOOD	SINGLE	1432	1.000	EL700NF-12L4K
0	110	LAMP	SINGLE	47	1.000	LFS-12V-1.5-LED-WW
<u>(()</u>	4	POST	SINGLE	4818	1.000	GC7030-60WLED-T3
+	13	STEP	SINGLE	188	1.000	FCSL105-120V-4K-190LM
0	4	UP-LG	SINGLE	939	1.000	EL700F3-9L4K
0	21	UP-SM	SINGLE	807	1.000	EL700F3-7L4K


Calculation Summary							
Label	CalcType	Units	Avg	Max	Min	Avg/Min	Max/Min
GROUND_Planar	Illuminance	Fc	1.00	43.8	0.0	N.A.	N.A.







Civil Exhibits

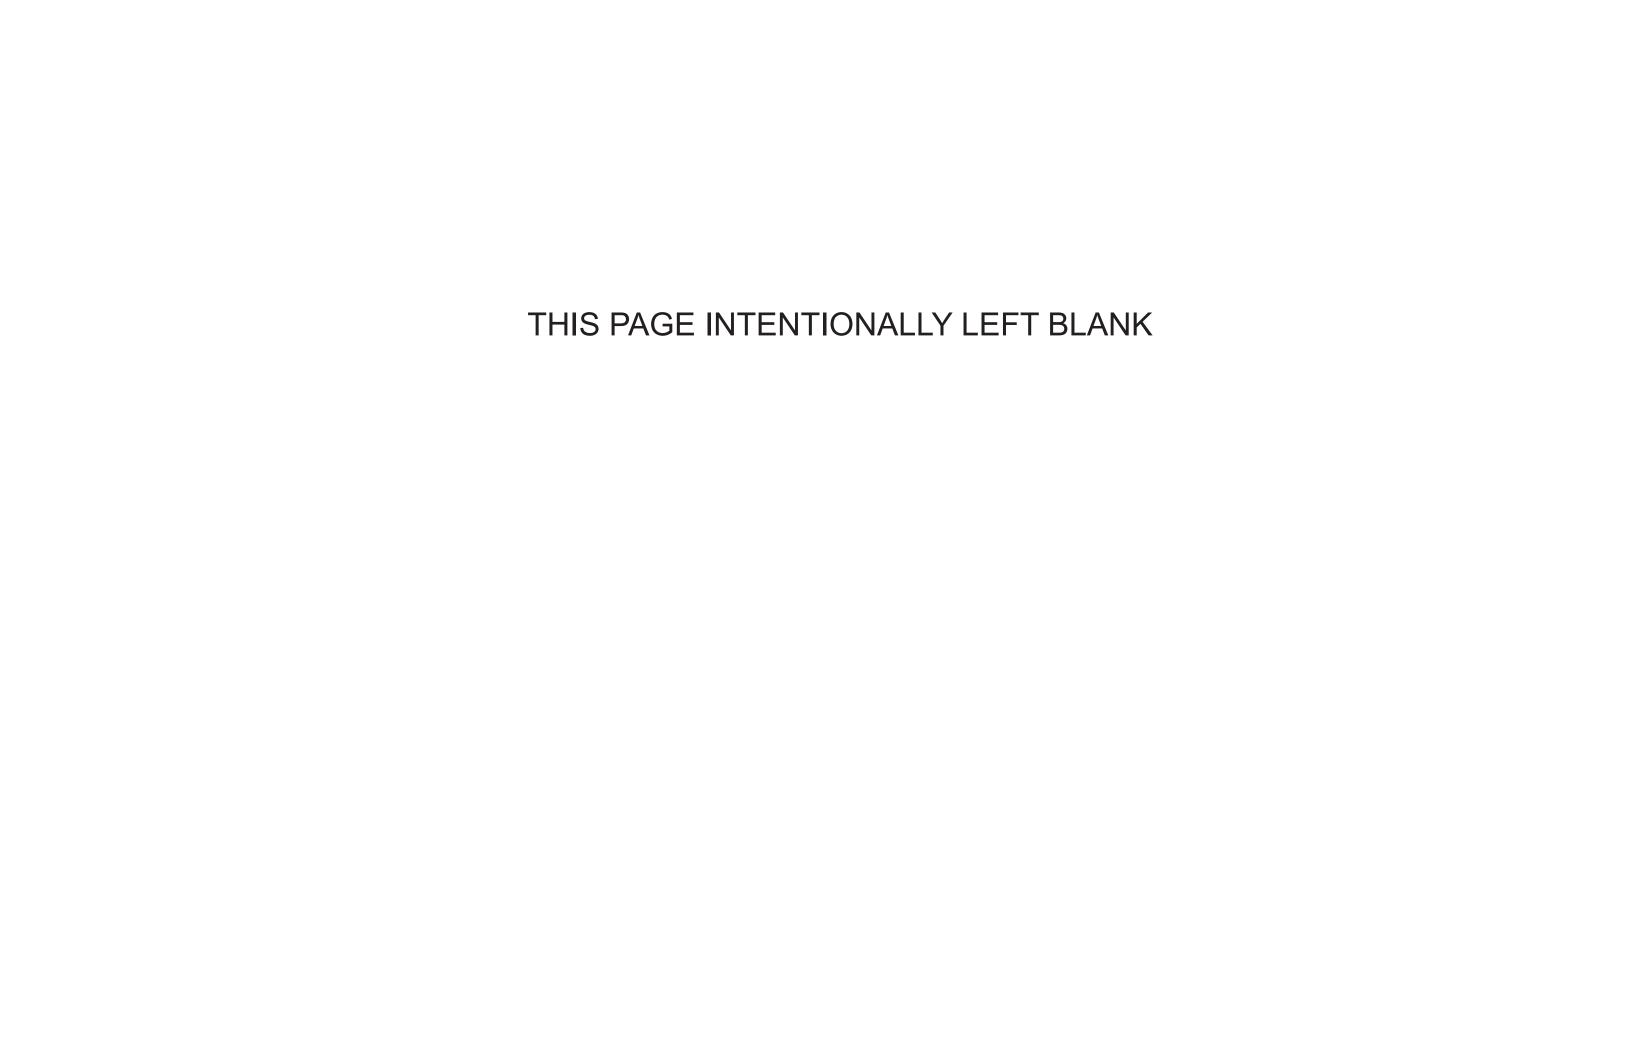

STANDARD DRAWING LEGEND

FOR ENTIRE PLAN SET

	(SCALE)		
TYPICAL NOTE TEXT	PROPOSED NOTE	EXISTING NOTE	TYPICAL NOTE TEXT	PROPOSED NOTE
ONSITE PROPERTY LINE / R.O.W. LINE		OH	_ OVERHEAD WIRE	ОН
NEIGHBORING PROPERTY LINE / INTERIOR PARCEL LINE			_ UNDERGROUND TELEPHONE LINE	Т
EASEMENT LINE			UNDERGROUND CABLE LINE	с-
SETBACK LINE		======	STORM SEWER	
		S	SANITARY SEWER MAIN	s
	CURB AND GUTTER	~	HYDRANT	٧
CONCRETE CURB & GUTTER		(<u>S</u>)	SANITARY MANHOLE	(6)
	DEPRESSED CURB AND GUTTE	(D)	STORM MANHOLE	(
UTILITY POLE WITH LIGHT		⊗ ^{WM}	WATER METER	•
POLE LIGHT		₩V	WATER VALVE	•
TRAFFIC LIGHT	□ €		GAS VALVE	
UTILITY POLE	0	\boxtimes	GAS METER	\boxtimes
TYPICAL LIGHT	<u> </u>		TYPICAL END SECTION	Δ
ACORN LIGHT	¢	>1	HEADWALL OR ENDWALL	OR
TYPICAL SIGN	-v	()	YARD INLET	
PARKING COUNTS	À	©	CURB INLET	©
		0	CLEAN OUT	0
CONTOUR LINE	<u>190</u>	E	ELECTRIC MANHOLE	E
SPOT ELEVATIONS		7	TELEPHONE MANHOLE	T
	•	EB	ELECTRIC BOX	EB
SANITARY LABEL	SAN #	EP	ELECTRIC PEDESTAL	EP
STORM LABEL	$\overline{\hat{\mathbb{X}}}$		MONITORING WELL	
SANITARY SEWER LATERAL	SL		TEST PIT	-
UNDERGROUND WATER LINE			BENCHMARK	
UNDERGROUND ELECTRIC LINE	Е	→	BORING	◆
UNDERGROUND GAS LINE	G			
	ONSITE PROPERTY LINE / R.O.W. LINE NEIGHBORING PROPERTY LINE / INTERIOR PARCEL LINE EASEMENT LINE SETBACK LINE CONCRETE CURB & GUTTER UTILITY POLE WITH LIGHT TRAFFIC LIGHT TRAFFIC LIGHT TYPICAL LIGHT TYPICAL SIGN PARKING COUNTS CONTOUR LINE SPOT ELEVATIONS SANITARY LABEL SANITARY SEWER LATERAL UNDERGROUND WATER LINE UNDERGROUND ELECTRIC LINE UNDERGROUND	ONSITE PROPERTY LINE / R.O.W. LINE NEIGHBORING PROPERTY LINE / INTERIOR PARCEL LINE EASEMENT LINE CONCRETE CURB & GUTTER CURB AND GUTTER SPILL CURB TRANSITION CUR DEPRESSED CURB AND GUTTE SPILL CURB TRANSITION CUR DEPRESSED CURB AND GUTTE TRAFFIC LIGHT UTILITY POLE WITH LIGHT TRAFFIC LIGHT UTILITY POLE LIGHT ACORN LIGHT TYPICAL LIGHT TYPICAL SIGN PARKING COUNTS CONTOUR LINE CONTOUR LINE SPOT ELEVATIONS SANITARY LABEL SANITARY LABEL SANITARY SEWER LATERAL UNDERGROUND WATER LINE UNDERGROUND UNDERGROUND ELECTRIC LINE UNDERGROUND UNDERGROUND ELECTRIC LINE UNDERGROUND UNDERGROUND	ONSITE PROPERTY LINE / R.O.W. LINE NEIGHBOURING PROPERTY LINE / INTERIOR PRACE LINE SETBACK LINE CONCRETE CURB & GUTTER CONCRETE CURB & GUTTER CONCRETE CURB & GUTTER SPILL CURB TRANSITION CURB SPILL CURB AND GUTTER OPERESSED CURB AND GUTTER UTILITY POLE WITH LIGHT POLE LIGHT UTILITY POLE LIGHT TAFFIC LIGHT ACORN LIGHT ACORN LIGHT TYPICAL LIGHT TYPICAL SIGN PARKING COUNTS CONTOUR LINE SPOT ELEVATIONS SANITARY LABEL SANITARY LABEL SANITARY LABEL SANITARY SEWER LATERAL UNDERGROUND WATER LINE UNDERGROUND WATER LINE UNDERGROUND WATER LINE UNDERGROUND LINE LIGHT LIGHT	ONSTEPROPERTY LINE / R.O.W. LINE WEIGHBORING INTERIOR PARCEL LINE EASEMENT LINE EASEMENT LINE CONCRETE CURB & GUITER SPILL CURB TRANSITION CURB SANITARY SEVER MAIN CONCRETE CURB & GUITER SPILL CURB TRANSITION CURB SANITARY MANHOLE MANHOLE MATER METER TO MANHOLE MATER METER WY MATER MATER MANHOLE LIGHT UTILITY POLE LIGHT UTILITY O GAS VALVE GAS TYPICAL LIGHT ACORN LIGHT ACORN LIGHT TYPICAL LIGHT ACORN LIGHT TYPICAL SIGN ACORN LIGHT ACORN LIGHT TYPICAL SIGN ACORN LIGHT TYPICAL SIGN ACORN LIGHT ACORN LIGHT TYPICAL SIGN ACORN LIGHT ACORN LIGHT ACORN LIGHT ACORN LIGHT TYPICAL SIGN ACORN LIGHT ACORN LIG

GENERAL NOTES:

- 1. THE PLAN IS BASED ON THE FOLLOWING DOCUMENTS AND INFORMATION
 - A. ENTITLED: "ALTA/ACSM LAND TITLE SURVEY, THE HANOVER COMPANY, LOT 15, SQUARE 3382 AND A&T LOT 804, SQUARE 3835, 3201 & 3135 8TH STREET NE, DISTRICT OF COLUMBIA", PREPARED BY: BOHLER ENGINEERING, PROJECT NUMBER: SRW182079, DATED: 08/19/18
 - B. DIGITAL ARCHITECTURAL PLANS: ENTITLED: "180430 SPv28.5.DWG," PREPARED BY: KTGY ARCHITECTS, DATE RECEIVED: 03/05/19
 - C. DIGITAL LANDSCAPE PLANS: ENTITLED: "WSP-BROOKLAND-GROUND.DWG," PREPARED BY: GWH LANDSCAPE ARCHITECTS, DATE RECEIVED: 03/20/19
- 2. LOCATION OF ALL UNDERGROUND UTILITIES ARE APPROXIMATE. ALL LOCATIONS AND SIZES ARE BASED ON UTILITY MARK OUTS, ABOVE GROUND STRUCTURES THAT WERE VISIBLE & ACCESSIBLE IN THE FIELD, AND THE MAPS AS LISTED IN THE REFERENCES AVAILABLE AT THE TIME OF THE SURVEY. AVAILABLE AS-BUILT PLANS AND UTILITY MARK OUT DOES NOT ENSURE MAPPING OF ALL UNDERGROUND UTILITIES AND STRUCTURES. BEFORE ANY EXCAVATION IS TO BEGIN, ALL UNDERGROUND UTILITIES SHOULD BE VERIFIED AS TO THEIR LOCATION, SIZE, AND TYPE BY THE PROPER UTILITY COMPANIES.

SHEET INDEX	
SHEET TITLE	SHEET NUMBER
GENERAL NOTES AND LEGEND	C-101
EXISTING CONDITIONS PLAN	C-201
SITE PLAN	C-301
GRADING PLAN	C-401
UTILITY PLAN	C-501
EROSION AND SEDIMENT CONTROL PLAN	C-601
EROSION AND SEDIMENT CONTROL PLAN NOTES AND DETAILS	C-602
PUBLIC SPACE PLAN	C-701-702
VEHICULAR TURNING MOVEMENTS (BY OTHERS)	C-801
STORMWATER MANAGEMENT PLAN	C-901-902
STORMWATER MANAGEMENT CALCULATIONS AND DETAILS	C-904


DEVELOPER

THE HANOVER COMPANY CORPORATE OFFICE 5847 SAN FELIPE, SUITE 3600 HOUSTON, TX 77057


GENERAL NOTES AND LEGEND






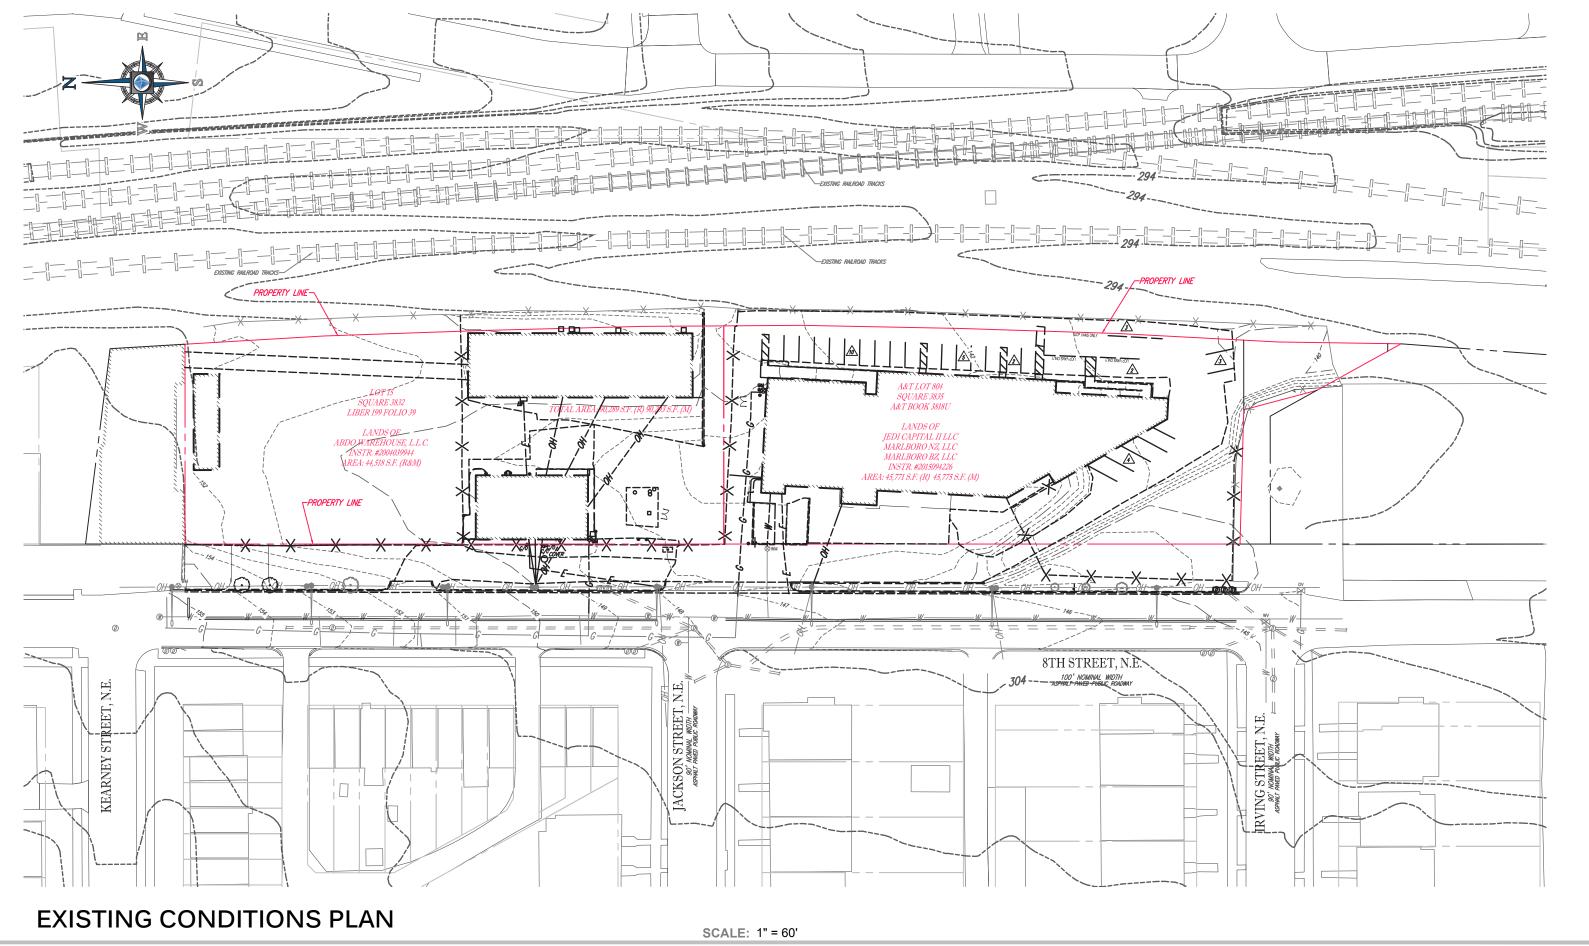





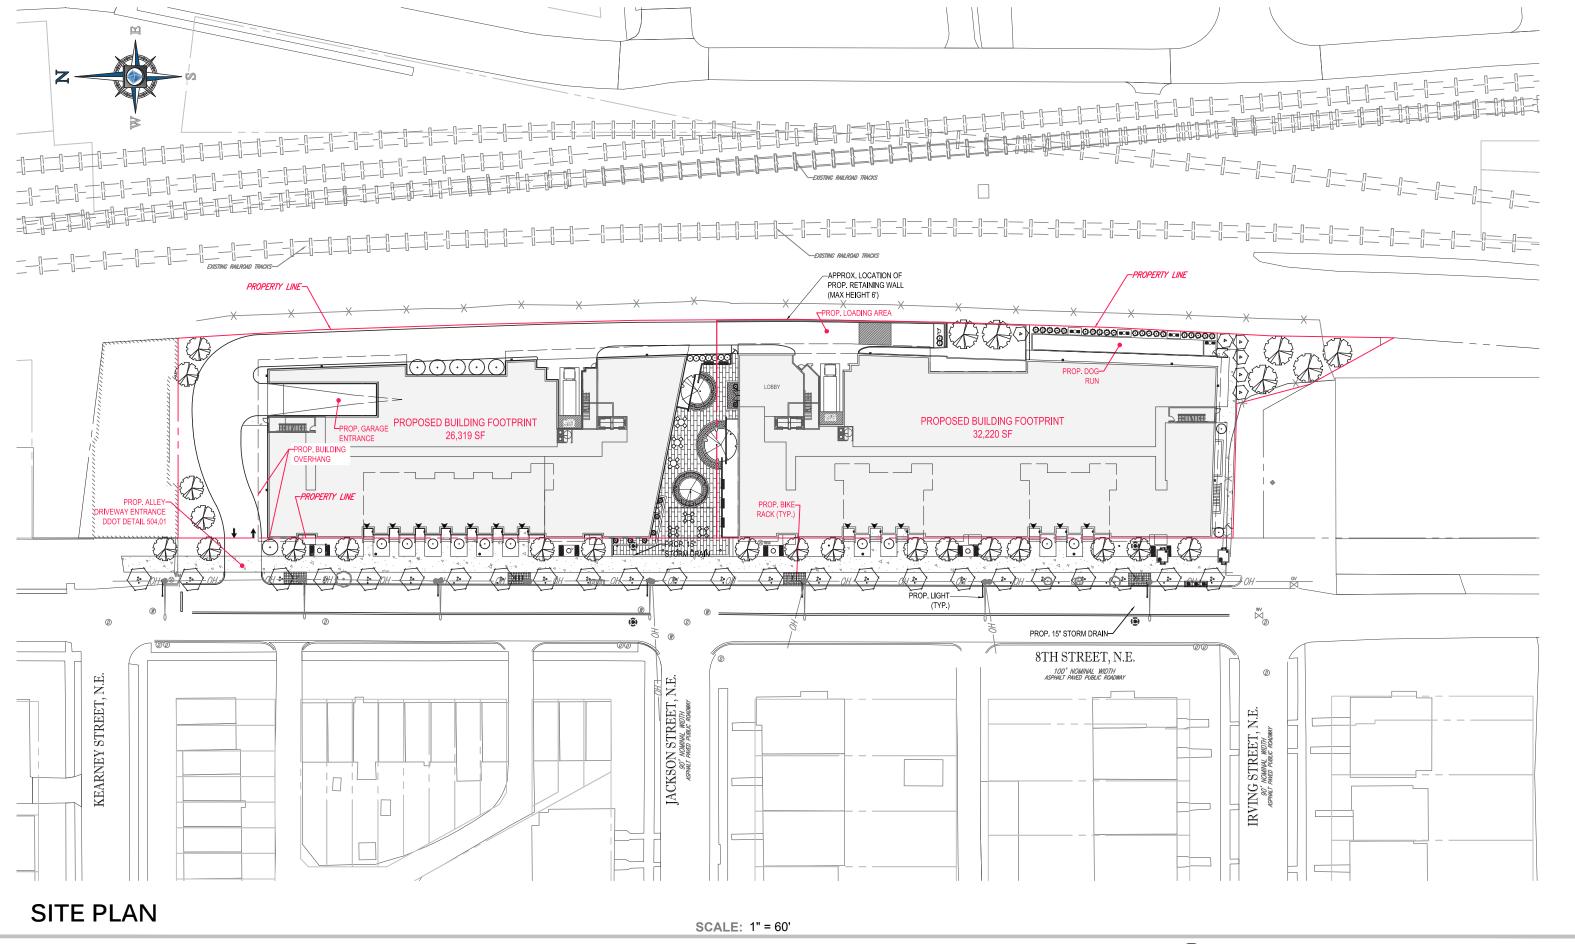




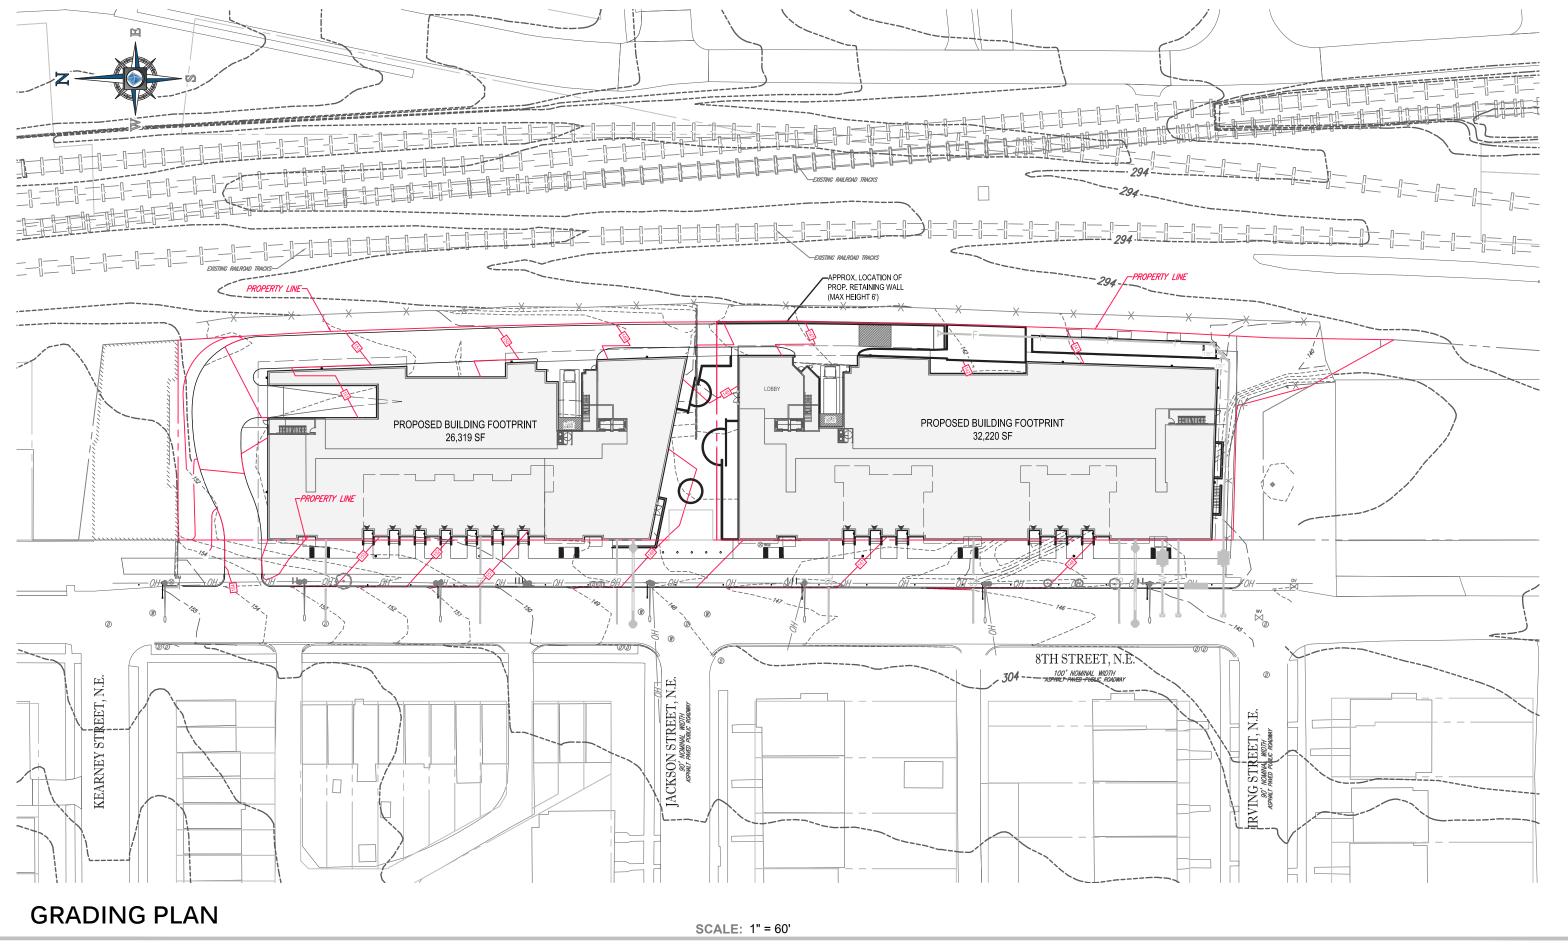


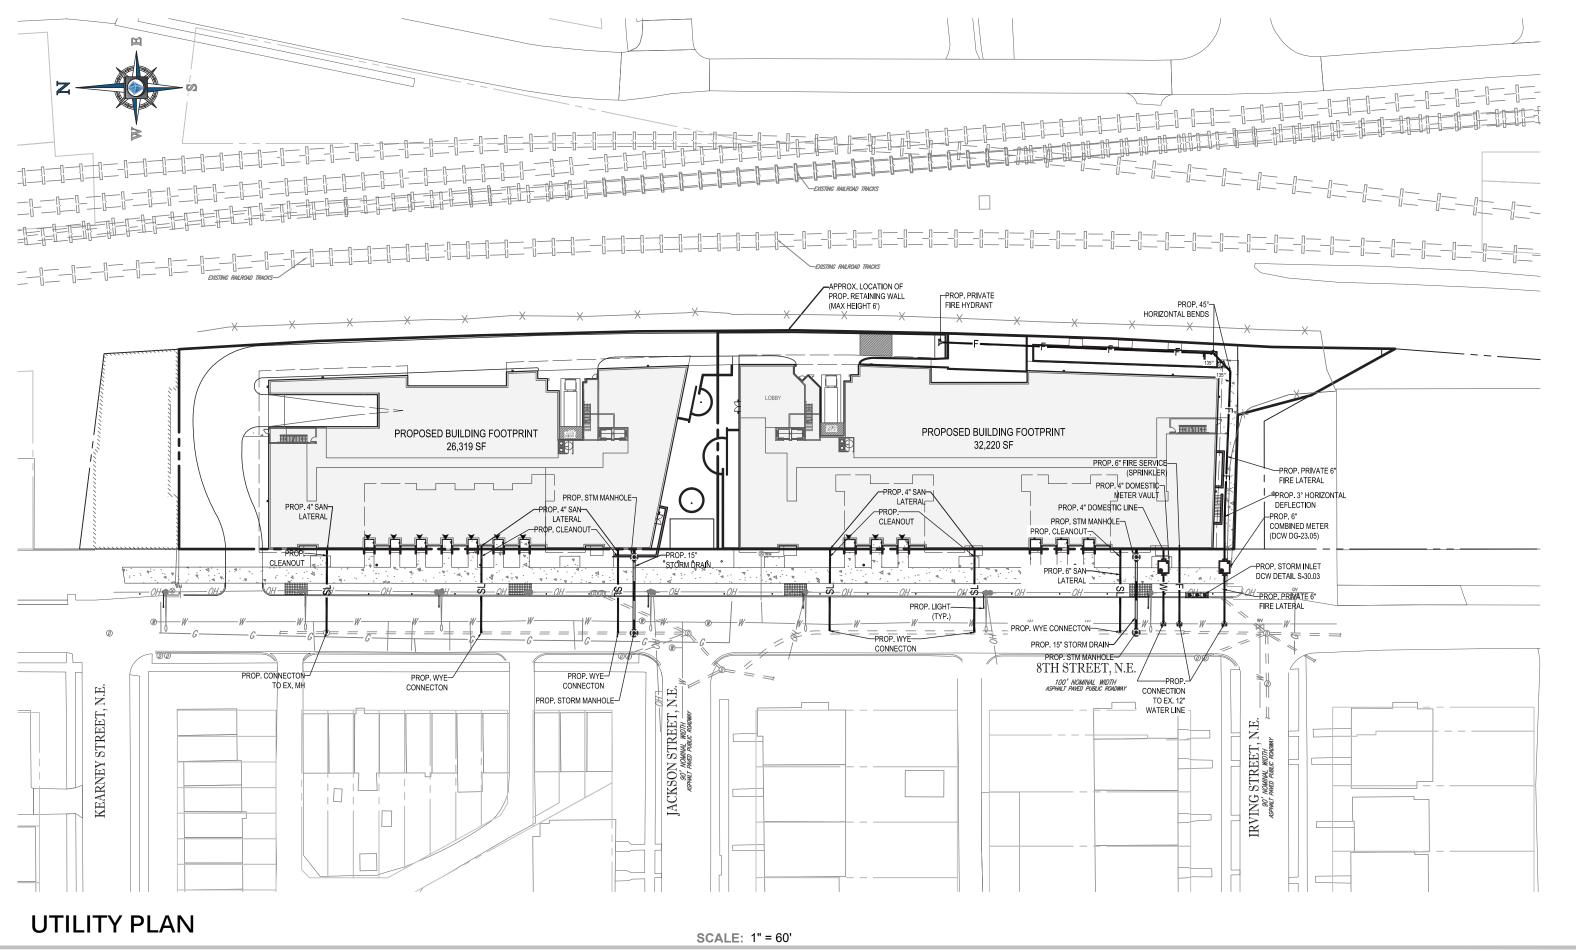


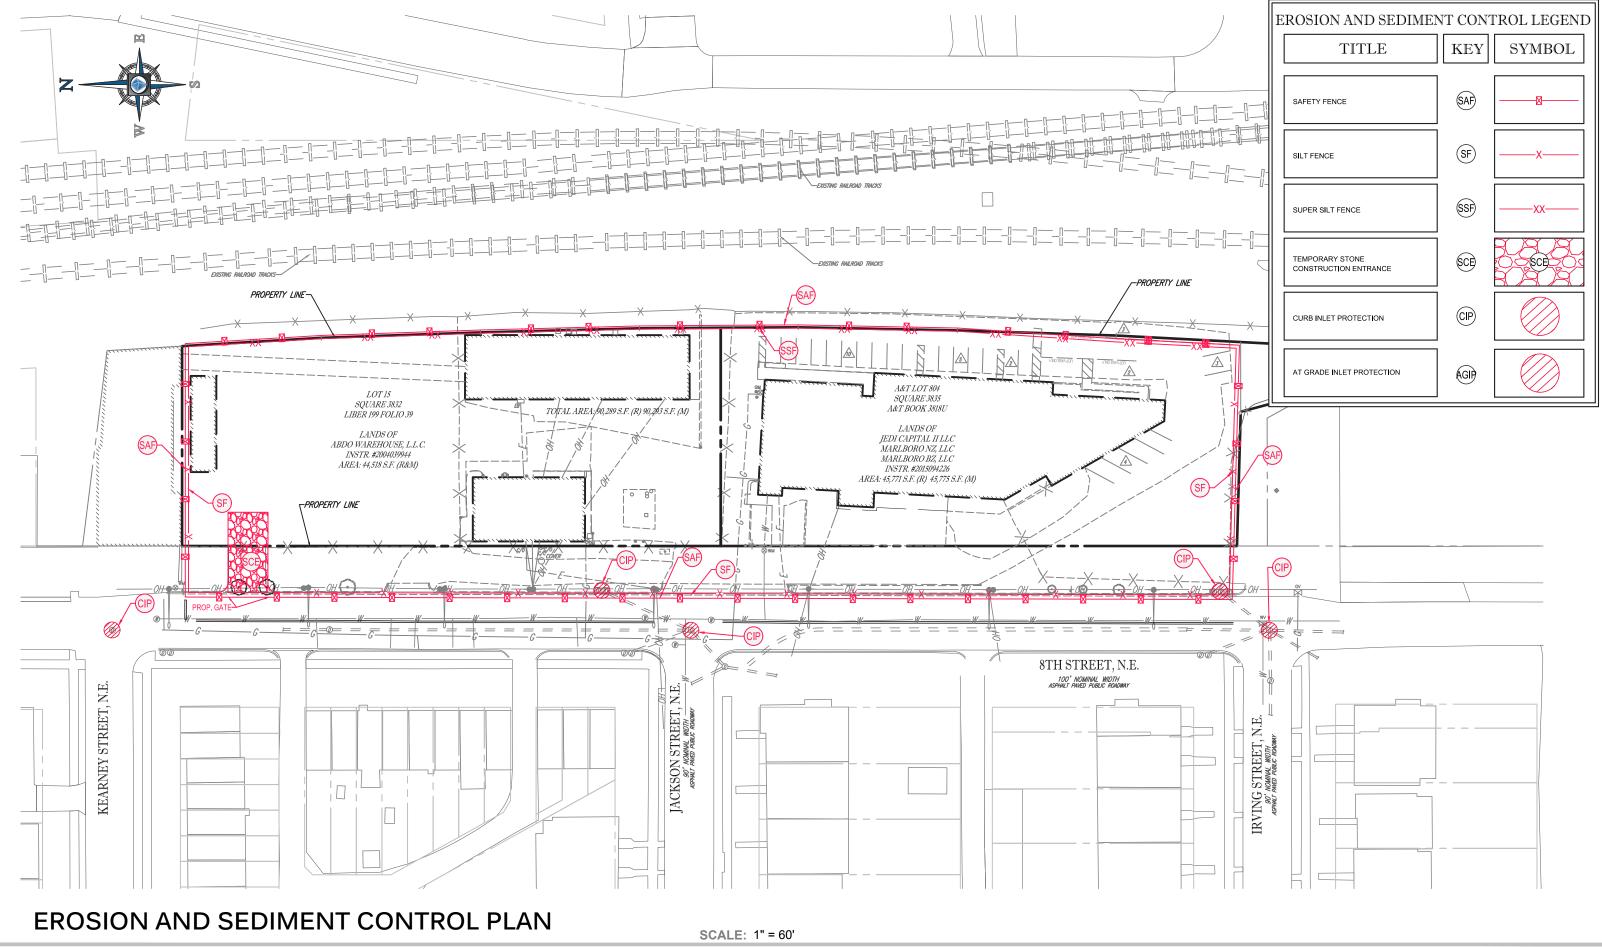





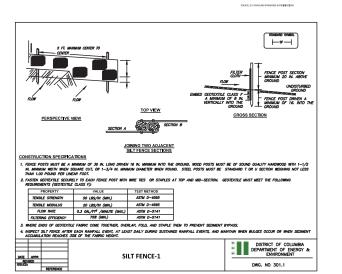


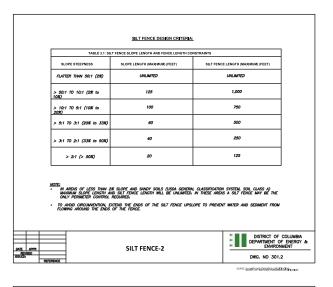


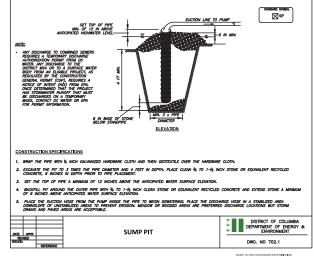


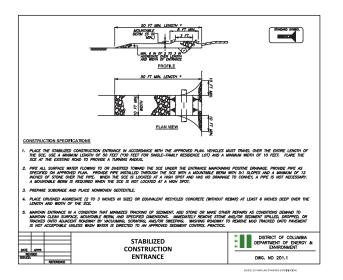


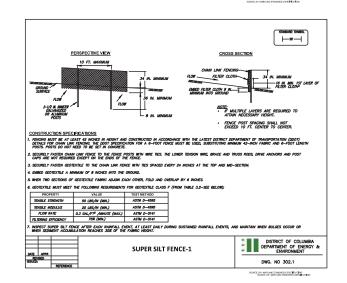


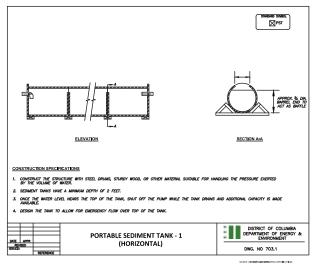

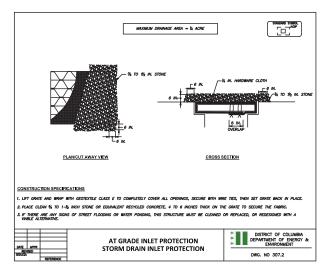

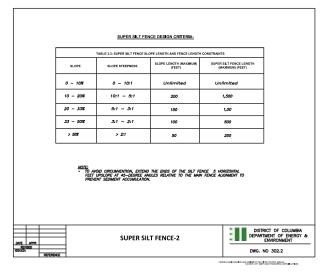

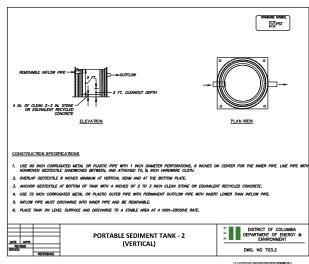


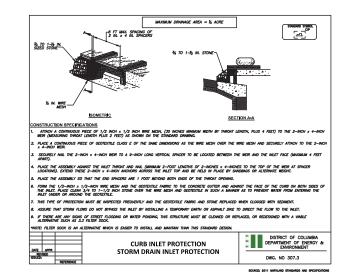

EROSION AND SEDIMENT CONTROL NOTES AND DETAILS





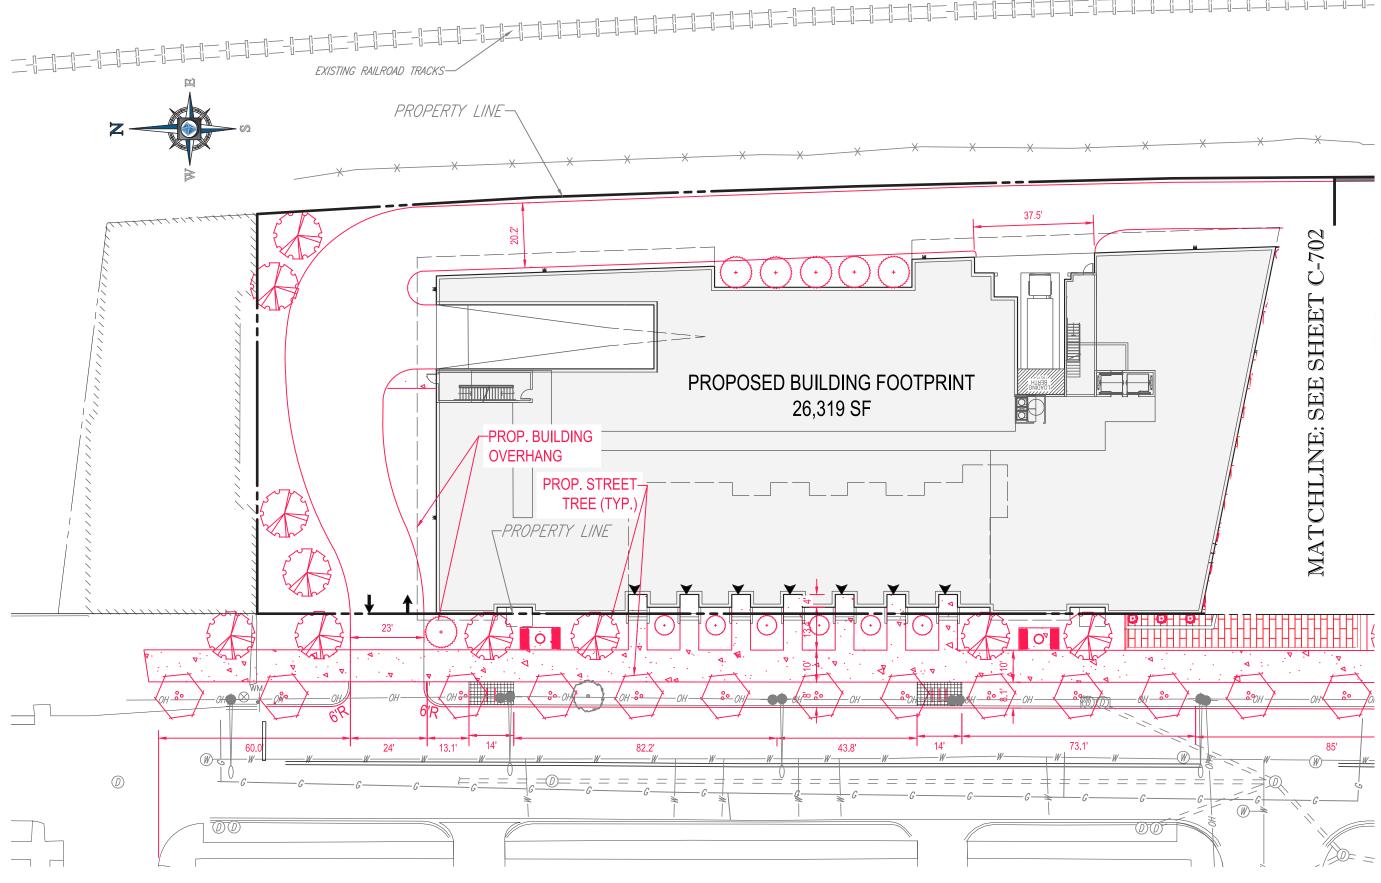


PUBLIC SPACE PLAN

SCALE: 1" = 30"






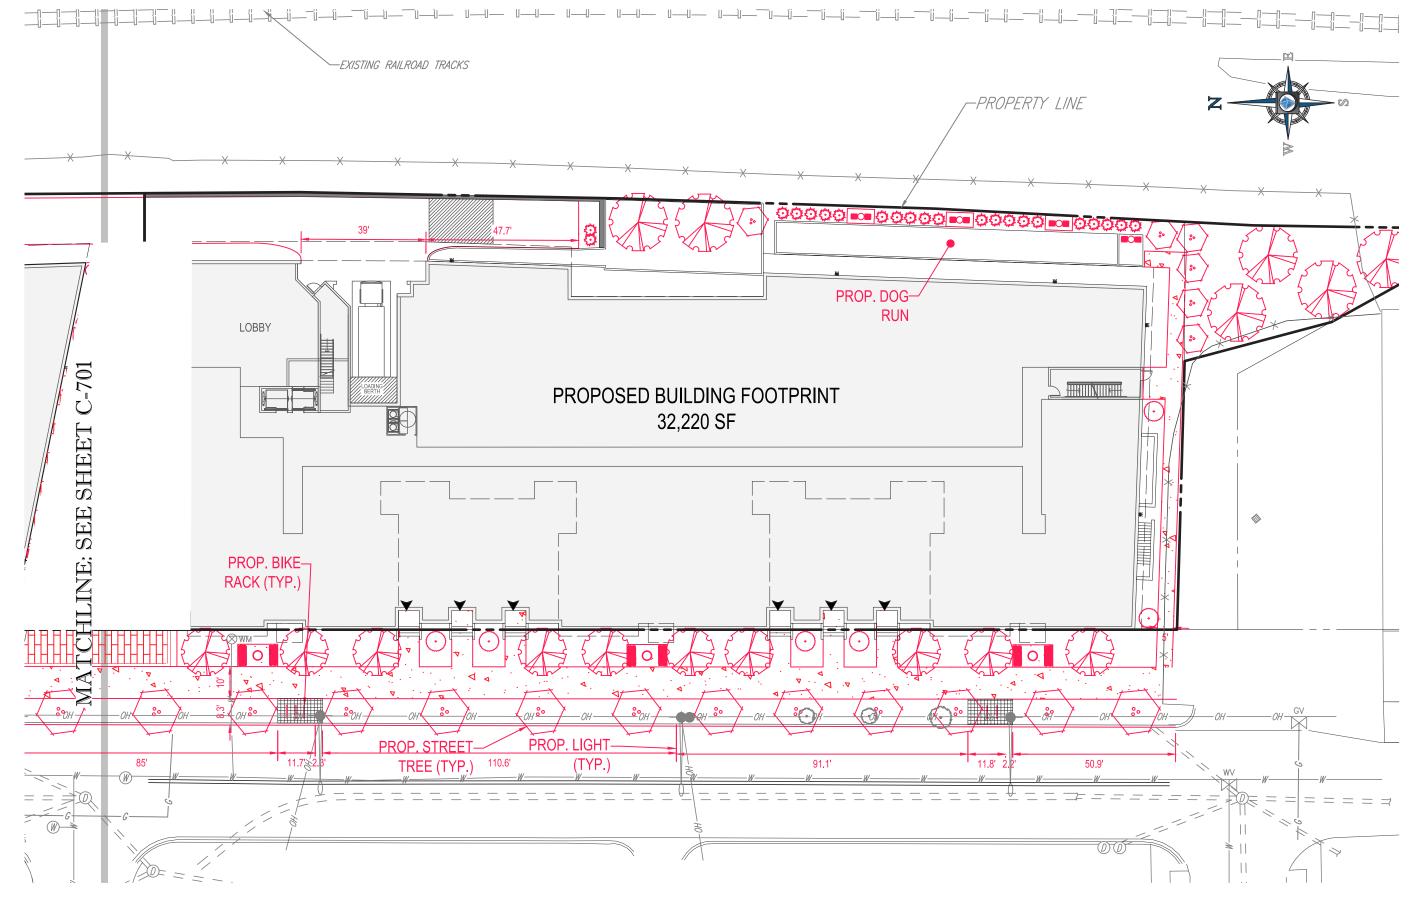

PUBLIC SPACE PLAN

SCALE: 1" = 30"



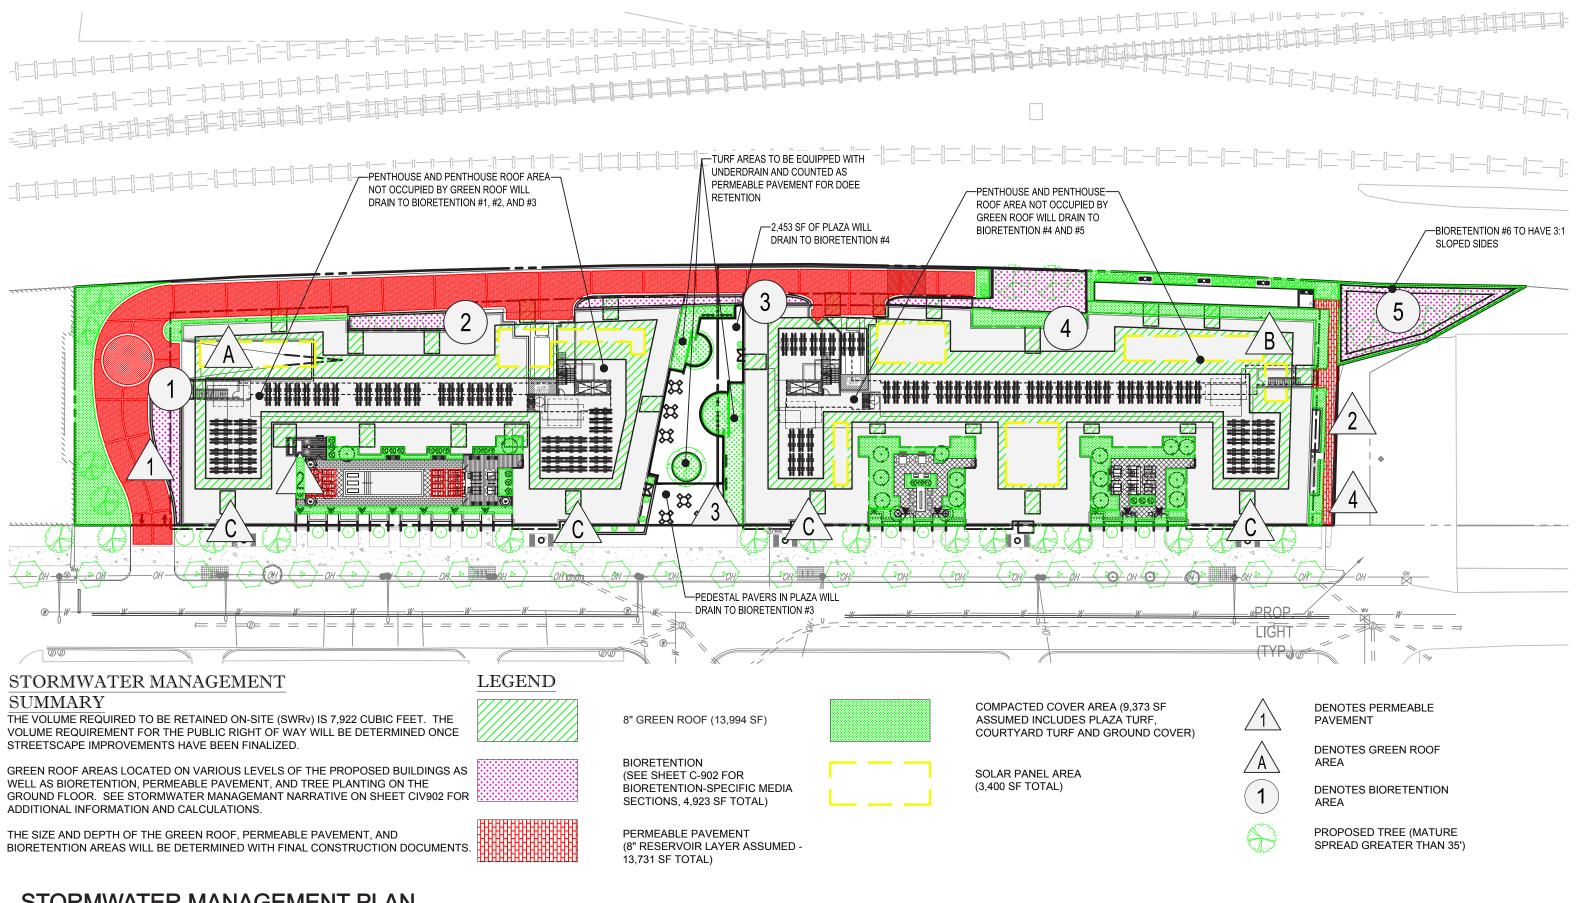

STORMWATER MANAGEMENT PLAN

SCALE: 1" = 60'





GREEN ROOF TABLE:

					DRAINAGE					
	SURFACE	TOTAL	PROP. IMP	MEDIA DEPTH	LAYER		STORAGE			
GREEN ROOF#	AREA (SF)	CDA (SF)	(SF)	(in.)	DEPTH (IN)	LOCATION	PROVIDED	Max SWRv	SWRv PROVIDED	NOTES
Α	5,175	5,175	5,175	8	1		1617	696	696	NORTH ROOF
В	6,212	6,212	6,212	8	1		1941	836	836	SOUTH ROOF
С	2,607	2,607	2,607	8	1		815	351	351	COMBO PENTHOUSE GR
						TOTAL	4,373	1,883	1,883	

MEDIA RETENTION VALUE	0.45
DRAINAGE LAYER RETENTION VALUE	0.15

PERMEABLE PAVEMENT TABLE:

FACILITY	SA (SF)	SWRv (CF)	Storage (CF)	Gravel D(ft)
1	10,999	495	2579	0.67
2	448	20	105	0.67
3	1,581	71	371	0.67
4	703	32	165	0.67
Total	13,731	618	3220	

BIORETENTION TABLE:

	SURFACE	SURFACE											
	AREA,	AREA, TOP	TOTAL CDA	PROP. IMP	PROP. PERV		PONDING DEPTH	MEDIA DEPTH	GRAVEL DEPTH				
FACILITY	BOT. (SF)	(SF)	(SF)	(SF)	(SF)	FREEBOARD (FT)	(FT)	(FT)	(FT)	STORAGE PROVIDED	SWRv (CF)	Max SWRv	SWRv PROVIDED
1	638	638	6,656	6,018	0	0.25	1	3.5	1	1,451	871	896	871
2	446	446	3,455	3,009	0	0.25	1	1.5	1	792	475	465	465
3	464	464	9,881	9,417	0	0.25	1	3.0	1	998	599	1,330	599
4	1,278	1,278	11,330	10,052	0	0.25	1	3.0	1	2,748	1,649	1,525	1,525
5	1,461	2,097	13,847	11,398	352	0.5	1	2.0	1	3,094	1,856	1,829	1,829
									TOTAL	9,082	5,449	6,044	5,288

TREE PLANTING TABLE:

Activity	Trees	SWRv (CF)	Storage
tree planting (evergreen			
screening)	14	140	0

SUMMARY

SWRv REQUIRED = 7,922 CF SWRv PROVIDED = 7,929 CF

STORAGE REQUIRED = 13,880 CF STORAGE PROVIDED = 16,675 CF

STORMWATER MANAGEMENT PLAN



GAR SCORESHEET



GAR SCORESHEET

*	* Address 3135 8th Street, NE		Se	quare			Lot	Scoreshe Zone District
			383	2, 38	35		15, 804	MU-4
	Other		Lot area (sf)	9	Viinimum Score		Multiplier	GAR Score
	Lotsize (enter this value first) *	Γ	90,293	T	0.3		SCORE:	0.3
	Landscape Elements				Square Feet	Factor		4
A	Landscaped areas (select one of the following for eac	h ar	ea)					
1	Landscaped areas with a soil depth < 24"			Г	square feet	0.30		
2	Landscaped areas with a soil depth ≥ 24"			Г	square feet 9,373	0.60		5,62
3	Bioretention facilities			Г	square feet 4,923	0.40		1,969
В	Plantings (credit for plants in landscaped areas from !	Sect	ion A)				Native Bonus	
1	Groundcovers, or other plants < 2' height		•	г	square feet	0.20	square feet	100
2	Plants ≥ 2' height at maturity	Г	# of plants	ī	4500	0.30	# of plants	1,350
7	- calculated at 9-sf per plant	-		-		3,72		2,55
3	New trees with less than 40-foot can opy spread - calculated at 50 sq ft per tree		# of trees		700	0.50	# of trees	350
4	New trees with 40-foot or greater canopy spread - calculated at 250 sq ft per tree		# of trees	J	q	0.60	# of trees	
5	Preservation of existing tree 6" to 12" DBH - calculated at 250 sq ft per tree		# of trees	J	q	0.70	# of trees	
6	Preservation of existing tree 12" to 18" DBH - calculated at 600 sq ft per tree		# of trees		0	0.70	# of trees	
7	Preservation of existing trees 18" to 24" DBH - calculated at 1300 sq ft per tree		# of trees]	à	0.70	# of trees	
8	Preservation of existing trees 24" DBH or greater - calculated at 2000 sq ft per tree		# of trees]	0	0.80	# of trees	
9	Vegetated wall, plantings on a vertical surface			Е	square feet	0.60	squase feet	
c	Vegetated or "green" roofs							
1	Over at least 2" and less than 8" of growth medium			Г	squore feet	0.60	square feet	
2	Over at least 8" of growth medium			Г	square feet 13,994	0.80	square feet	11,19
D	Permeable Paving***						-	
1	Permeable paving over 6" to 24" of soil or gravel			Г	square feet 13,731	0.40		5,49
2	Permeable paving over at least 24" of soil or grave			Г	square feet	0.50		× 1×2
E	Other			S. T.	.115			
1	Enhanced tree growth systems***			Г	square feet	0.40		
2	Renewable energy generation			Г	square feet	0.50		1,700
3	Approved water features			Г	square feet	0.20		(750)(7)
	- And American Strategical Section attention	99	sub-total of sq fi	-	51,121	-		
F	Bonuses							
1	Native plant species				square feet O square feet	0.10		
2	Landscaping in food cultivation					0.10		
3	Harvested stormwater irrigation				square feet	0.10		
Porm	ne able paving and structural soil together may not qualify for more than on	e thir	d of the Green		reen Area Ratio nu Ratio score	nerotar	-	27,