ZONING COMMISSION District of Columbia CASE NO.15-27 EXHIBIT NO.14A9



CIVIL

R2L:ARCHITECTS

GENERAL NOTES AND LEGEND

R2L:ARCHITECTS BOHLER

		FOR ENTIRE (NOT TO			
EXISTING NOTE	TYPICAL NOTE TEXT	PROPOSED NOTE	EXISTING NOTE	TYPICAL NOTE TEXT	PROPOSED NOTE
 _ _ _	ONSITE PROPERTY LINE / R.O.W. LINE		OH	_ OVERHEAD WIRE	ОН
	NEIGHBORING PROPERTY LINE / INTERIOR PARCEL LINE		<i>T</i>	UNDERGROUND	T
	EASEMENT LINE		C	UNDERGROUND CABLE LINE	c
	SETBACK LINE		= = = = = = = =	STORM SEWER	
			<i>S</i>	_ SANITARY SEWER MAIN	\$
		CURB AND GUTTER	v	HYDRANT	σ
	CONCRETE CURB & GUTTER	SPILL CURB TRANSITION CURB	S	SANITARY MANHOLE	\bigcirc
		DEPRESSED CURB AND GUTTER	\bigcirc	STORM MANHOLE	
+	UTILITY POLE WITH LIGHT		⊗ ^{WM}	WATER METER	0
c	POLE LIGHT	 >	××	WATER VALVE	•
D€	TRAFFIC LIGHT	₽€		GAS VALVE	
0	UTILITY POLE	0	\boxtimes	GAS METER	\boxtimes
ð	TYPICAL LIGHT	ð	Д	TYPICAL END SECTION	Д
¢	ACORN LIGHT	¢	a	HEADWALL OR ENDWALL	
	TYPICAL SIGN	_ v _	(<u>)</u>)	YARD INLET	
\bigtriangleup	PARKING COUNTS	\bigwedge	O	CURB INLET	Ø
			0	CLEAN OUT	0
<i>170</i>	CONTOUR LINE	<u>[190]</u> [187]	Ē	ELECTRIC MANHOLE	Ē
TC 516.4 OR 516.4	SPOT ELEVATIONS	TC 516.00 BC 515.55	$\overline{(7)}$	TELEPHONE MANHOLE	Ū
	<u> </u>	•	EB	ELECTRIC BOX	EB
SAN #	SANITARY LABEL	SAN #	EP	ELECTRIC PEDESTAL	EP
	STORM LABEL		\bigcirc	MONITORING WELL	\bigcirc
	SANITARY SEWER LATERAL	SL	F	TEST PIT	.
W	UNDERGROUND WATER LINE	W		BENCHMARK	
£	UNDERGROUND ELECTRIC LINE	E	\bullet	BORING	\bullet
G	UNDERGROUND GAS LINE	G			

DC

STANDARD DRAWING LEGEND

FOR ENTIRE PLAN SET

GENERAL NOTES:

- 1. THE PLAN IS BASED ON THE FOLLOWING DOCUMENTS AND INFORMATION
 - Α. DC142264, DATED: 2/26/15
 - В. ARCHITECTS, DATE RECEIVED: 10/01/15.
 - C. PREPARED BY: OCULUS, DATE RECEIVED: 10/13/15
- AND TYPE BY THE PROPER UTILITY COMPANIES.

SHEET INDEX				
SHEET TITLE	SHEET NUMBER			
GENERAL NOTES AND LEGEND	C-100			
DEMOLITION PLAN	C-101			
SITE PLAN - CONSOLIDATED STAGE PUD	C-200			
SITE PLAN - CONSOLIDATED AND FIRST STAGE PUD	C-201			
UTILITY PLAN	C-300			
EROSION AND SEDIMENT CONTROL PLAN CONSOLIDATED STAGE PUD (CONSTRUCTION PHASE I)	C-301			
EROSION AND SEDIMENT CONTROL PLAN CONSOLIDATED STAGE PUD (CONSTRUCTION PHASE II)	C-401			
STORMWATER MANAGEMENT PLAN - OVERALL	C-500			
STORMWATER MANAGMENT PLAN CALCULATIONS - OVERALL	C-501			
STORMWATER MANAGEMENT PLAN - PUD PHASING	C-502			

KETTLER INC.

ENTITLED: "ALTA/ACSM LAND TITLE SURVEY, KETTLER INC., 300 MORSE STREET, NE, A&T LOTS 805, 817, & 819, SQUARE 3587, DISTRICT OF COLUMBIA", PREPARED BY: BOHLER ENGINEERING, PROJECT NUMBER:

DIGITAL ARCHITECTURAL PLANS: ENTITLED: "SONYA - GROUNDFLOOR PLAN.DWG" PREPARED BY: R2L

DIGITAL LANDSCAPE PLANS: ENTITLED: "L-SP-W1511.DWG" AND "L-SP-W1511_PHASE 1.DWG"


2. LOCATION OF ALL UNDERGROUND UTILITIES ARE APPROXIMATE. ALL LOCATIONS AND SIZES ARE BASED ON UTILITY MARK OUTS, ABOVE GROUND STRUCTURES THAT WERE VISIBLE & ACCESSIBLE IN THE FIELD, AND THE MAPS AS LISTED IN THE REFERENCES AVAILABLE AT THE TIME OF THE SURVEY. AVAILABLE AS-BUILT PLANS AND UTILITY MARK OUT DOES NOT ENSURE MAPPING OF ALL UNDERGROUND UTILITIES AND STRUCTURES. BEFORE ANY EXCAVATION IS TO BEGIN, ALL UNDERGROUND UTILITIES SHOULD BE VERIFIED AS TO THEIR LOCATION, SIZE,


DEVELOPER

1751 PINNACLE DR. #700 MCLEAN, VA 22102



15 January, 2016

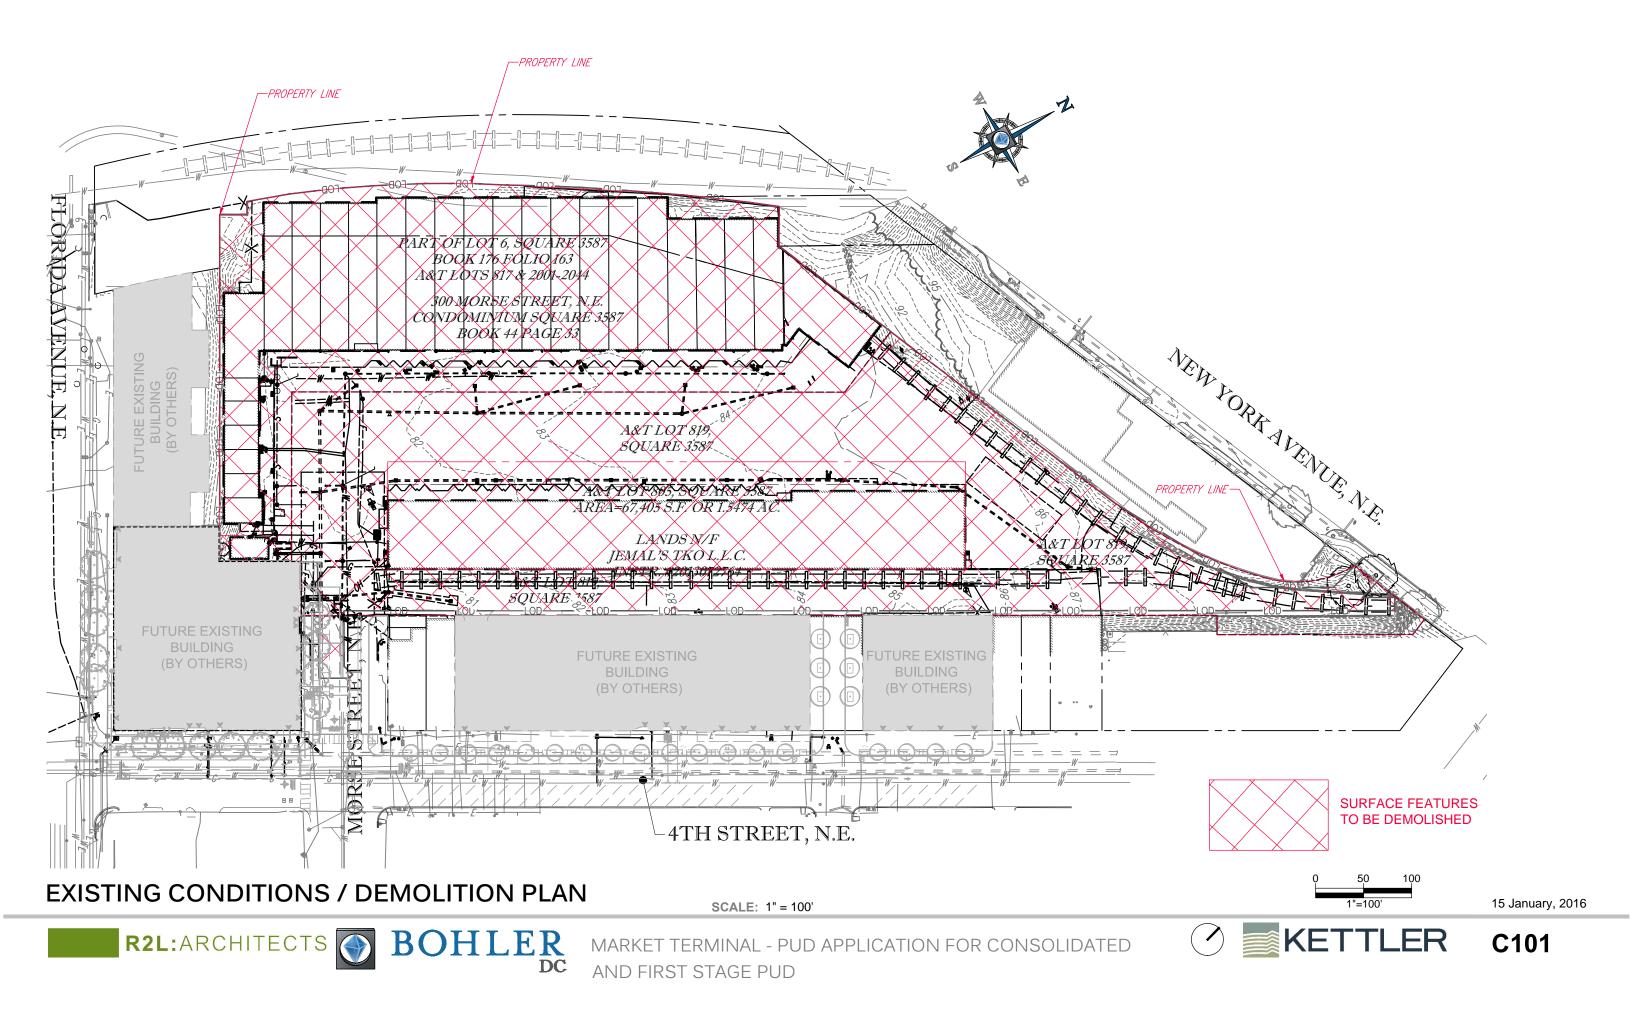

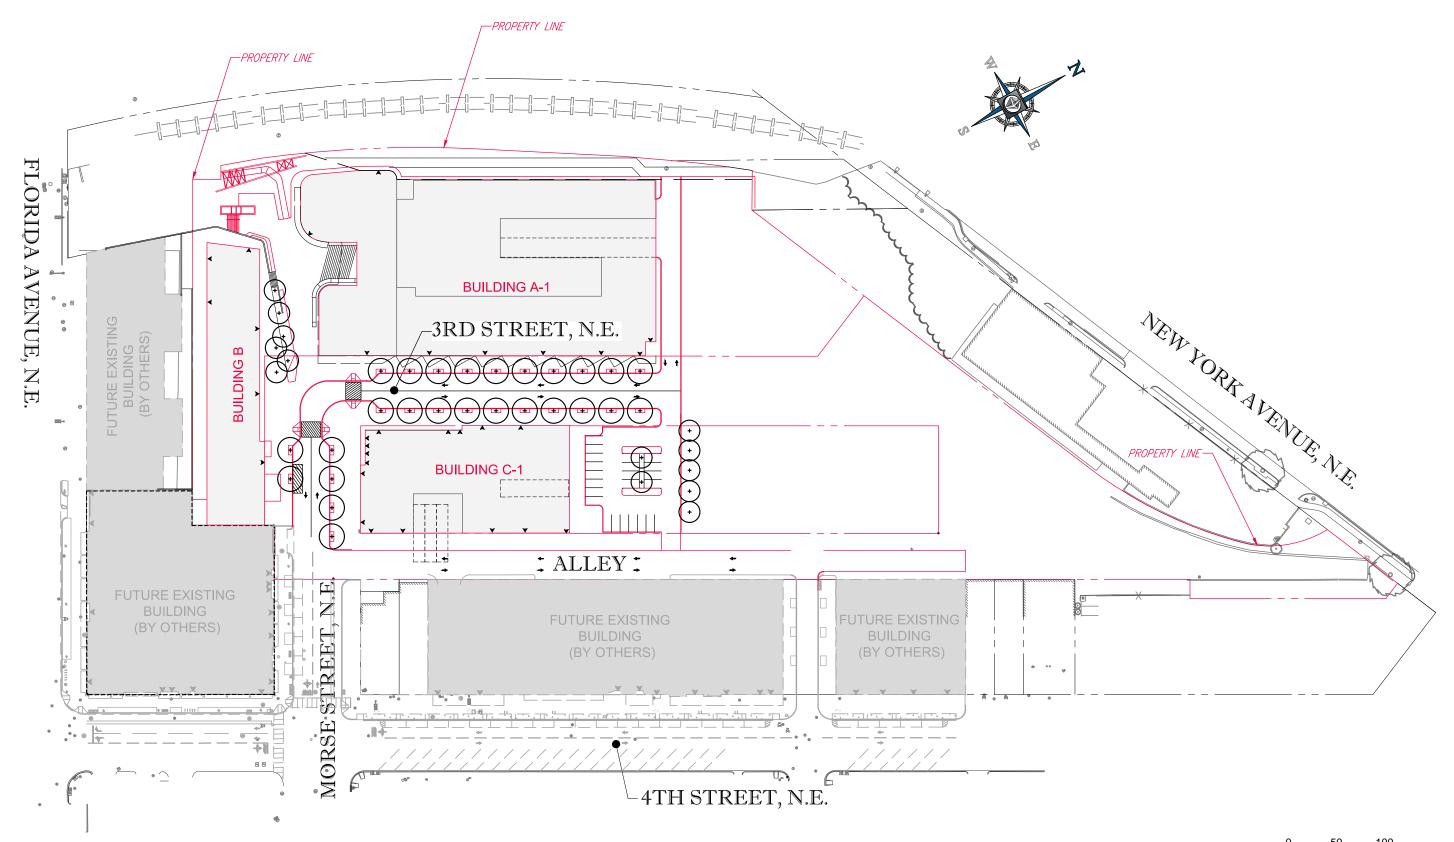


SITE PLAN - CONSOLIDATED STAGE PUD R2L:ARCHITECTS S BOHLER DC

SCALE: 1" = 100'

MARKET TERMINAL - PUD APPLICATION FOR CONSOLIDATED AND FIRST STAGE PUD



15 January, 2016

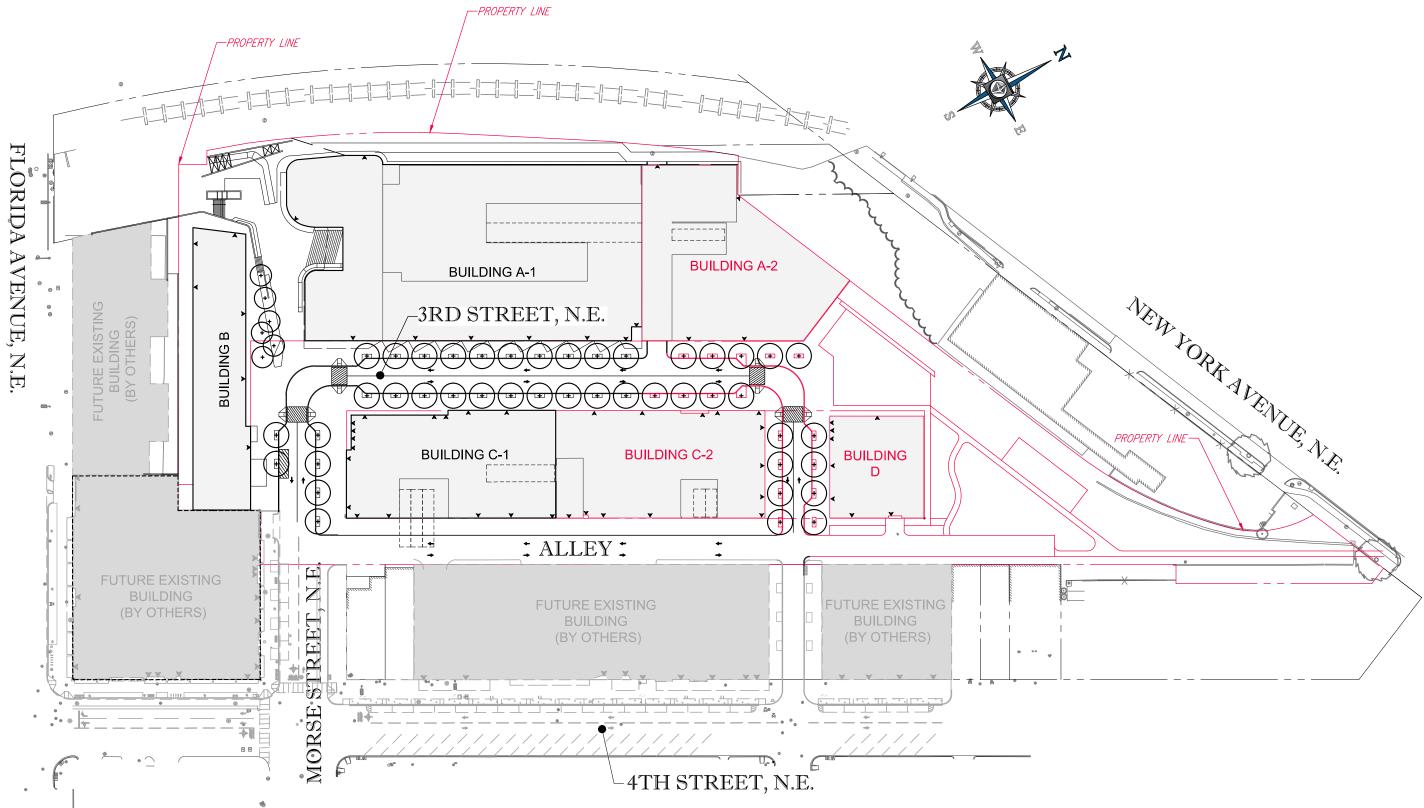

SITE PLAN - CONSOLIDATED AND FIRST STAGE PUD


R2L:ARCHITECTS SOBOHLER


SCALE: 1" = 100'

MARKET TERMINAL - PUD APPLICATION FOR CONSOLIDATED AND FIRST STAGE PUD




15 January, 2016

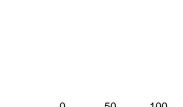

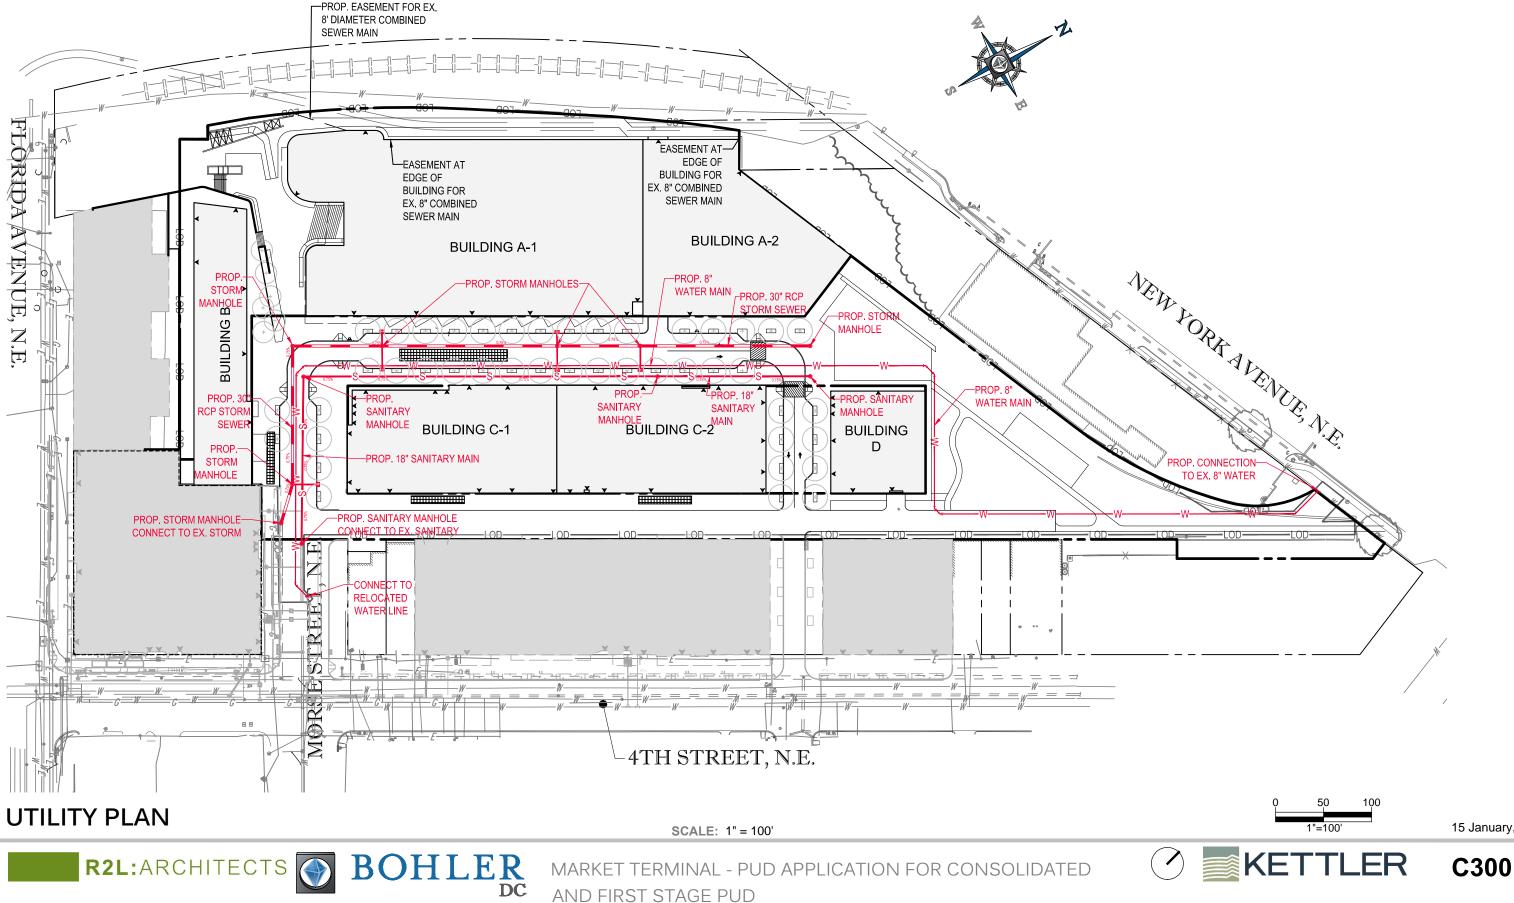



15 January, 2016

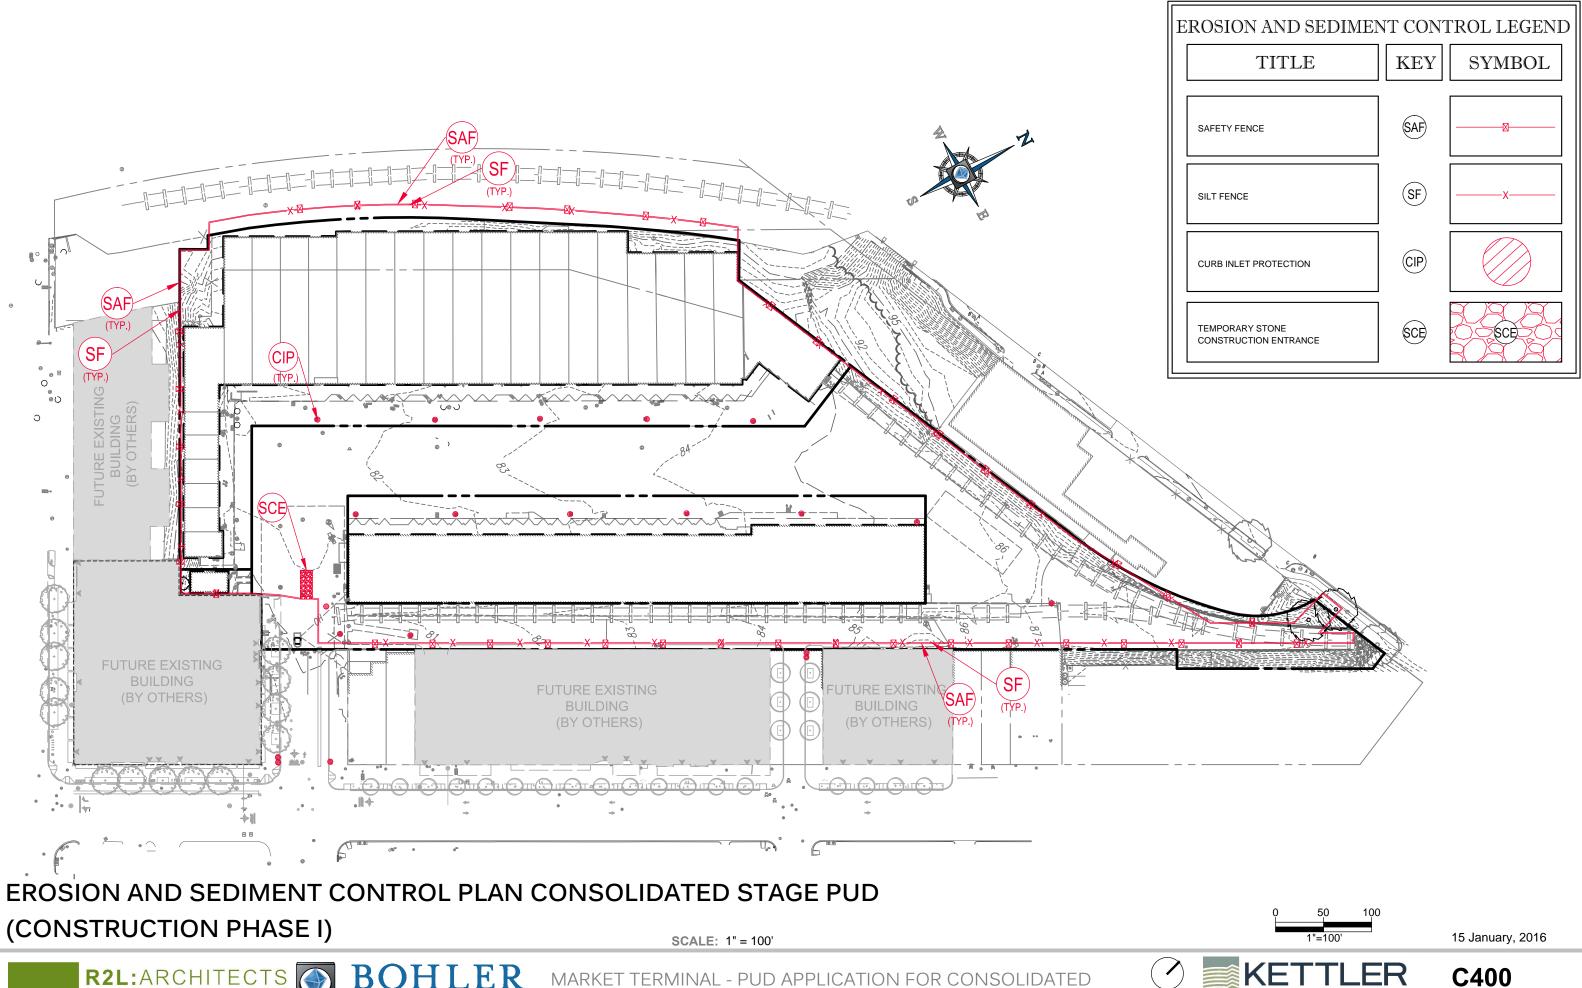

R2L:ARCHITECTS SOBOHLER

MARKET TERMINAL - PUD APPLICATION FOR CONSOLIDATED AND FIRST STAGE PUD

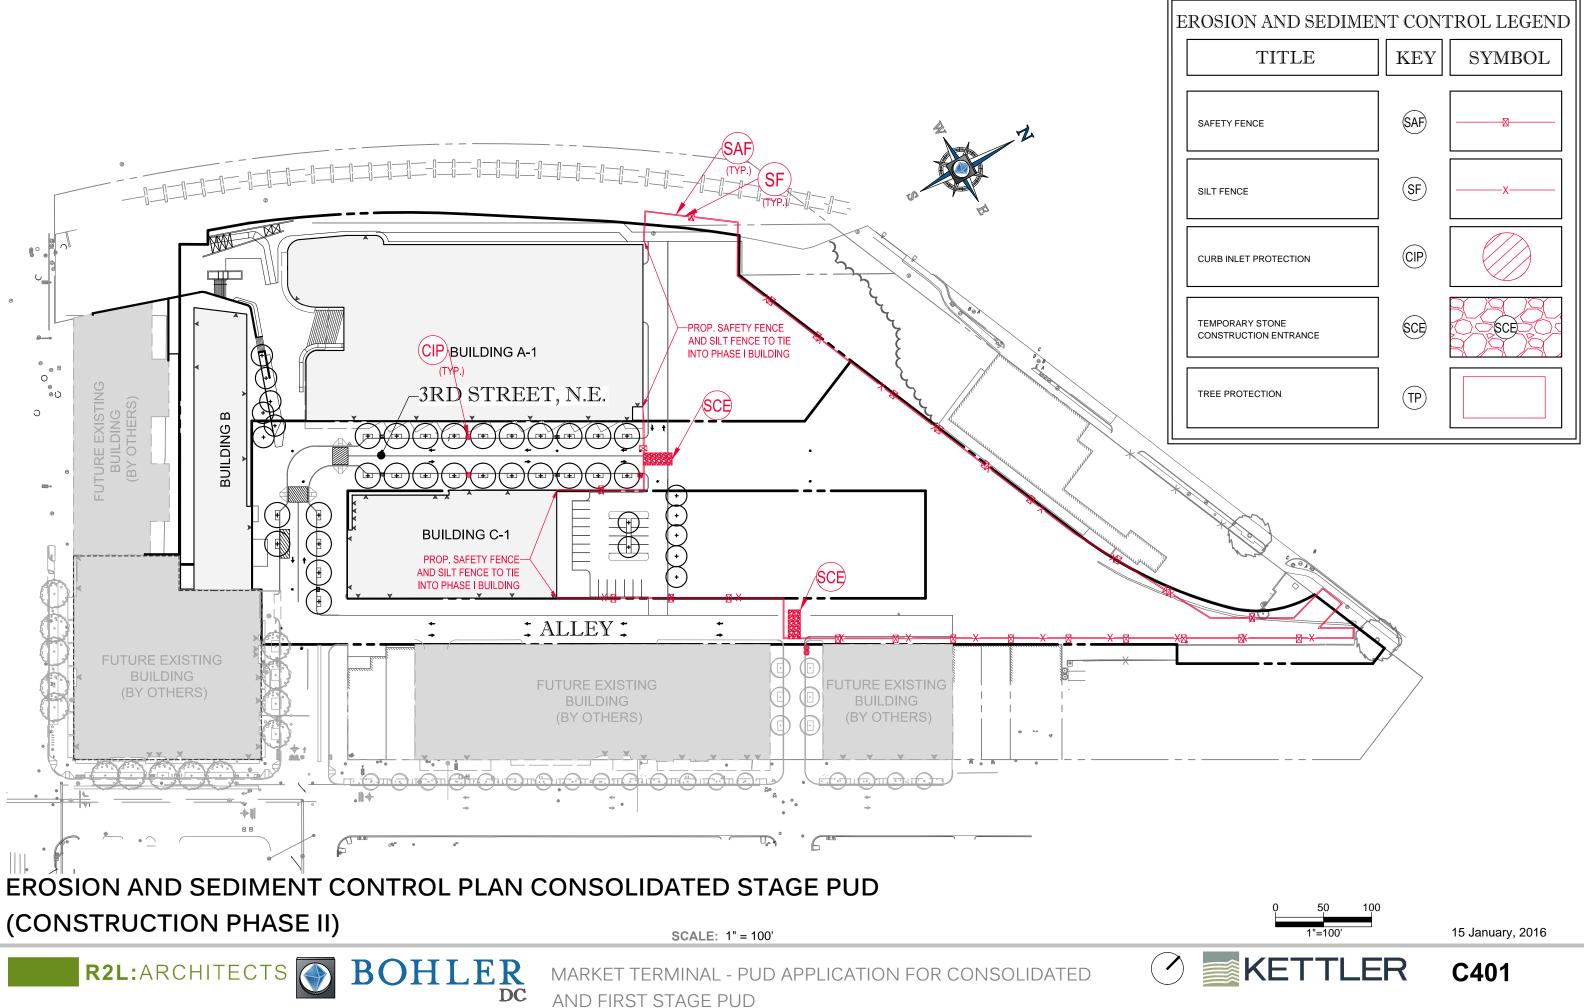

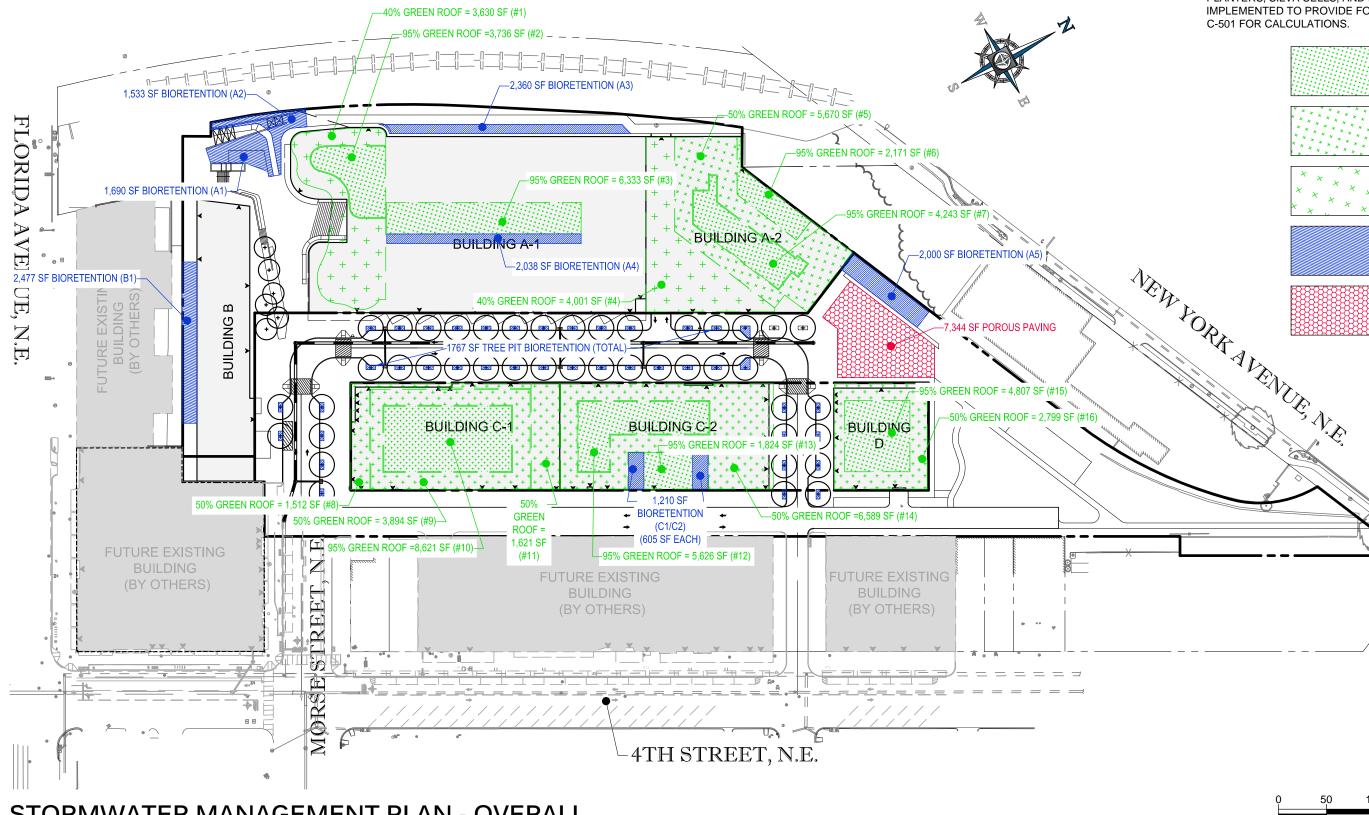

DC

STORMWATER MANAGEMENT PLAN - OVERALL

R2L:ARCHITECTS SOHLER

SCALE: 1" = 100'

MARKET TERMINAL - PUD APPLICATION FOR CONSOLIDATED AND FIRST STAGE PUD

STORMWATER MANAGEMENT PLAN NARRATIVE

THE TOTAL SITE AREA IS 339,182 SF AND HAS A SWRV REQUIREMENT OF 27,648 CF. GREEN ROOFS, BIORETENTION FACILITIES AND STREET PLANTERS, SILVA CELLS, AND PERMEABLE PAVEMENT WILL BE IMPLEMENTED TO PROVIDE FOR THE REQUIRED SWRV. SEE SHEET C-501 FOR CALCULATIONS.






95% OF ROOF AREA TO BE GREEN ROOF

50% OF ROOF AREA TO BE GREEN ROOF

40% OF ROOF AREA TO BE GREEN ROOF

BIORETENTION

PERMEABLE PAVEMENT

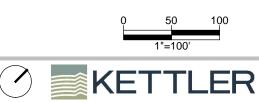

15 January, 2016

GREEN ROOF

<u>GREEN ROOF</u>														
	STAGE	SURFACE	TOTAL		PROP. IMP	MEDIA	DRAINAGE LAYER		STORAGE		SWRv			
GREEN ROOF#		AREA (SF)	CDA (SF)	EX. IMP (SF)	(SF)	DEPTH (in.)	DEPTH (IN)	LOCATION	PROVIDED	Max SWRv	PROVIDED			
1	CONSOLIDATED PUD	3,630	3,630		3,630		1.5	Building A-1: Penthouse (intensive)	1225	489				
2	CONSOLIDATED PUD	3,736	3,736	3,736	3,736	6	1.5	Building A-1: Penthouse (extensive)	981	503	503			
3	CONSOLIDATED PUD	6,333	6,333	6,333	6,333	6	1.5	Building A-1: Roof (extensive)	1662	852	852			
4	FIRST STAGE PUD	4,001	4,001	4,001	4,001	8	1.5	Building A-2: Left Side (intensive)	1350	538	538			
5	FIRST STAGE PUD	5,670	5,670	5,670	5,670	8	1.5	Building A-2: Center (intensive)	1913	763	763			
6	FIRST STAGE PUD	2,171	2,171	2,171	2,171	6	1.5	Building A-2: Right Side (extensive)	570	292	292			
7	FIRST STAGE PUD	4,243	4,243	4,243	4,243	6	1.5	Building A-2: Center (extensive)	1114	571	571			
8	CONSOLIDATED PUD	1,512	1,512	1,512	1,512	8	1.5	Building C-1: Left Side (intensive)	510	203	203			
9	CONSOLIDATED PUD	3,894	3,894	3,894	3,894	8	1.5	Building C-1: Outer (intensive)	1314	524	524			
10	CONSOLIDATED PUD	8,621	8,621	8,621	8,621	6	1.5	Building C-1: Inner (extensive)	2263	1160	1160			
11	CONSOLIDATED PUD	1,621	1,621	1,621	1,621	8	1.5	Building C-1: Right Side (intensive)	547	218	218			
12	FIRST STAGE PUD	5,626	5,626	5,626	5,626	6	1.5	Building C-2: Inner (extensive)	1477	757	757			
13	FIRST STAGE PUD	1,824	1,824	1,824	1,824	6	1.5	Building C-2: In Between Bios (extensive)	479	245	245			
14	FIRST STAGE PUD	6,589	6,589	6,589	6,589	8	1.5	Building C-2: Remaining (intensive)	2224	887	887			
15	FIRST STAGE PUD	4,807	4,807	4,807	4,807	6	1.5	Building D: Inner (extensive)	1262	647	647			
16	FIRST STAGE PUD	2,799	2,799	2,799	2,799	8	1.5	Building D: Outer (intensive)	944	377	377			
								TOTAL	19,836	9,027	9,027			
BIORETENTION														
		SURFACE	SURFACE						MEDIA					
		AREA,	AREA, TOP	TOTAL CDA	EX. IMP	PROP. IMP			DEPTH	GRAVEL	STORAGE			
FACILITY	STAGE	BOT. (SF)	(SF)	(SF)	(SF)	(SF)	FREEBOARD (FT)	PONDING DEPTH (FT)	(FT)	DEPTH (FT)	PROVIDED	SWRv (CF)	Max SWRv	SWRv PROVIDED
A1	CONSOLIDATED PUD	1,690	1690	21,090		21090	0	2	2	1	4,901	2,941	2,838	2,838
A2	CONSOLIDATED PUD	1,533	1533	10464		5982	0	2	2	1	4,446	2,667	964	964
A3	CONSOLIDATED PUD	2,360	2360	48,599		48598.95	0	2	2	1	6,844	4,106	6,541	4,106
A4	CONSOLIDATED PUD	2,038	2038	5,668		5668	0	1.5	2	1	4,891	2,935	763	763
B1	CONSOLIDATED PUD	2,477	2477	18904		18904	0	1	2	1	4,706	2,824	2,544	2,544
A5	FIRST STAGE PUD	2,000	2000	15,228		15227.85	0	1	2	1	3,800	2,280	2,049	2,049
C1	FIRST STAGE PUD	605	605	3,295		3294.5	0	1	2	1	1,150	690	443	443
C2	FIRST STAGE PUD	605	605	3,295		3294.5	0	1	2	1	1,150	690	443	443
	CONSOLIDATED AND													
TREE PIT	FIRST STAGE PUD	1,767	1767	32,498		32,498	0	1	2	1	3,357	2,014	4,374	2,014
		_,. 0,	2.07			, 100		<u> </u>		÷				
	CONSOLIDATED AND										1,081	648	4,012	648
SILVA CELLS	FIRST STAGE PUD	1,621	1621	29,813		29,813	0	0	2.6666667	0				
										TOTAL	36,325	21,795	24,972	16,815

PERMEABLE PAVING

Location	STAGE	SA (SF)	SWRv (CF)
Plaza	FIRST STAGE PUD	7,344	330

Tree Planting

Location	STAGE	#	SWRv (CF)
Ground Floor	CONSOLIDATED AND FIRST STAGE PUD	150	1500

STORMWATER MANAGEMENT PLAN CALCULATIONS - OVERALL


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15 January, 2016

TOTAL SWRv REQUIRED =	27,648
TOTAL SWRv PROVIDED =	27,672



STORMWATER MANAGEMENT PLAN - PUD PHASING

R2L:ARCHITECTS SOBOHLER

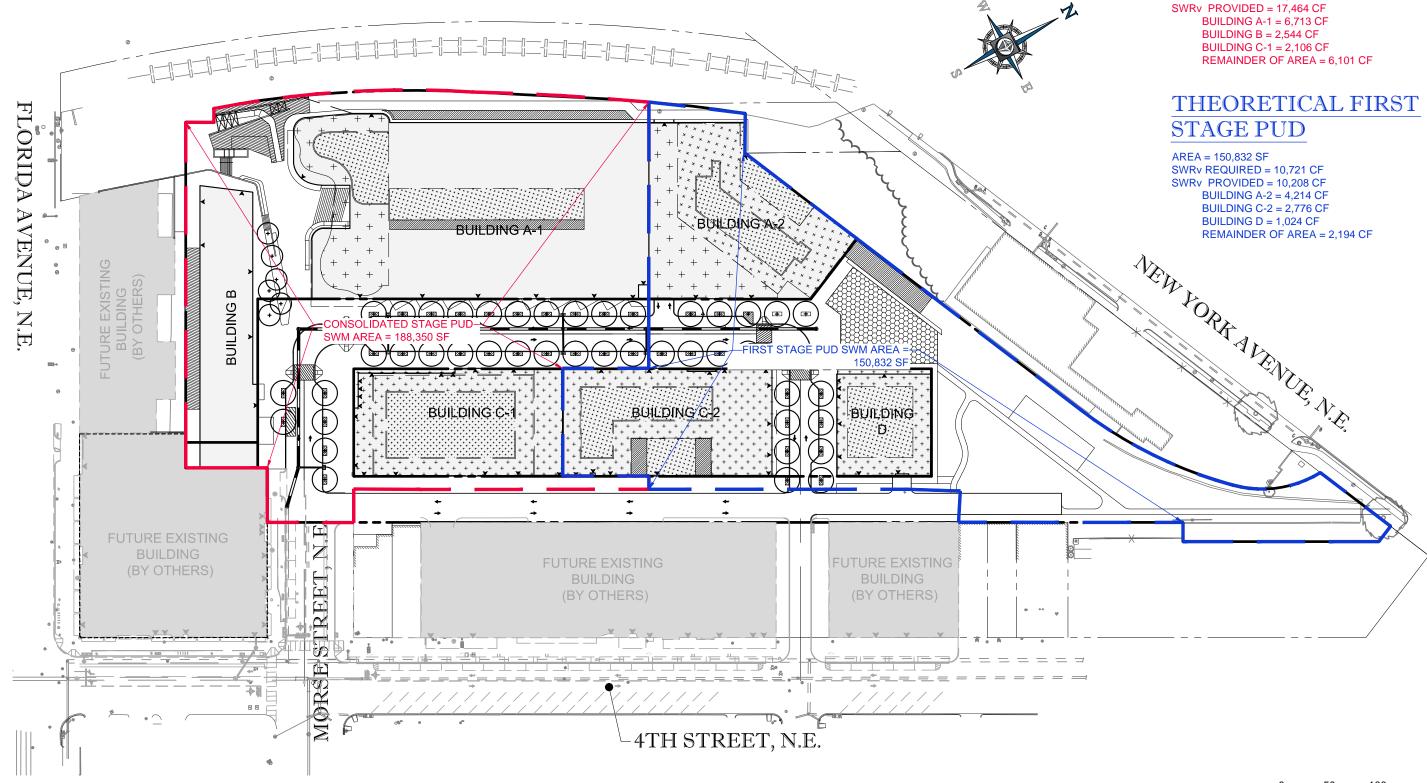SCALE: 1" = 100'

MARKET TERMINAL - PUD APPLICATION FOR CONSOLIDATED AND FIRST STAGE PUD

THEORETICAL CONSOLIDATED STAGE PUD

AREA = 188,350 SF SWRv REQUIRED = 16,927 CF

15 January, 2016