

1106-1112 EASTERN AVE NE WASHINGTON, DC 20007

ISSUE FOR BZA

31 OCTOBER 2025

//38//

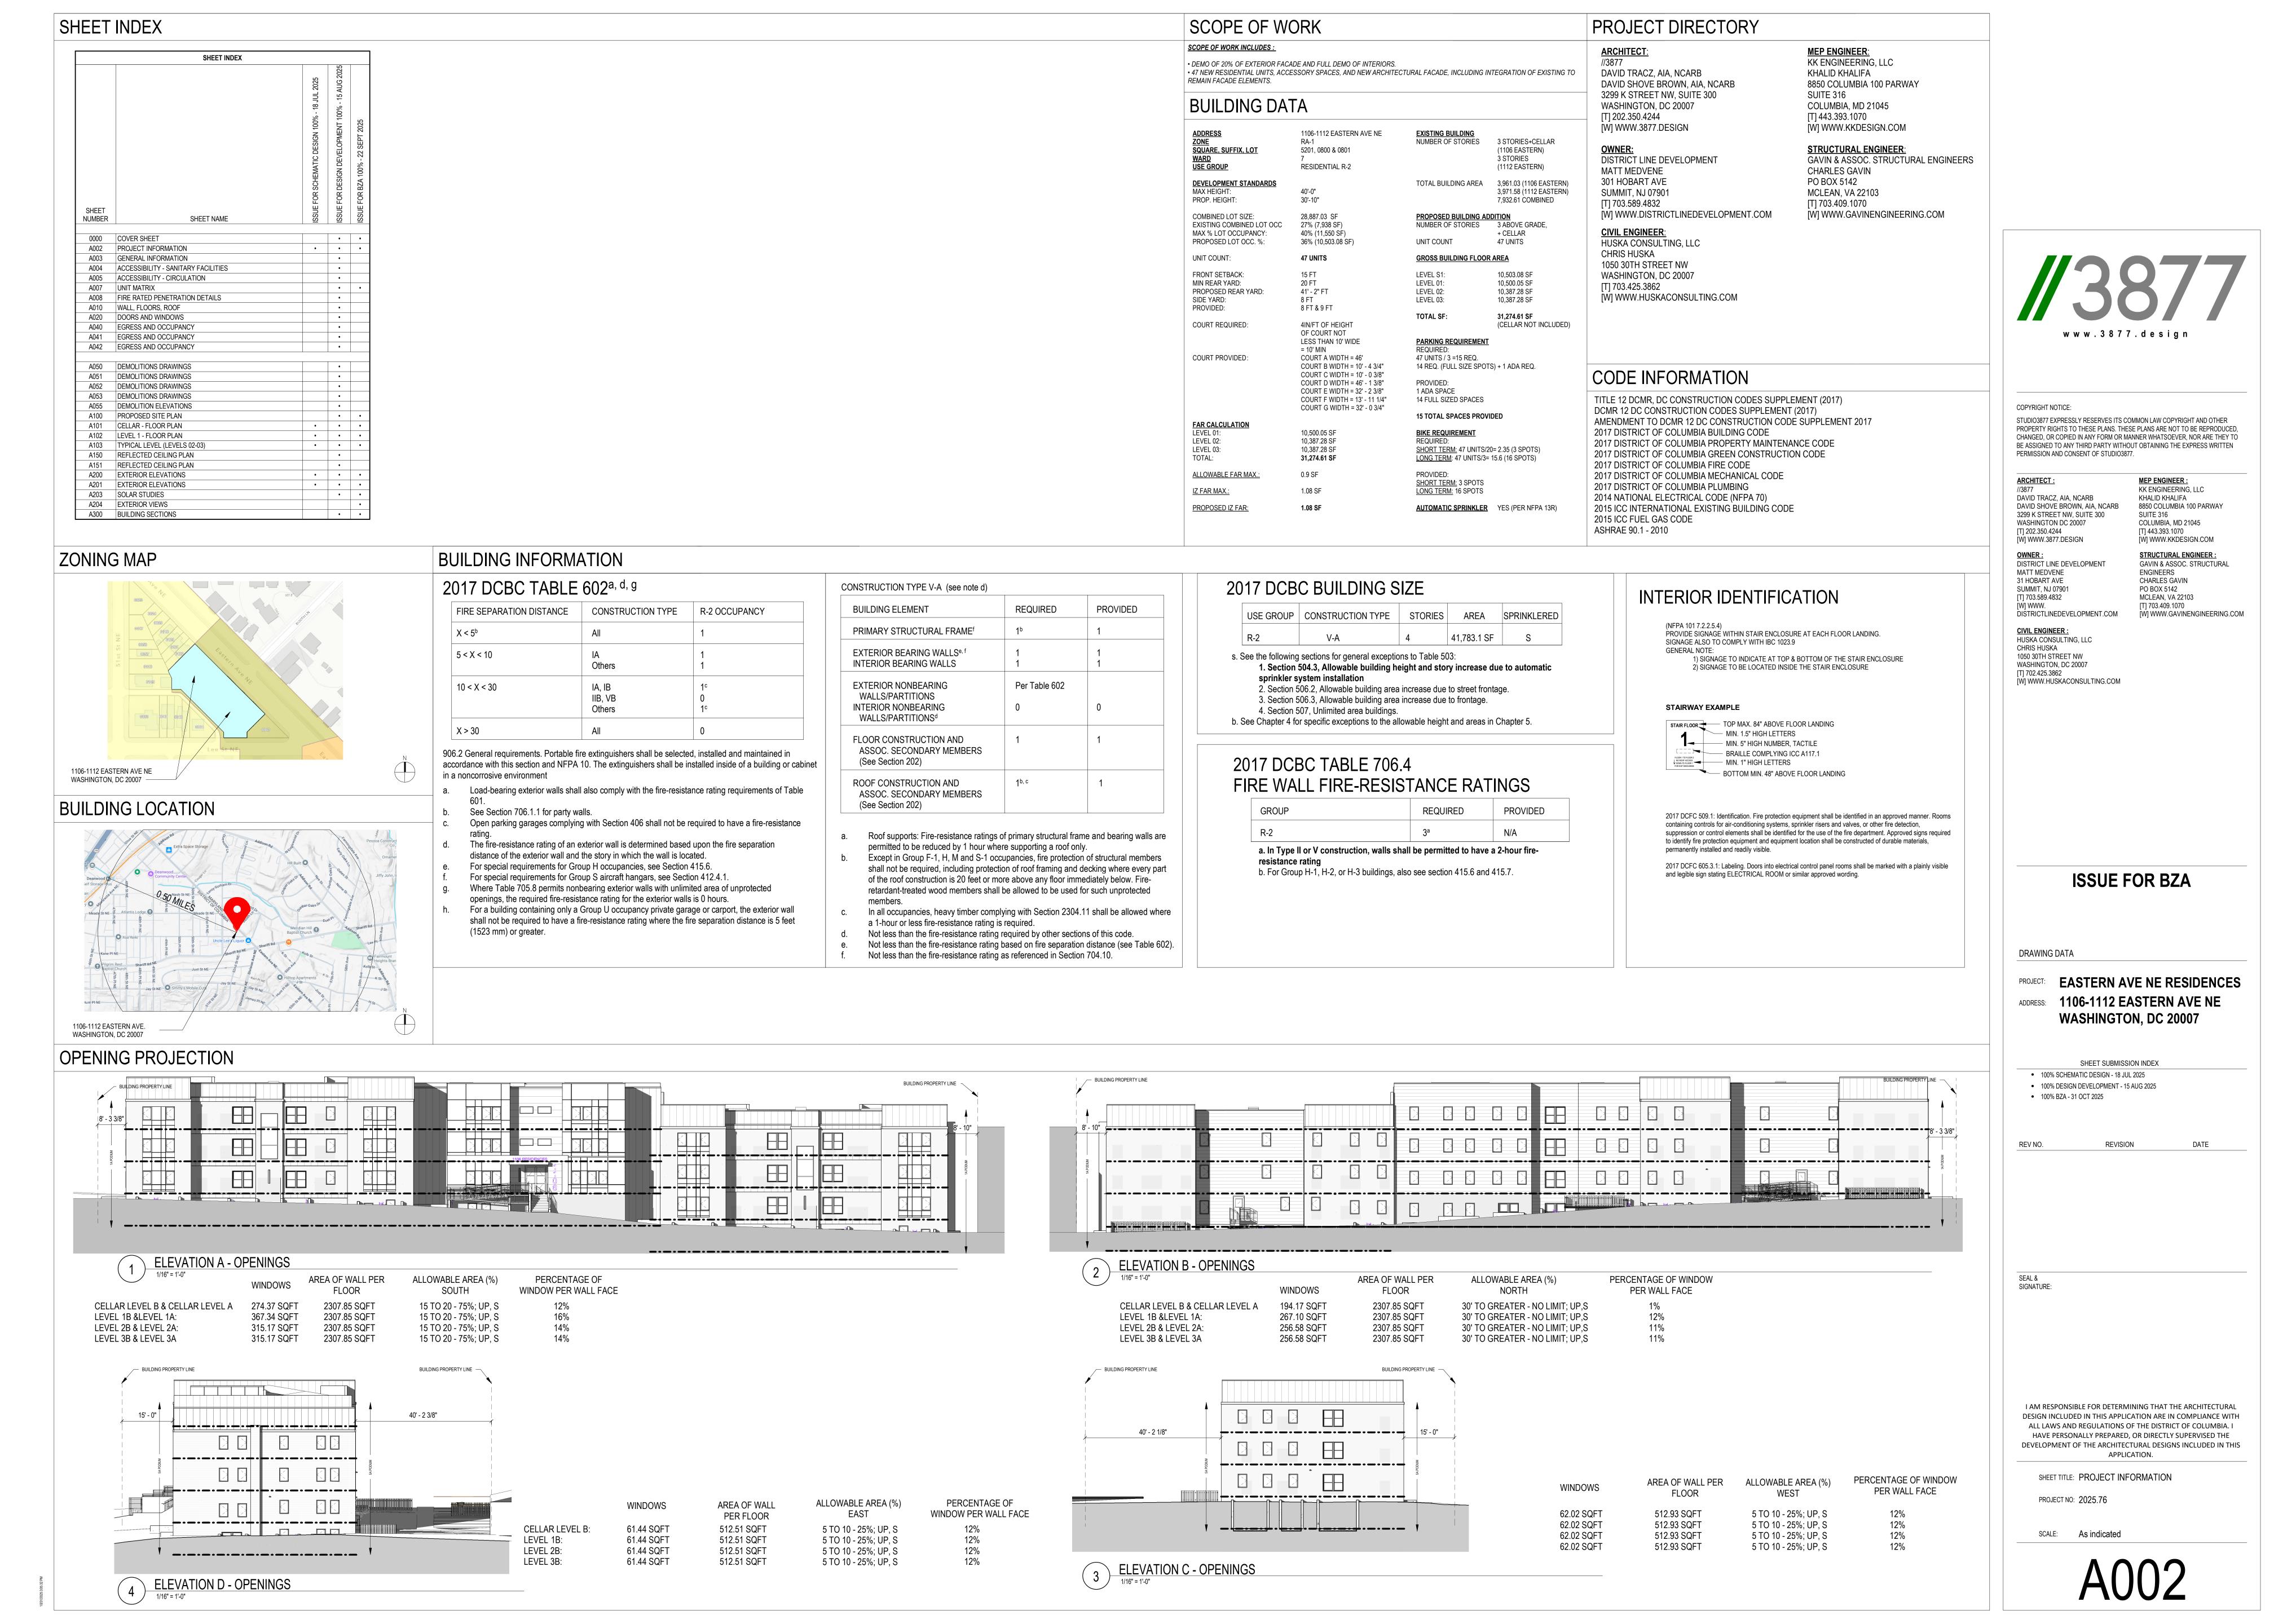

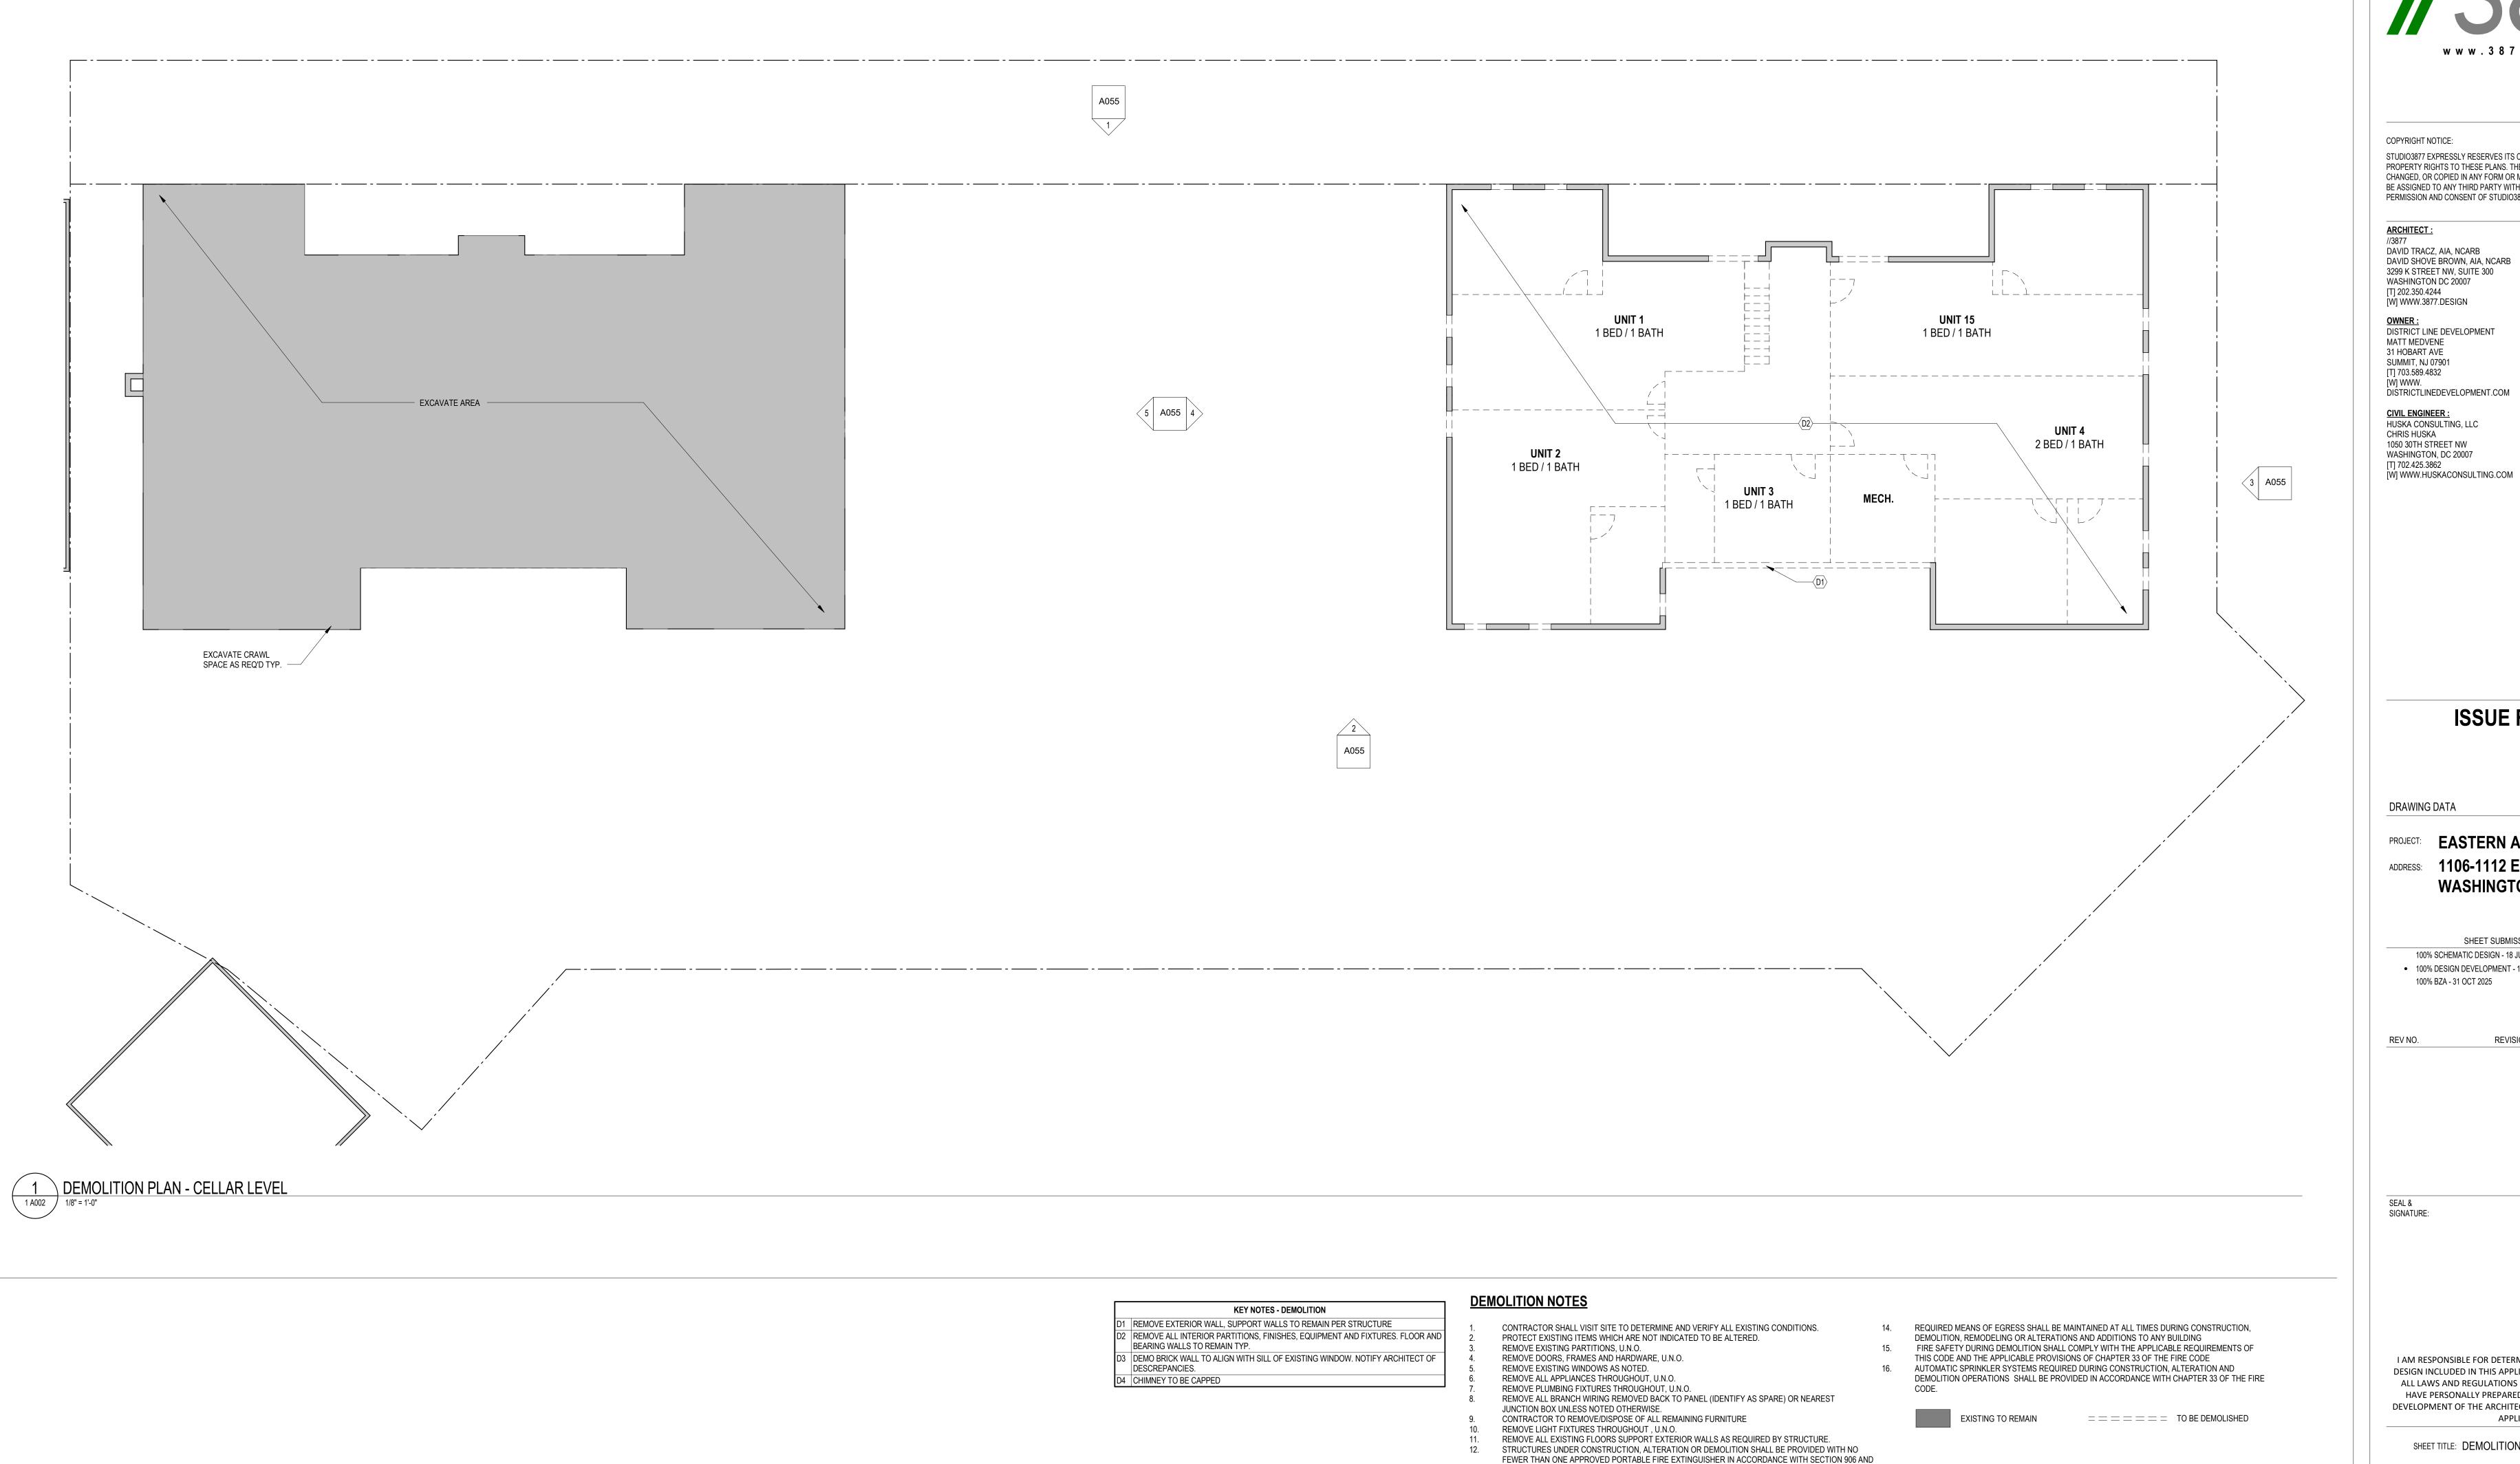

SIZED FOR NOT LESS THAN ORDINARY HAZARD AS FOLLOWS: 1. AT EACH STAIRWAY ON ALL FLOOR

LEVELS WHERE COMBUSTIBLE MATERIALS HAVE ACCUMULATED. 2. IN EVERY STORAGE AND CONSTRUCTION SHED. 3. ADDITIONAL PORTABLE FIRE EXTINGUISHERS SHALL BE PROVIDED WHERE SPECIAL HAZARDS EXIST, SUCH AS THE STORAGE AND USE OF FLAMMABLE AND COMBUSTIBLE LIQUIDS SANITARY FACILITIES SHALL BE PROVIDED DURING CONSTRUCTION, REMODELING OR DEMOLITION

ACTIVITIES IN ACCORDANCE WITH THE PLUMBING CODE

w w w . 3 8 7 7 . d e s i g n

COPYRIGHT NOTICE:

STUDIO3877 EXPRESSLY RESERVES ITS COMMON LAW COPYRIGHT AND OTHER PROPERTY RIGHTS TO THESE PLANS. THESE PLANS ARE NOT TO BE REPRODUCED. CHANGED, OR COPIED IN ANY FORM OR MANNER WHATSOEVER, NOR ARE THEY TO BE ASSIGNED TO ANY THIRD PARTY WITHOUT OBTAINING THE EXPRESS WRITTEN PERMISSION AND CONSENT OF STUDIO3877.

DAVID TRACZ, AIA, NCARB DAVID SHOVE BROWN, AIA, NCARB 3299 K STREET NW, SUITE 300 WASHINGTON DC 20007 [T] 202.350.4244 [W] WWW.3877.DESIGN

KK ENGINEERING, LLC KHALID KHALIFA 8850 COLUMBIA 100 PARWAY SUITE 316 COLUMBIA, MD 21045 [T] 443.393.1070 [W] WWW.KKDESIGN.COM STRUCTURAL ENGINEER: GAVIN & ASSOC. STRUCTURAL

[T] 703.409.1070

MEP ENGINEER:

DISTRICT LINE DEVELOPMENT MATT MEDVENE **ENGINEERS** 31 HOBART AVE CHARLES GAVIN SUMMIT, NJ 07901 PO BOX 5142 MCLEAN, VA 22103 [T] 703.589.4832 [W] WWW. [W] WWW.GAVINENGINEERING.COM

DISTRICTLINEDEVELOPMENT.COM **CIVIL ENGINEER:** HUSKA CONSULTING, LLC CHRIS HUSKA 1050 30TH STREET NW WASHINGTON, DC 20007 [T] 702.425.3862

ISSUE FOR BZA

DRAWING DATA

PROJECT: EASTERN AVE NE RESIDENCES ADDRESS: 1106-1112 EASTERN AVE NE **WASHINGTON, DC 20007**

SHEET SUBMISSION INDEX 100% SCHEMATIC DESIGN - 18 JUL 2025 100% DESIGN DEVELOPMENT - 15 AUG 2025

100% BZA - 31 OCT 2025

REVISION


DATE

SEAL & SIGNATURE:

I AM RESPONSIBLE FOR DETERMINING THAT THE ARCHITECTURAL DESIGN INCLUDED IN THIS APPLICATION ARE IN COMPLIANCE WITH ALL LAWS AND REGULATIONS OF THE DISTRICT OF COLUMBIA. I HAVE PERSONALLY PREPARED, OR DIRECTLY SUPERVISED THE DEVELOPMENT OF THE ARCHITECTURAL DESIGNS INCLUDED IN THIS APPLICATION.

SHEET TITLE: DEMOLITIONS DRAWINGS

PROJECT NO: 2025.76

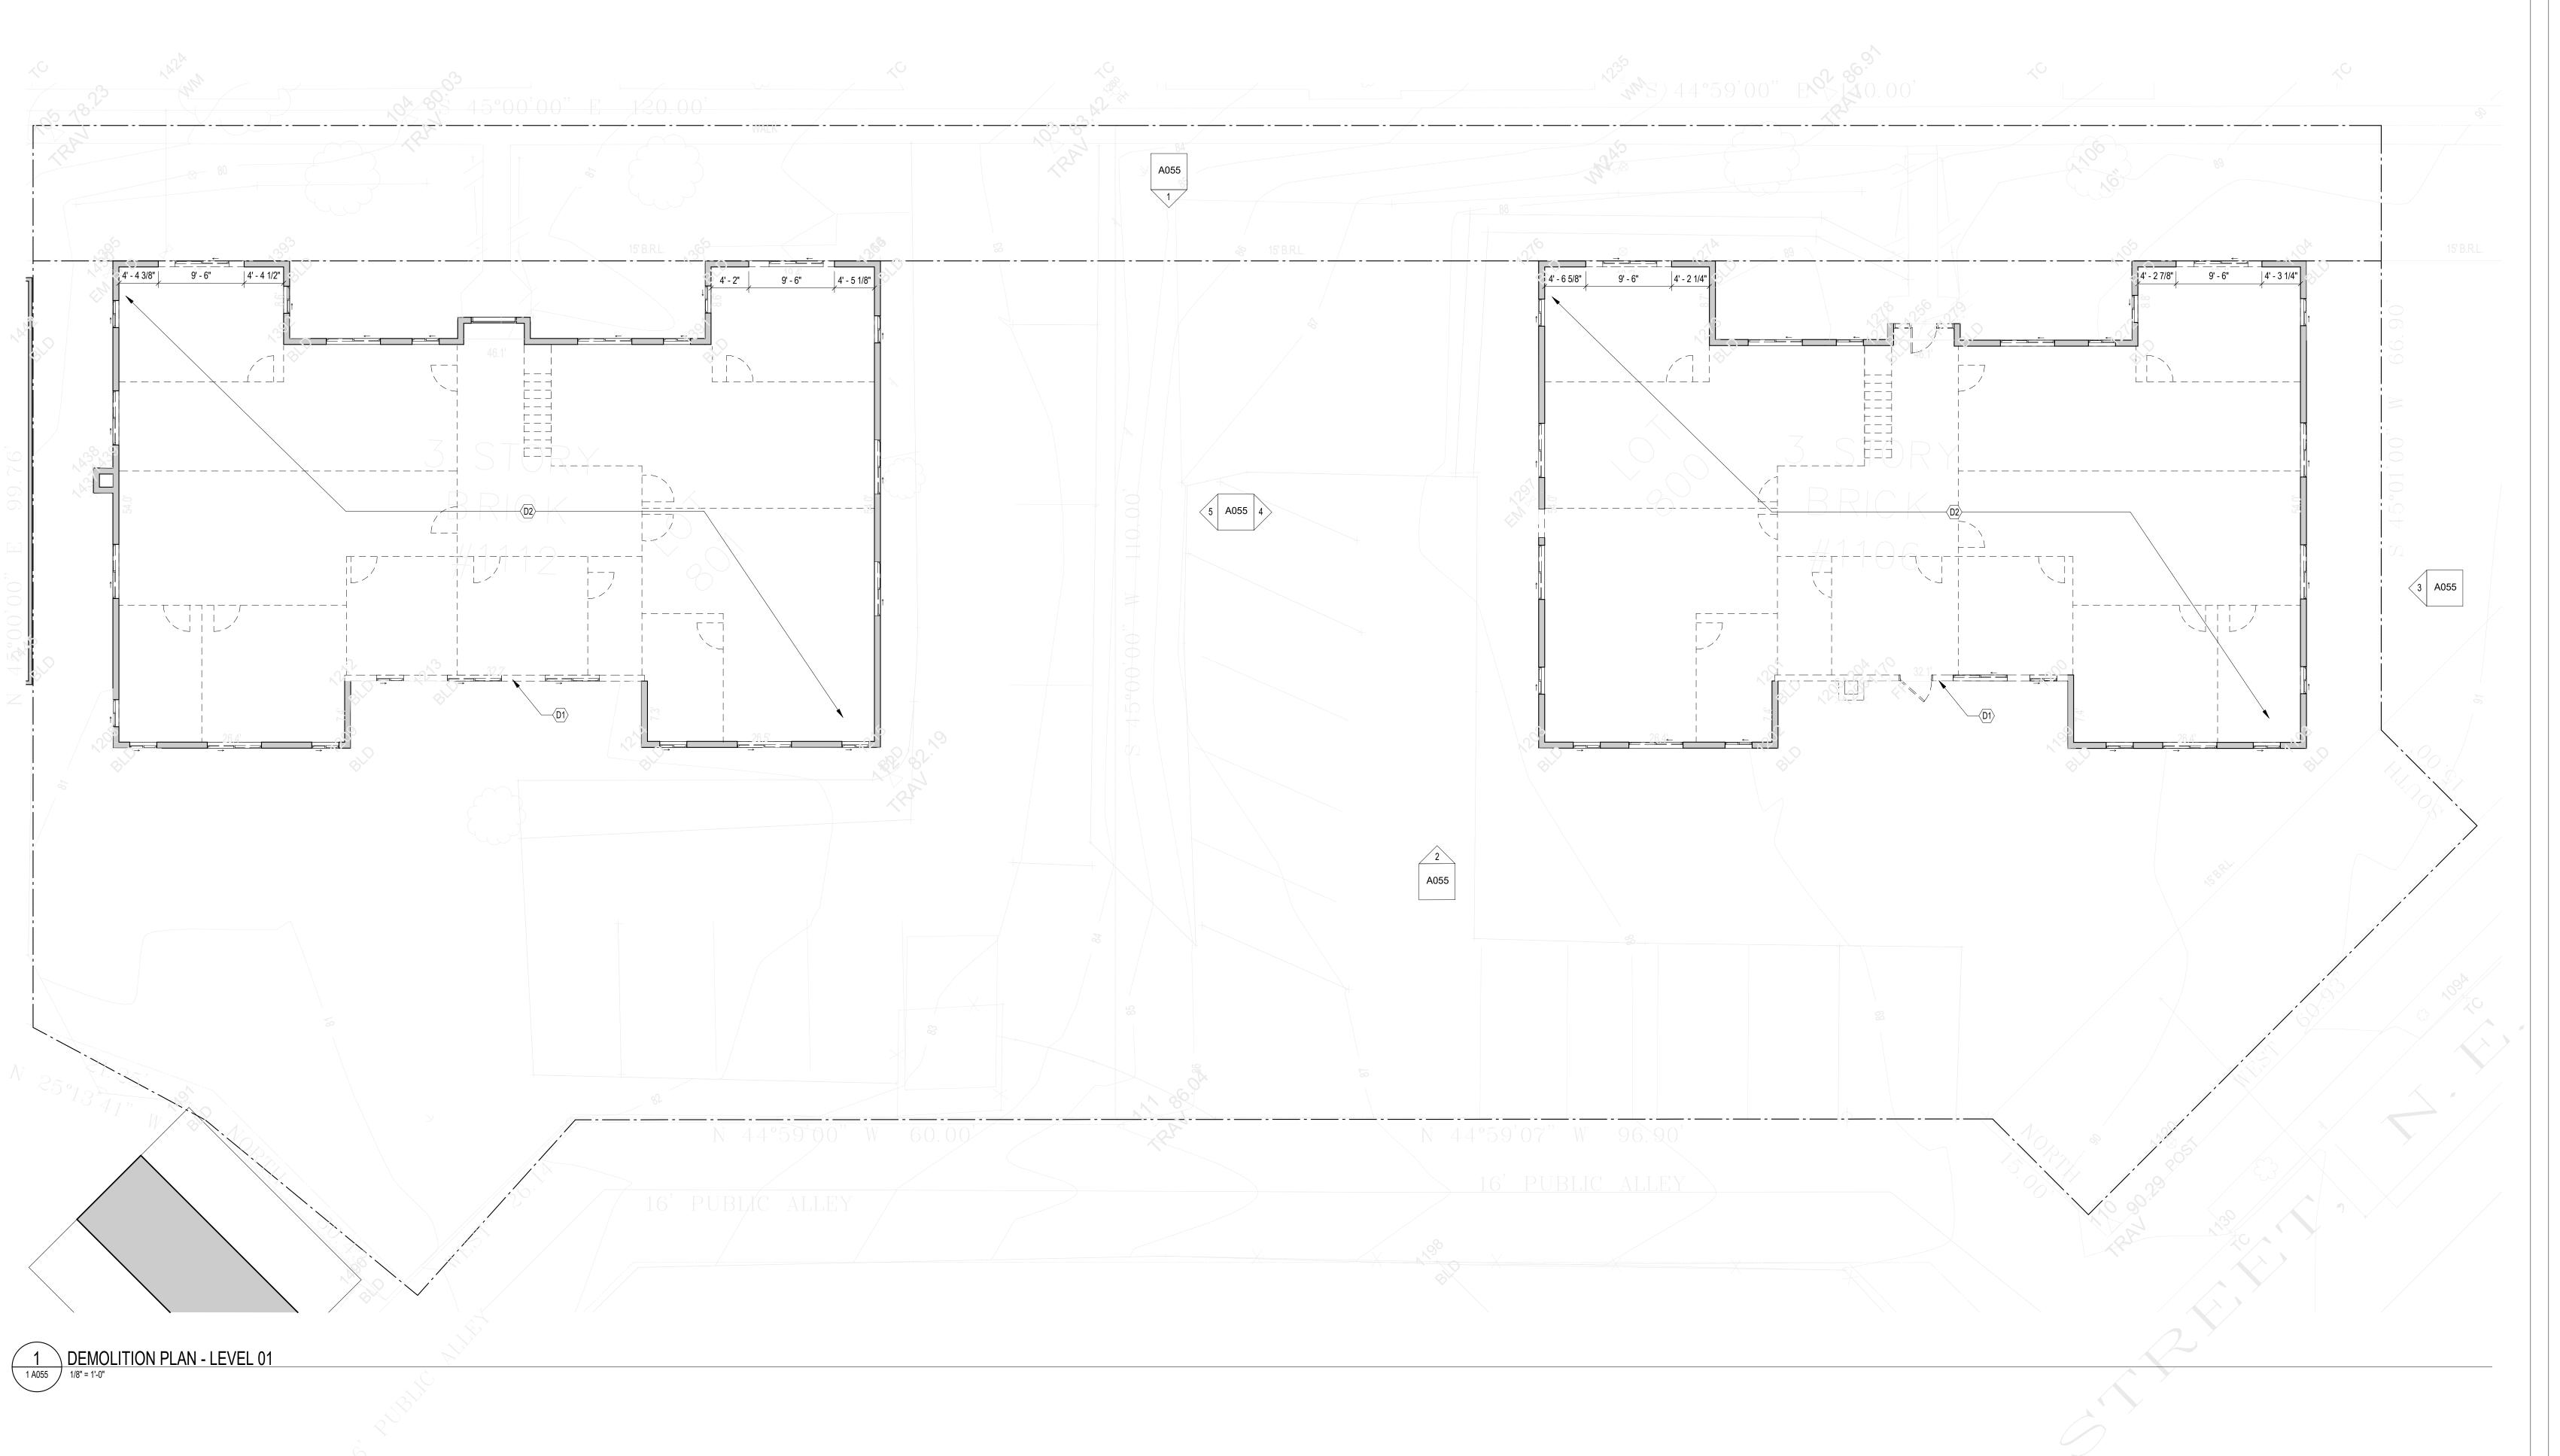

KEY NOTES - DEMOLITION

D3 DEMO BRICK WALL TO ALIGN WITH SILL OF EXISTING WINDOW. NOTIFY ARCHITECT OF

REMOVE ALL INTERIOR PARTITIONS, FINISHES, EQUIPMENT AND FIXTURES. FLOOR AND

REMOVE EXTERIOR WALL, SUPPORT WALLS TO REMAIN PER STRUCTURE

BEARING WALLS TO REMAIN TYP.

DESCREPANCIES.

D4 CHIMNEY TO BE CAPPED

DEMOLITION NOTES

REMOVE EXISTING PARTITIONS, U.N.O.

REMOVE EXISTING WINDOWS AS NOTED.

REMOVE DOORS, FRAMES AND HARDWARE, U.N.O.

REMOVE ALL APPLIANCES THROUGHOUT, U.N.O.

JUNCTION BOX UNLESS NOTED OTHERWISE.

REMOVE LIGHT FIXTURES THROUGHOUT, U.N.O.

ACTIVITIES IN ACCORDANCE WITH THE PLUMBING CODE

REMOVE PLUMBING FIXTURES THROUGHOUT, U.N.O.

CONTRACTOR SHALL VISIT SITE TO DETERMINE AND VERIFY ALL EXISTING CONDITIONS.

REMOVE ALL BRANCH WIRING REMOVED BACK TO PANEL (IDENTIFY AS SPARE) OR NEAREST

REMOVE ALL EXISTING FLOORS SUPPORT EXTERIOR WALLS AS REQUIRED BY STRUCTURE.

LEVELS WHERE COMBUSTIBLE MATERIALS HAVE ACCUMULATED. 2. IN EVERY STORAGE AND CONSTRUCTION SHED. 3. ADDITIONAL PORTABLE FIRE EXTINGUISHERS SHALL BE PROVIDED WHERE SPECIAL HAZARDS EXIST, SUCH AS THE STORAGE AND USE OF FLAMMABLE AND COMBUSTIBLE LIQUIDS SANITARY FACILITIES SHALL BE PROVIDED DURING CONSTRUCTION, REMODELING OR DEMOLITION

STRUCTURES UNDER CONSTRUCTION, ALTERATION OR DEMOLITION SHALL BE PROVIDED WITH NO FEWER THAN ONE APPROVED PORTABLE FIRE EXTINGUISHER IN ACCORDANCE WITH SECTION 906 AND SIZED FOR NOT LESS THAN ORDINARY HAZARD AS FOLLOWS: 1. AT EACH STAIRWAY ON ALL FLOOR

PROTECT EXISTING ITEMS WHICH ARE NOT INDICATED TO BE ALTERED.

CONTRACTOR TO REMOVE/DISPOSE OF ALL REMAINING FURNITURE

w w w . 3 8 7 7 . d e s i g n

COPYRIGHT NOTICE:

STUDIO3877 EXPRESSLY RESERVES ITS COMMON LAW COPYRIGHT AND OTHER CHANGED, OR COPIED IN ANY FORM OR MANNER WHATSOEVER, NOR ARE THEY TO BE ASSIGNED TO ANY THIRD PARTY WITHOUT OBTAINING THE EXPRESS WRITTEN PERMISSION AND CONSENT OF STUDIO3877.

DAVID TRACZ, AIA, NCARB DAVID SHOVE BROWN, AIA, NCARB 3299 K STREET NW, SUITE 300 WASHINGTON DC 20007 [T] 202.350.4244 [W] WWW.3877.DESIGN

8850 COLUMBIA 100 PARWAY SUITE 316 COLUMBIA, MD 21045 [T] 443.393.1070 [W] WWW.KKDESIGN.COM OWNER:
DISTRICT LINE DEVELOPMENT STRUCTURAL ENGINEER: GAVIN & ASSOC. STRUCTURAL

MEP ENGINEER: KK ENGINEERING, LLC KHALID KHALIFA

MATT MEDVENE **ENGINEERS** 31 HOBART AVE CHARLES GAVIN SUMMIT, NJ 07901 PO BOX 5142 MCLEAN, VA 22103 [T] 703.589.4832 [W] WWW. [T] 703.409.1070 DISTRICTLINEDEVELOPMENT.COM [W] WWW.GAVINENGINEERING.COM

<u>CIVIL ENGINEER :</u> HUSKA CONSULTING, LLC CHRIS HUSKA 1050 30TH STREET NW WASHINGTON, DC 20007 [W] WWW.HUSKACONSULTING.COM

ISSUE FOR BZA

DRAWING DATA

PROJECT: EASTERN AVE NE RESIDENCES ADDRESS: 1106-1112 EASTERN AVE NE **WASHINGTON, DC 20007**

SHEET SUBMISSION INDEX 100% SCHEMATIC DESIGN - 18 JUL 2025 100% DESIGN DEVELOPMENT - 15 AUG 2025

100% BZA - 31 OCT 2025

REVISION

SEAL & SIGNATURE:

I AM RESPONSIBLE FOR DETERMINING THAT THE ARCHITECTURAL DESIGN INCLUDED IN THIS APPLICATION ARE IN COMPLIANCE WITH ALL LAWS AND REGULATIONS OF THE DISTRICT OF COLUMBIA. I HAVE PERSONALLY PREPARED, OR DIRECTLY SUPERVISED THE DEVELOPMENT OF THE ARCHITECTURAL DESIGNS INCLUDED IN THIS

APPLICATION.

SHEET TITLE: DEMOLITIONS DRAWINGS

SCALE: As indicated

PROJECT NO: 2025.76

REQUIRED MEANS OF EGRESS SHALL BE MAINTAINED AT ALL TIMES DURING CONSTRUCTION.

FIRE SAFETY DURING DEMOLITION SHALL COMPLY WITH THE APPLICABLE REQUIREMENTS OF


DEMOLITION OPERATIONS SHALL BE PROVIDED IN ACCORDANCE WITH CHAPTER 33 OF THE FIRE

= = = = = To be demolished

DEMOLITION, REMODELING OR ALTERATIONS AND ADDITIONS TO ANY BUILDING

THIS CODE AND THE APPLICABLE PROVISIONS OF CHAPTER 33 OF THE FIRE CODE

AUTOMATIC SPRINKLER SYSTEMS REQUIRED DURING CONSTRUCTION, ALTERATION AND

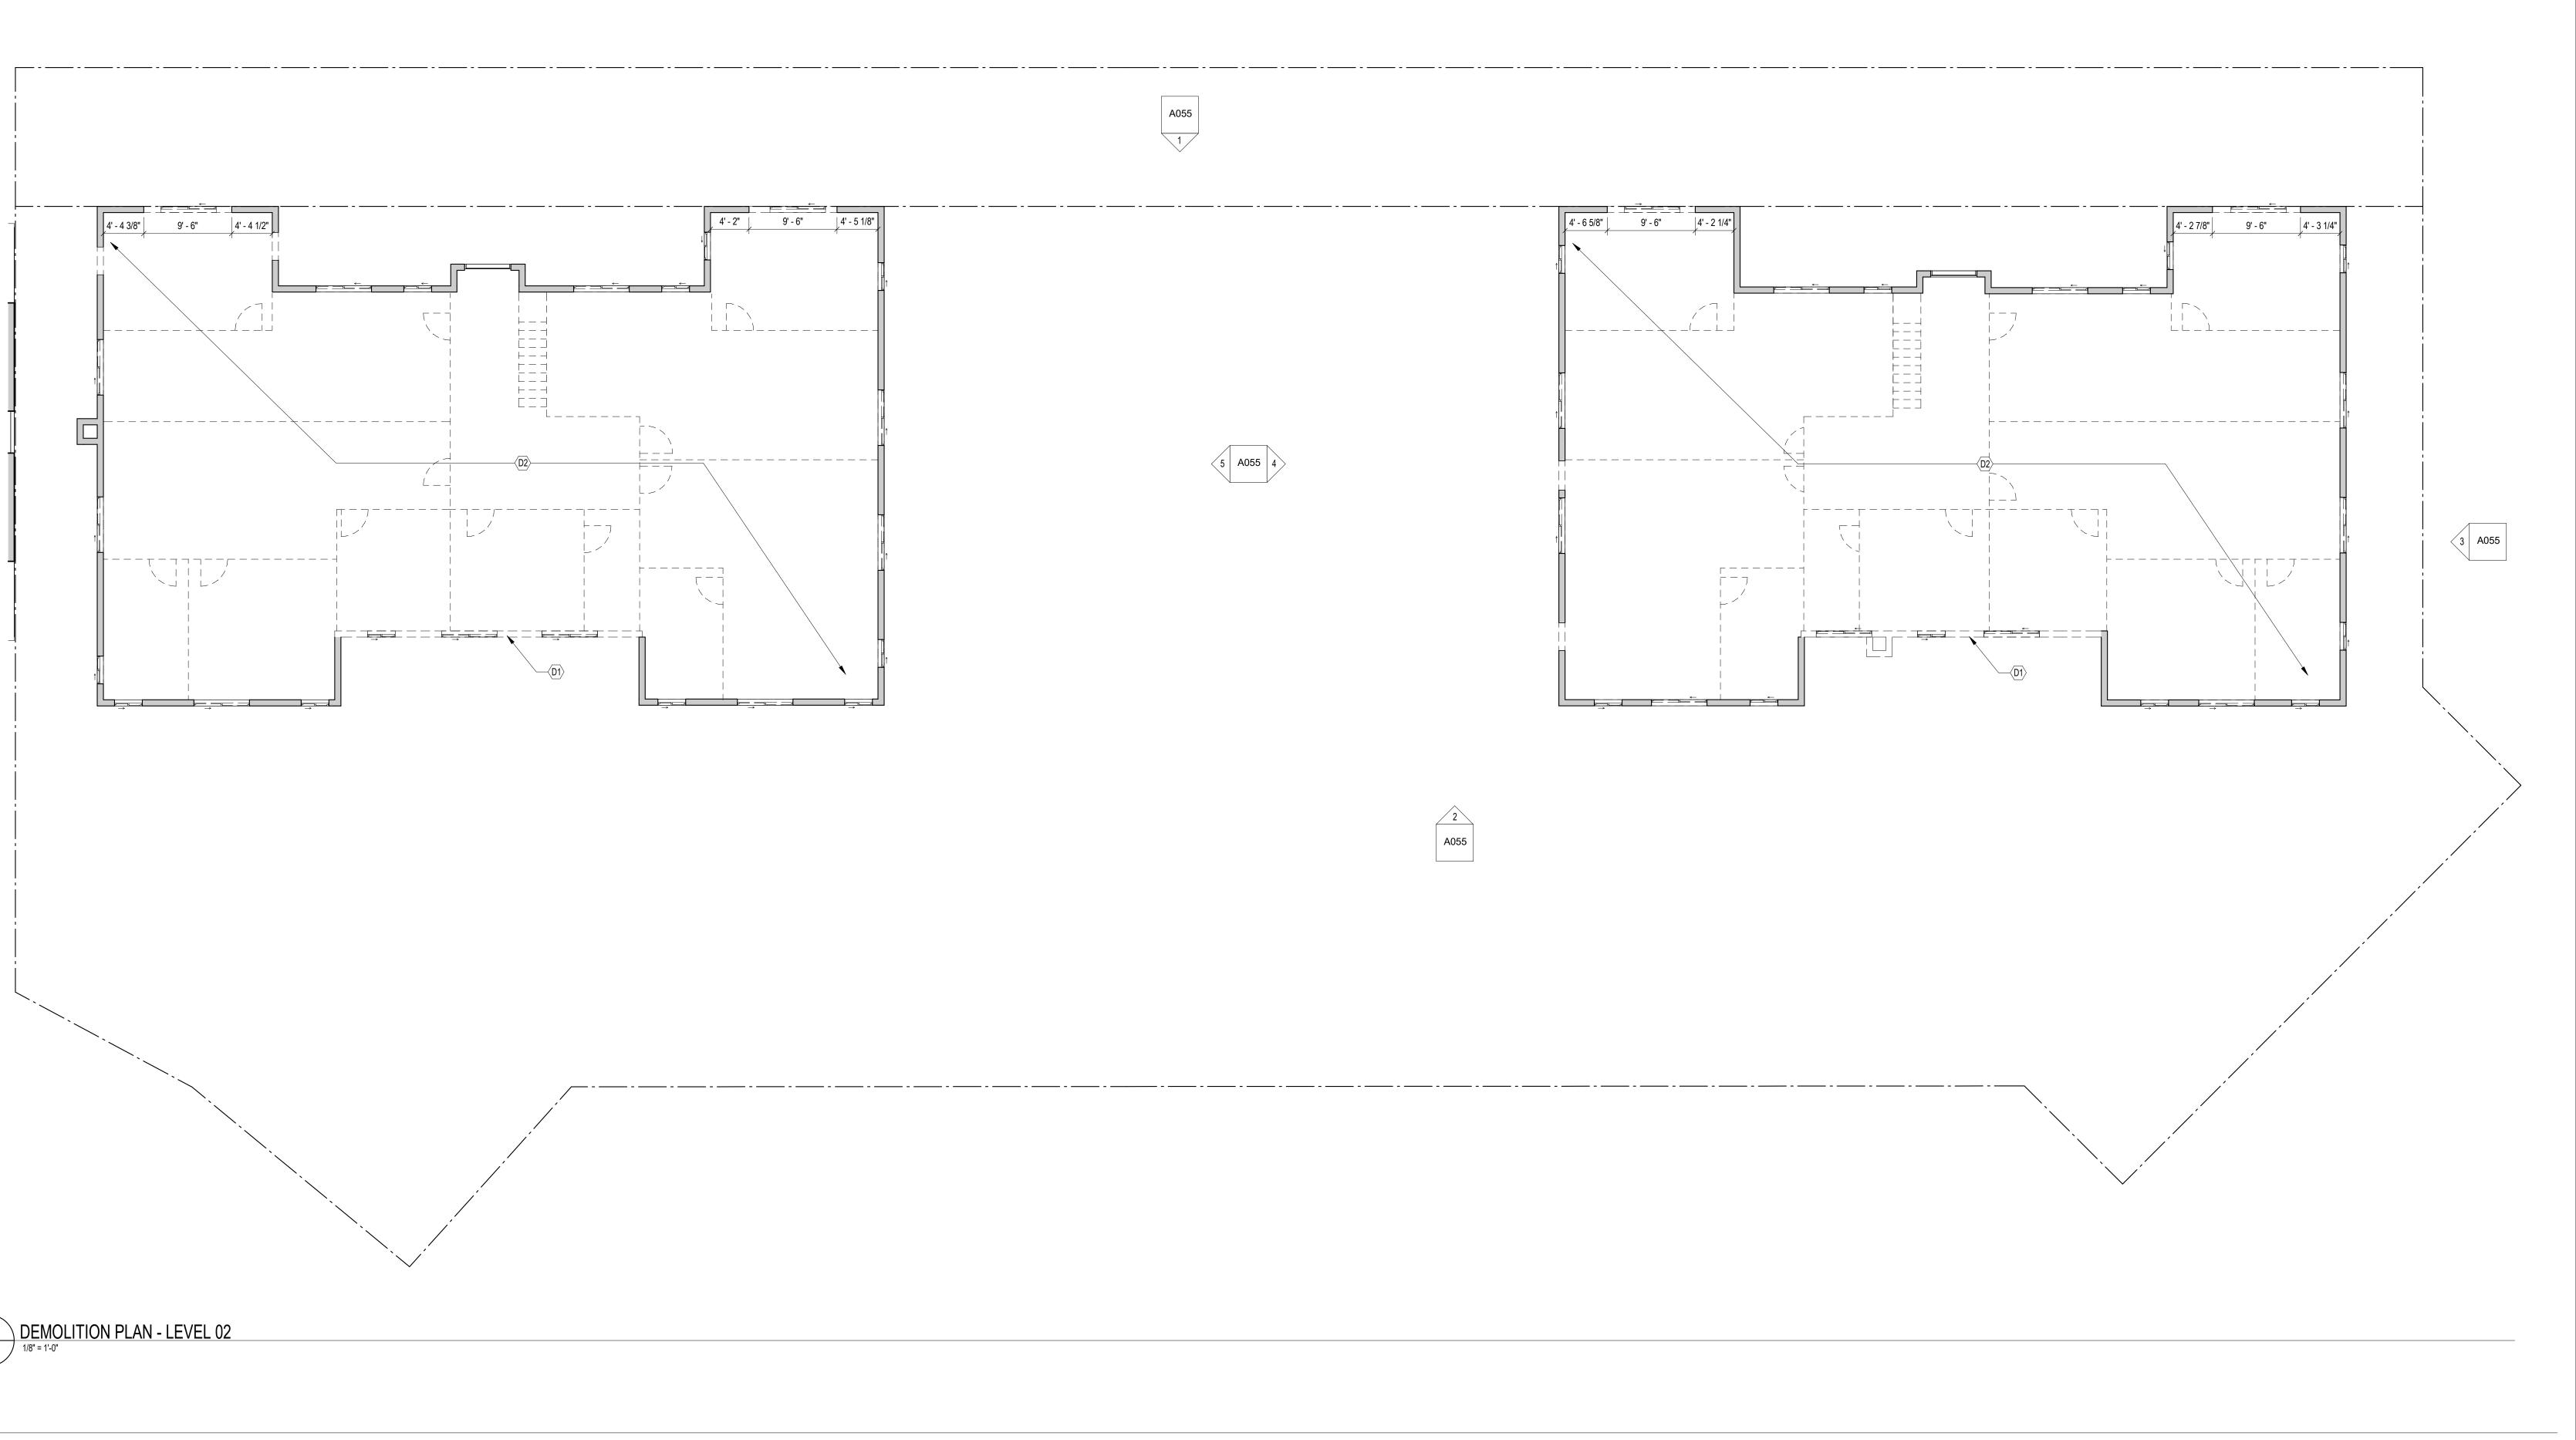

KEY NOTES - DEMOLITION

D3 DEMO BRICK WALL TO ALIGN WITH SILL OF EXISTING WINDOW. NOTIFY ARCHITECT OF

REMOVE ALL INTERIOR PARTITIONS, FINISHES, EQUIPMENT AND FIXTURES. FLOOR AND

REMOVE EXTERIOR WALL, SUPPORT WALLS TO REMAIN PER STRUCTURE

BEARING WALLS TO REMAIN TYP.

DESCREPANCIES.

D4 CHIMNEY TO BE CAPPED

DEMOLITION NOTES

REMOVE EXISTING PARTITIONS, U.N.O.

REMOVE EXISTING WINDOWS AS NOTED.

REMOVE DOORS, FRAMES AND HARDWARE, U.N.O.

REMOVE ALL APPLIANCES THROUGHOUT, U.N.O.

REMOVE LIGHT FIXTURES THROUGHOUT, U.N.O.

ACTIVITIES IN ACCORDANCE WITH THE PLUMBING CODE

JUNCTION BOX UNLESS NOTED OTHERWISE.

REMOVE PLUMBING FIXTURES THROUGHOUT, U.N.O.

CONTRACTOR SHALL VISIT SITE TO DETERMINE AND VERIFY ALL EXISTING CONDITIONS.

REMOVE ALL BRANCH WIRING REMOVED BACK TO PANEL (IDENTIFY AS SPARE) OR NEAREST

REMOVE ALL EXISTING FLOORS SUPPORT EXTERIOR WALLS AS REQUIRED BY STRUCTURE.

LEVELS WHERE COMBUSTIBLE MATERIALS HAVE ACCUMULATED. 2. IN EVERY STORAGE AND CONSTRUCTION SHED. 3. ADDITIONAL PORTABLE FIRE EXTINGUISHERS SHALL BE PROVIDED WHERE SPECIAL HAZARDS EXIST, SUCH AS THE STORAGE AND USE OF FLAMMABLE AND COMBUSTIBLE LIQUIDS SANITARY FACILITIES SHALL BE PROVIDED DURING CONSTRUCTION, REMODELING OR DEMOLITION

STRUCTURES UNDER CONSTRUCTION, ALTERATION OR DEMOLITION SHALL BE PROVIDED WITH NO FEWER THAN ONE APPROVED PORTABLE FIRE EXTINGUISHER IN ACCORDANCE WITH SECTION 906 AND SIZED FOR NOT LESS THAN ORDINARY HAZARD AS FOLLOWS: 1. AT EACH STAIRWAY ON ALL FLOOR

PROTECT EXISTING ITEMS WHICH ARE NOT INDICATED TO BE ALTERED.

CONTRACTOR TO REMOVE/DISPOSE OF ALL REMAINING FURNITURE

w w w . 3 8 7 7 . d e s i g n

COPYRIGHT NOTICE:

STUDIO3877 EXPRESSLY RESERVES ITS COMMON LAW COPYRIGHT AND OTHER PROPERTY RIGHTS TO THESE PLANS. THESE PLANS ARE NOT TO BE REPRODUCED, CHANGED, OR COPIED IN ANY FORM OR MANNER WHATSOEVER, NOR ARE THEY TO BE ASSIGNED TO ANY THIRD PARTY WITHOUT OBTAINING THE EXPRESS WRITTEN PERMISSION AND CONSENT OF STUDIO3877.

DAVID TRACZ, AIA, NCARB DAVID SHOVE BROWN, AIA, NCARB 3299 K STREET NW, SUITE 300 WASHINGTON DC 20007 [T] 202.350.4244

KHALID KHALIFA 8850 COLUMBIA 100 PARWAY SUITE 316 COLUMBIA, MD 21045 [T] 443.393.1070 [W] WWW.3877.DESIGN [W] WWW.KKDESIGN.COM STRUCTURAL ENGINEER: GAVIN & ASSOC. STRUCTURAL

MEP ENGINEER: KK ENGINEERING, LLC

<u>OWNER :</u> DISTRICT LINE DEVELOPMENT MATT MEDVENE **ENGINEERS** 31 HOBART AVE CHARLES GAVIN SUMMIT, NJ 07901 PO BOX 5142 [T] 703.589.4832 [W] WWW.

MCLEAN, VA 22103 [T] 703.409.1070 DISTRICTLINEDEVELOPMENT.COM [W] WWW.GAVINENGINEERING.COM <u>CIVIL ENGINEER :</u> HUSKA CONSULTING, LLC

CHRIS HUSKA 1050 30TH STREET NW WASHINGTON, DC 20007 [T] 702.425.3862 [W] WWW.HUSKACONSULTING.COM

ISSUE FOR BZA

DRAWING DATA

PROJECT: EASTERN AVE NE RESIDENCES ADDRESS: 1106-1112 EASTERN AVE NE **WASHINGTON, DC 20007**

SHEET SUBMISSION INDEX 100% SCHEMATIC DESIGN - 18 JUL 2025

 100% DESIGN DEVELOPMENT - 15 AUG 2025 100% BZA - 31 OCT 2025

REVISION

DATE

SEAL & SIGNATURE:

14. REQUIRED MEANS OF EGRESS SHALL BE MAINTAINED AT ALL TIMES DURING CONSTRUCTION,

THIS CODE AND THE APPLICABLE PROVISIONS OF CHAPTER 33 OF THE FIRE CODE

AUTOMATIC SPRINKLER SYSTEMS REQUIRED DURING CONSTRUCTION, ALTERATION AND

FIRE SAFETY DURING DEMOLITION SHALL COMPLY WITH THE APPLICABLE REQUIREMENTS OF

DEMOLITION OPERATIONS SHALL BE PROVIDED IN ACCORDANCE WITH CHAPTER 33 OF THE FIRE


= = = = = To be demolished

DEMOLITION, REMODELING OR ALTERATIONS AND ADDITIONS TO ANY BUILDING

I AM RESPONSIBLE FOR DETERMINING THAT THE ARCHITECTURAL DESIGN INCLUDED IN THIS APPLICATION ARE IN COMPLIANCE WITH ALL LAWS AND REGULATIONS OF THE DISTRICT OF COLUMBIA. I HAVE PERSONALLY PREPARED, OR DIRECTLY SUPERVISED THE DEVELOPMENT OF THE ARCHITECTURAL DESIGNS INCLUDED IN THIS APPLICATION.

SHEET TITLE: DEMOLITIONS DRAWINGS

PROJECT NO: 2025.76

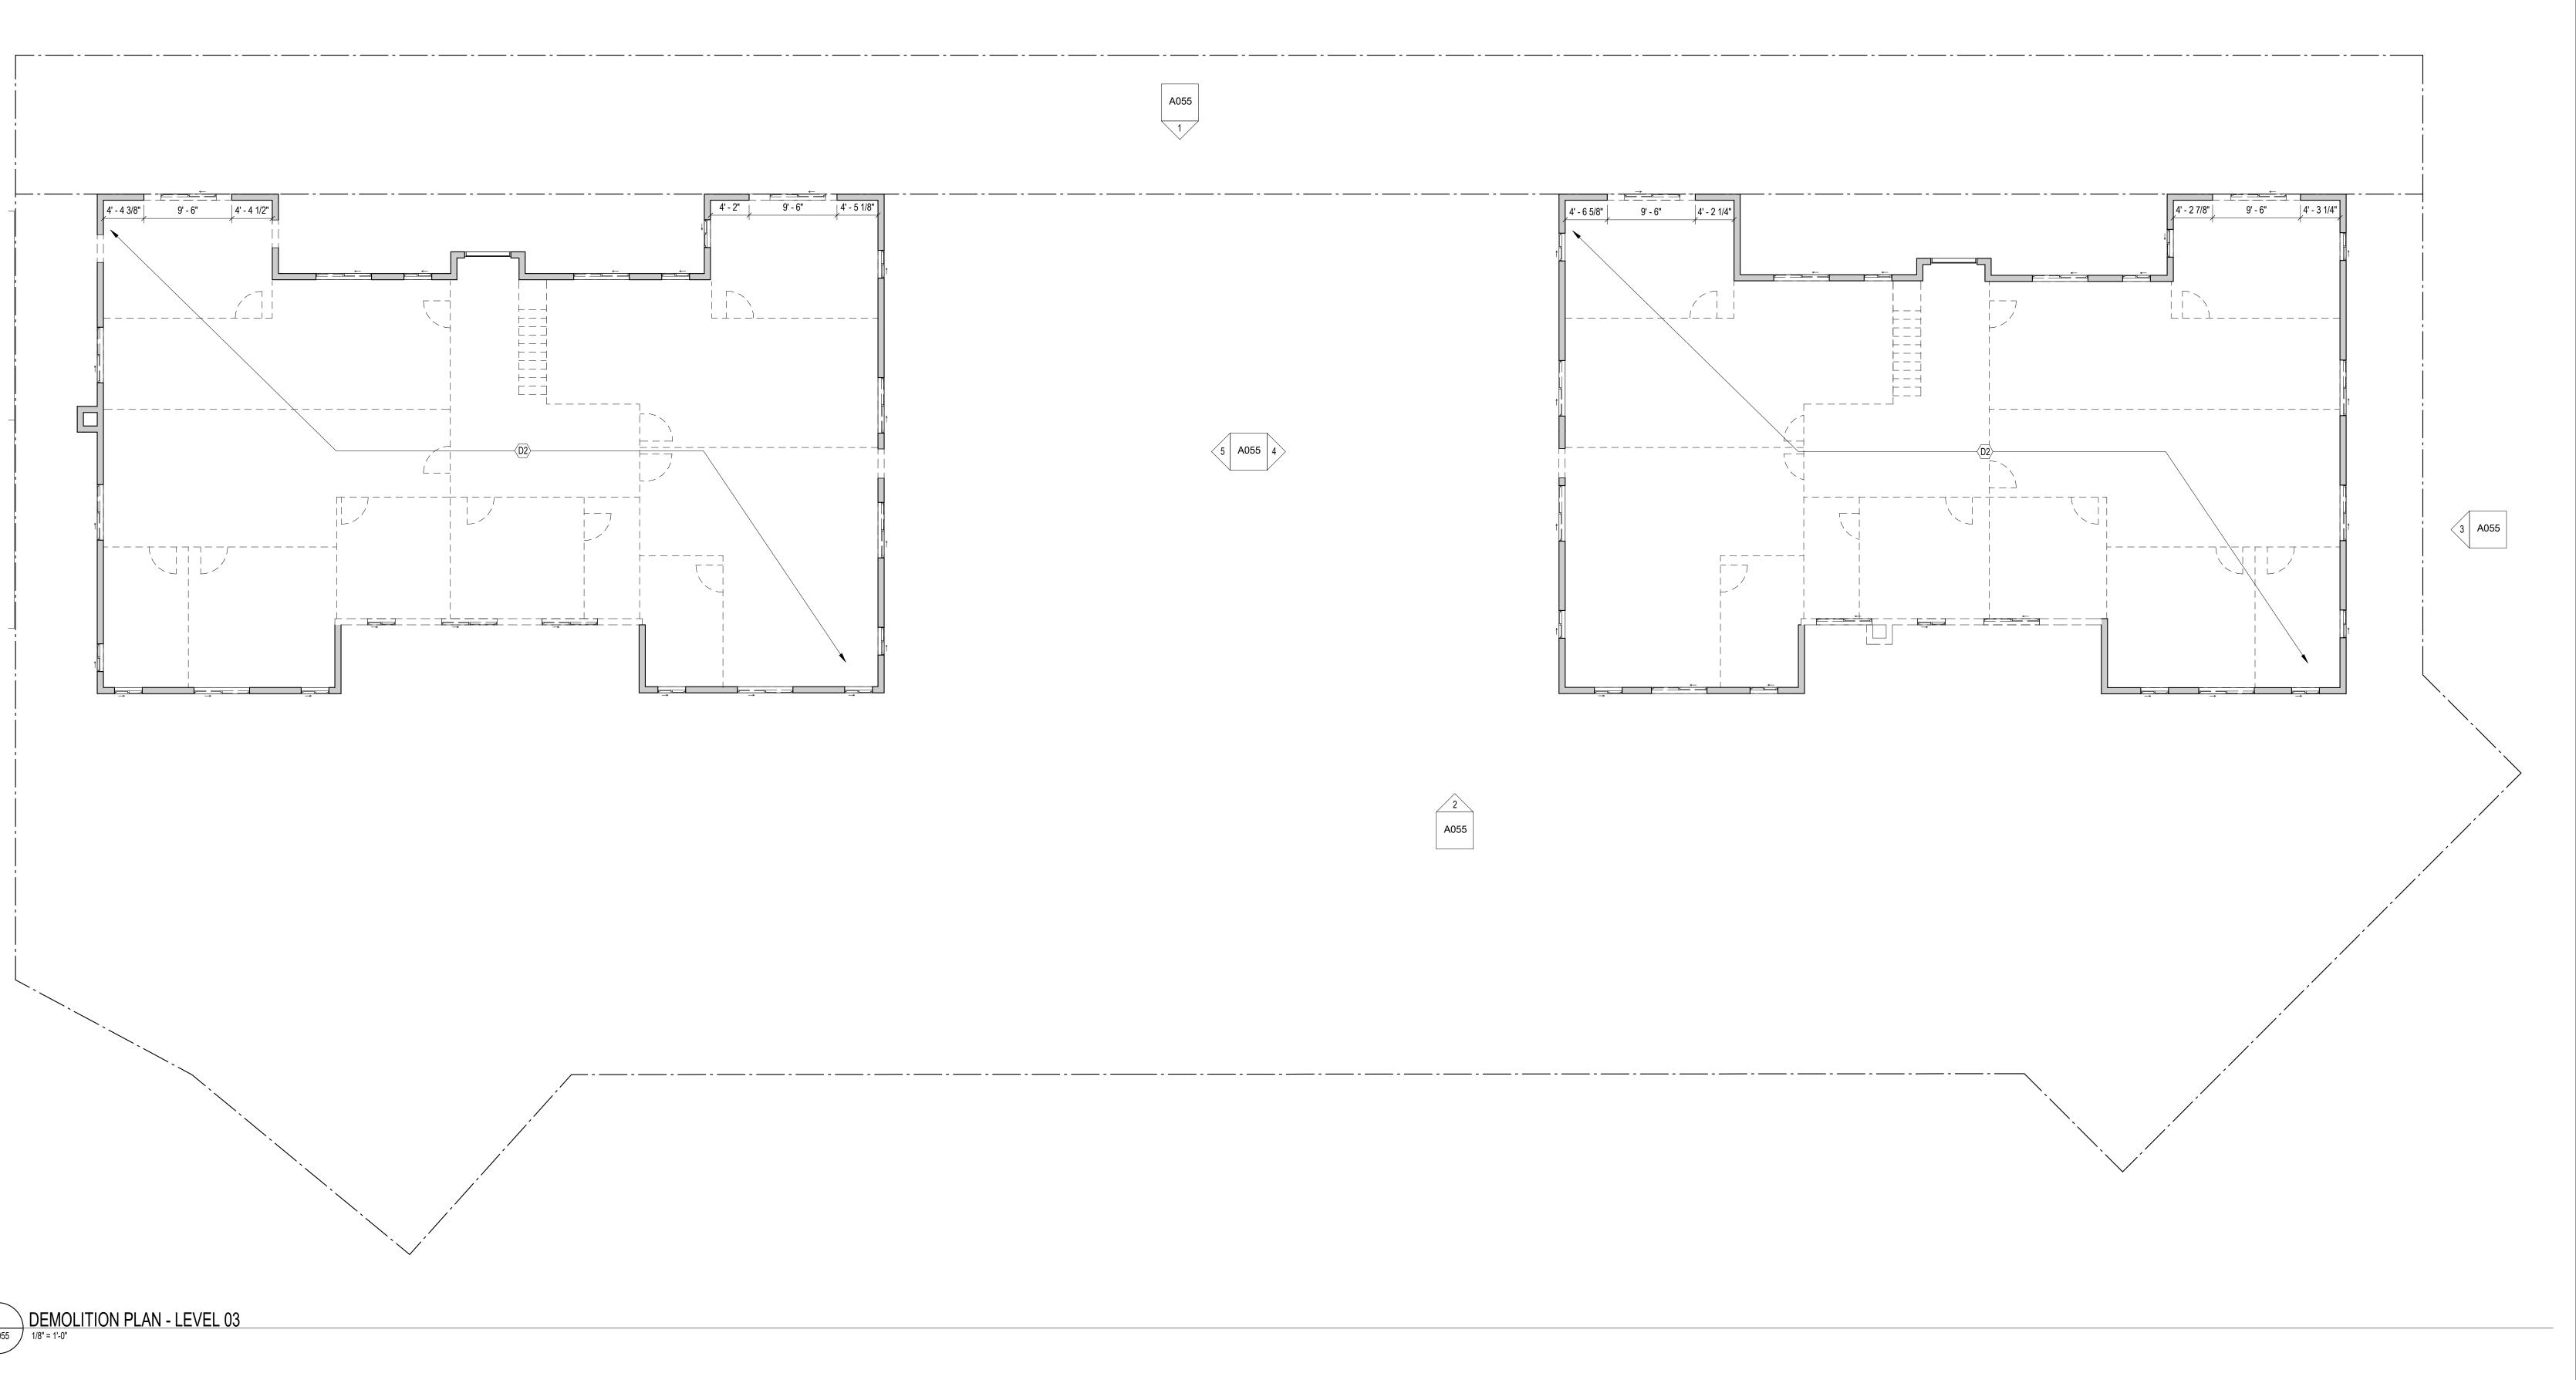

KEY NOTES - DEMOLITION

D3 DEMO BRICK WALL TO ALIGN WITH SILL OF EXISTING WINDOW. NOTIFY ARCHITECT OF

REMOVE ALL INTERIOR PARTITIONS, FINISHES, EQUIPMENT AND FIXTURES. FLOOR AND

REMOVE EXTERIOR WALL, SUPPORT WALLS TO REMAIN PER STRUCTURE

BEARING WALLS TO REMAIN TYP.

DESCREPANCIES.

D4 CHIMNEY TO BE CAPPED

w w w . 3 8 7 7 . d e s i g n

COPYRIGHT NOTICE:

STUDIO3877 EXPRESSLY RESERVES ITS COMMON LAW COPYRIGHT AND OTHER PROPERTY RIGHTS TO THESE PLANS. THESE PLANS ARE NOT TO BE REPRODUCED, CHANGED, OR COPIED IN ANY FORM OR MANNER WHATSOEVER, NOR ARE THEY TO BE ASSIGNED TO ANY THIRD PARTY WITHOUT OBTAINING THE EXPRESS WRITTEN PERMISSION AND CONSENT OF STUDIO3877.

> **MEP ENGINEER:** KK ENGINEERING, LLC KHALID KHALIFA

8850 COLUMBIA 100 PARWAY

[W] WWW.KKDESIGN.COM

ARCHITECT: DAVID TRACZ, AIA, NCARB DAVID SHOVE BROWN, AIA, NCARB 3299 K STREET NW, SUITE 300 WASHINGTON DC 20007 [T] 202.350.4244

SUITE 316 COLUMBIA, MD 21045 [T] 443.393.1070 [W] WWW.3877.DESIGN <u>OWNER :</u> DISTRICT LINE DEVELOPMENT MATT MEDVENE 31 HOBART AVE

STRUCTURAL ENGINEER: GAVIN & ASSOC. STRUCTURAL **ENGINEERS** CHARLES GAVIN SUMMIT, NJ 07901 PO BOX 5142 MCLEAN, VA 22103 [T] 703.589.4832 [T] 703.409.1070 DISTRICTLINEDEVELOPMENT.COM [W] WWW.GAVINENGINEERING.COM

<u>CIVIL ENGINEER :</u> HUSKA CONSULTING, LLC CHRIS HUSKA 1050 30TH STREET NW WASHINGTON, DC 20007 [T] 702.425.3862 [W] WWW.HUSKACONSULTING.COM

[W] WWW.

ISSUE FOR BZA

DRAWING DATA

PROJECT: EASTERN AVE NE RESIDENCES ADDRESS: 1106-1112 EASTERN AVE NE **WASHINGTON, DC 20007**

DATE

SHEET SUBMISSION INDEX 100% SCHEMATIC DESIGN - 18 JUL 2025

 100% DESIGN DEVELOPMENT - 15 AUG 2025 100% BZA - 31 OCT 2025

REVISION

SEAL & SIGNATURE:

14. REQUIRED MEANS OF EGRESS SHALL BE MAINTAINED AT ALL TIMES DURING CONSTRUCTION,

THIS CODE AND THE APPLICABLE PROVISIONS OF CHAPTER 33 OF THE FIRE CODE

AUTOMATIC SPRINKLER SYSTEMS REQUIRED DURING CONSTRUCTION, ALTERATION AND

FIRE SAFETY DURING DEMOLITION SHALL COMPLY WITH THE APPLICABLE REQUIREMENTS OF

DEMOLITION OPERATIONS SHALL BE PROVIDED IN ACCORDANCE WITH CHAPTER 33 OF THE FIRE

= = = = = To be demolished

DEMOLITION, REMODELING OR ALTERATIONS AND ADDITIONS TO ANY BUILDING

I AM RESPONSIBLE FOR DETERMINING THAT THE ARCHITECTURAL DESIGN INCLUDED IN THIS APPLICATION ARE IN COMPLIANCE WITH ALL LAWS AND REGULATIONS OF THE DISTRICT OF COLUMBIA. I HAVE PERSONALLY PREPARED, OR DIRECTLY SUPERVISED THE DEVELOPMENT OF THE ARCHITECTURAL DESIGNS INCLUDED IN THIS APPLICATION.

SHEET TITLE: DEMOLITIONS DRAWINGS

PROJECT NO: 2025.76

SCALE: As indicated

DEMOLITION NOTES

CONTRACTOR SHALL VISIT SITE TO DETERMINE AND VERIFY ALL EXISTING CONDITIONS. PROTECT EXISTING ITEMS WHICH ARE NOT INDICATED TO BE ALTERED.

REMOVE EXISTING PARTITIONS, U.N.O.

REMOVE DOORS, FRAMES AND HARDWARE, U.N.O. REMOVE EXISTING WINDOWS AS NOTED.

REMOVE ALL APPLIANCES THROUGHOUT, U.N.O. REMOVE PLUMBING FIXTURES THROUGHOUT, U.N.O.

REMOVE ALL BRANCH WIRING REMOVED BACK TO PANEL (IDENTIFY AS SPARE) OR NEAREST JUNCTION BOX UNLESS NOTED OTHERWISE. CONTRACTOR TO REMOVE/DISPOSE OF ALL REMAINING FURNITURE

REMOVE LIGHT FIXTURES THROUGHOUT, U.N.O. REMOVE ALL EXISTING FLOORS SUPPORT EXTERIOR WALLS AS REQUIRED BY STRUCTURE. STRUCTURES UNDER CONSTRUCTION, ALTERATION OR DEMOLITION SHALL BE PROVIDED WITH NO

FEWER THAN ONE APPROVED PORTABLE FIRE EXTINGUISHER IN ACCORDANCE WITH SECTION 906 AND SIZED FOR NOT LESS THAN ORDINARY HAZARD AS FOLLOWS: 1. AT EACH STAIRWAY ON ALL FLOOR LEVELS WHERE COMBUSTIBLE MATERIALS HAVE ACCUMULATED. 2. IN EVERY STORAGE AND CONSTRUCTION SHED. 3. ADDITIONAL PORTABLE FIRE EXTINGUISHERS SHALL BE PROVIDED WHERE SPECIAL HAZARDS EXIST, SUCH AS THE STORAGE AND USE OF FLAMMABLE AND COMBUSTIBLE LIQUIDS

SANITARY FACILITIES SHALL BE PROVIDED DURING CONSTRUCTION, REMODELING OR DEMOLITION ACTIVITIES IN ACCORDANCE WITH THE PLUMBING CODE



w w w . 3 8 7 7 . d e s i g n

COPYRIGHT NOTICE:

STUDIO3877 EXPRESSLY RESERVES ITS COMMON LAW COPYRIGHT AND OTHER PROPERTY RIGHTS TO THESE PLANS. THESE PLANS ARE NOT TO BE REPRODUCED CHANGED, OR COPIED IN ANY FORM OR MANNER WHATSOEVER, NOR ARE THEY TO BE ASSIGNED TO ANY THIRD PARTY WITHOUT OBTAINING THE EXPRESS WRITTEN PERMISSION AND CONSENT OF STUDIO3877.

ARCHITECT : DAVID TRACZ, AIA, NCARB DAVID SHOVE BROWN, AIA, NCARB 3299 K STREET NW, SUITE 300 WASHINGTON DC 20007

[T] 202.350.4244 [W] WWW.3877.DESIGN OWNER : DISTRICT LINE DEVELOPMENT MATT MEDVENE 31 HOBART AVE SUMMIT, NJ 07901

STRUCTURAL ENGINEER GAVIN & ASSOC. STRUCTURAL **ENGINEERS** CHARLES GAVIN PO BOX 5142 MCLEAN, VA 22103 [T] 703.409.1070 [W] WWW.GAVINENGINEERING.COM

MEP ENGINEER :

KHALID KHALIFA

SUITE 316

KK ENGINEERING, LLC

COLUMBIA, MD 21045

[T] 443.393.1070

8850 COLUMBIA 100 PARWAY

[W] WWW.KKDESIGN.COM

<u>CIVIL ENGINEER :</u> HUSKA CONSULTING, LLC CHRIS HUSKA 1050 30TH STREET NW WASHINGTON, DC 20007 [T] 702.425.3862

ISSUE FOR BZA

DRAWING DATA

PROJECT: EASTERN AVE NE RESIDENCES ADDRESS: 1106-1112 EASTERN AVE NE **WASHINGTON, DC 20007**

SHEET SUBMISSION INDEX 100% SCHEMATIC DESIGN - 18 JUL 2025

100% DESIGN DEVELOPMENT - 15 AUG 2025

100% BZA - 31 OCT 2025

REVISION REV NO.


DATE

I AM RESPONSIBLE FOR DETERMINING THAT THE ARCHITECTURAL DESIGN INCLUDED IN THIS APPLICATION ARE IN COMPLIANCE WITH ALL LAWS AND REGULATIONS OF THE DISTRICT OF COLUMBIA. I HAVE PERSONALLY PREPARED, OR DIRECTLY SUPERVISED THE DEVELOPMENT OF THE ARCHITECTURAL DESIGNS INCLUDED IN THIS

APPLICATION.

SHEET TITLE: DEMOLITION ELEVATIONS

PROJECT NO: 2025.76

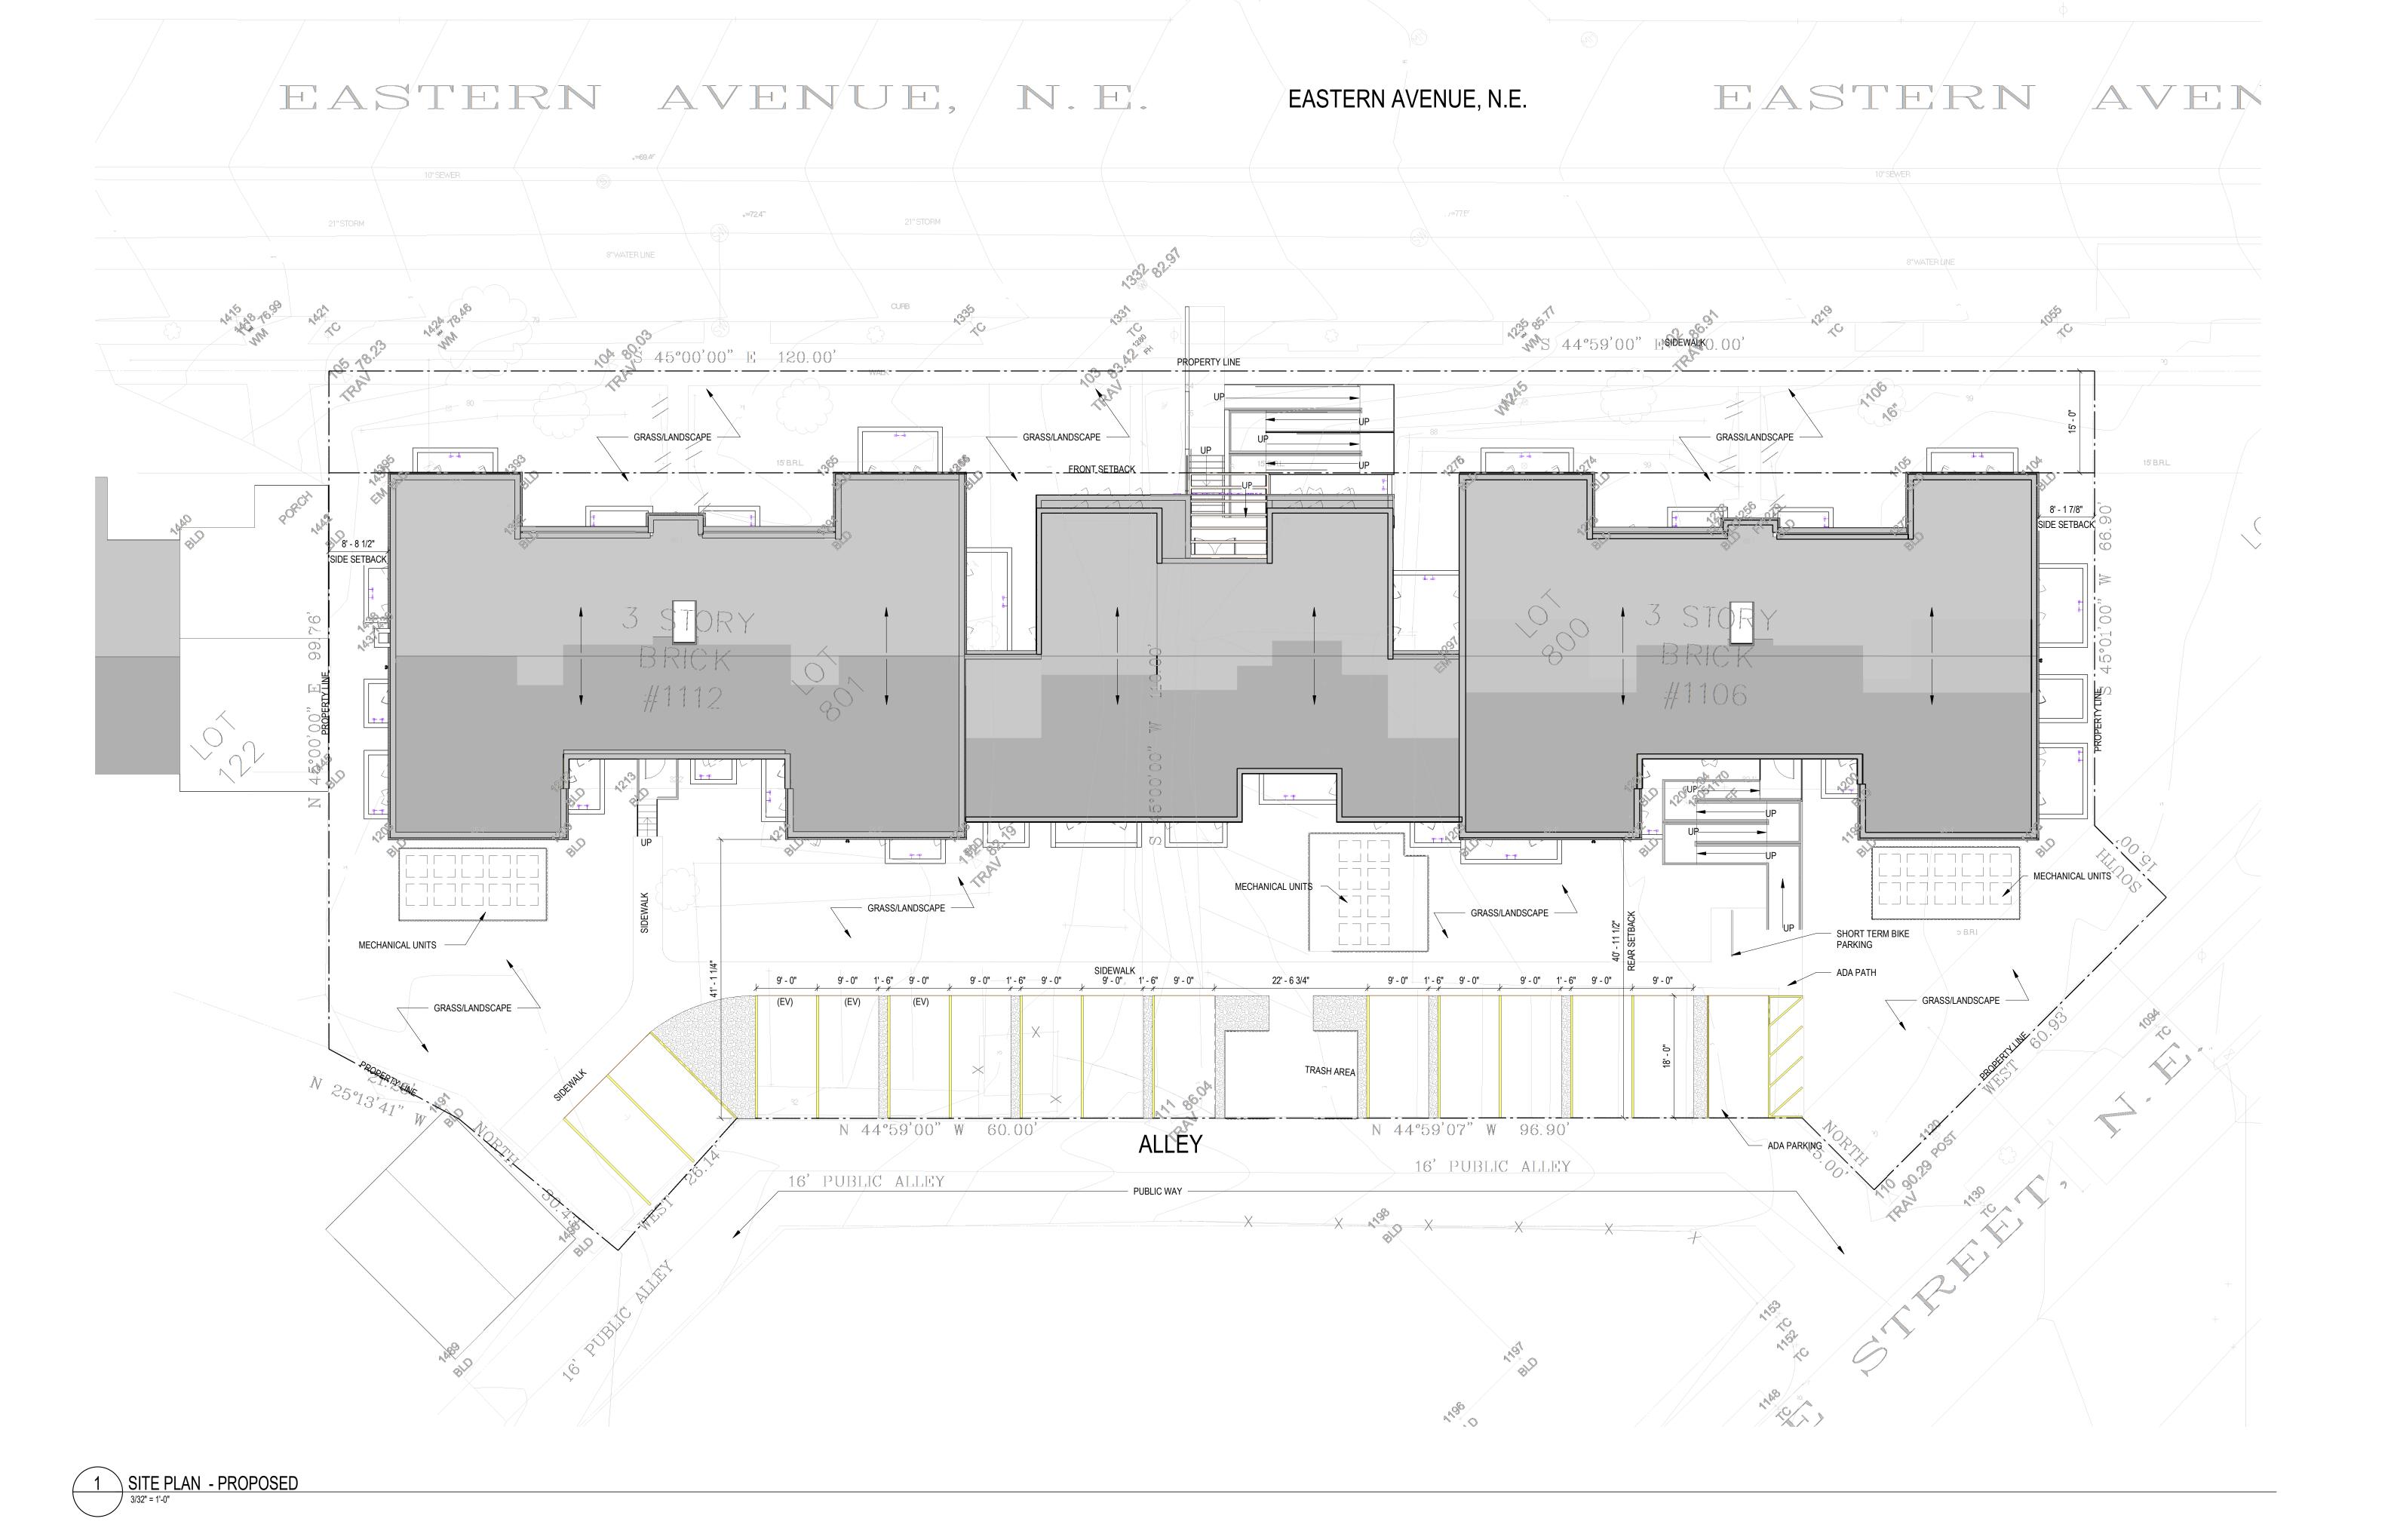

FINISH SCHEDULE

FINISH NO.	DESCRIPTION
LVT-01	LUXURY VINYL TILE
PT-01	GENERAL WALL PAINT
SF-01	MINCEY MARBLE SHOWER SURROUND
TL-01	TILE FLOORING - 12"X24"
TL-1B	MATCHING BASE TILE

ALL FLOORING TO BE LVT. ALL WALLS TO BE PAINTED. ALL BATHROOMS TO HAVE TILE FLOORS AND CULTURED MARBLE SURROUNDS.

*A108.2 APPENDIX A - FLOORING MATERIAL PROJECT ELECTIVE. WHERE PROJECTS ARE INTENDED TO QUALIFY FOR A "FLOORING MATERIAL" PROJECT ELECTIVE, ALL FLOORING INSTALLED WITHIN THE INTERIOR OF THE BUILDING SHALL COMPLY WITH SECTION 806.4 OR SHALL BE ONE OR MORE OF THE FOLLOWING FLOORING MATERIALS THAT ARE DEEMED TO COMPLY WITH VOC EMISSION LIMITS: 1. CERAMIC AND CONCRETE TILE 2. CLAY PAVERS 3. CONCRETE 4. CONCRETE PAVERS 5. METAL 6. ORGANIC-FREE, MINERAL-BASED

*A108.5 APPENDIX A TOTAL VOC LIMIT PROJECT ELECTIVE. WHERE PROJECTS ARE INTENDED TO QUALIFY FOR A "TOTAL VOC LIMIT" PROJECT ELECTIVE IN ACCORDANCE WITH A MINIMUM OF 50 PERCENT OF ALL ADHESIVES AND SEALANTS, ARCHITECTURAL PAINTS AND COATINGS, FLOORING, ACOUSTICAL CEILING TILES AND WALL SYSTEMS AND INSULATION SHALL HAVE A TOTAL VOLATILE ORGANIC COMPOUNDS (TVOCS) EMISSION LIMIT OF ? 500 UG/M³. THE TEST METHODOLOGY USED TO DETERMINE COMPLIANCE SHALL BE FROM CDPH/EHLB/STANDARD METHOD V.1.1. THE EMISSIONS TESTING SHALL BE PERFORMED BY A LABORATORY THAT HAS THE

CDPH/EHLB/STANDARD METHOD V.1.1 TEST METHODOLOGY IN THE SCOPE OF ITS ISO 17025

ACCREDITATION.

*A108.8 APPENDIX A POST-CONSTRUCTION, PRE-OCCUPANCY BASELINE IAQ TESTING. WHERE PROJECTS ARE INTENDED TO QUALIFY FOR THIS PROJECT ELECTIVE, AFTER ALL INTERIOR FINISHES ARE INSTALLED, THE BUILDING SHALL BE TESTED FOR INDOOR AIR QUALITY AND THE TESTING RESULTS SHALL INDICATE THAT THE LEVELS OF VOCS MEET THE LEVELS DETAILED IN TABLE A108.8 USING TESTING PROTOCOLS IN ACCORDANCE WITH

ASTM D 6196, ASTM D 5466, ASTM D 5197, ASTM D 6345, AND ISO 7708. TEST SAMPLES SHALL BE TAKEN IN NOT LESS THAN ONE LOCATION IN EACH 25,000 SQUARE FEET (1860 M2) OF FLOOR AREA OR IN EACH CONTIGUOUS FLOOR AREA.

INTERIOR FINISHES (PER DCBC TABLE 803.11)

CLASS A = FLAME SPREAD INDEX 0-25; SMOKE-DEVELOPED INDEX 0-450
CLASS B = FLAME SPREAD INDEX 26-75; SMOKE-DEVELOPED INDEX 0-450
CLASS C = FLAME SPREAD INDEX 76-200; SMOKE-DEVELOPED INDEX 0-450
OCCUPANCY GROUP A-2, SPRINKLERED (MOST RESTRICTIVE)
INTERIOR EXIT STAIRWAYS, INTERIOR EXIT RAMPS AND EXIT PASSAGEWAYS: CLASS B
CORRIDORS AND ENCLOSURE FOR EXIT ACCESS STAIRWAYS AND EXIT ACCESS RAMPS:

CLASS B ROOMS AND ENCLOSED SPACES: CLASS C A. CLASS C INTERIOR FINISH MATERIALS SHALL BE PERMITTED FOR WAINSCOTTING OR PANELING OF NOT MORE THAN 1,000 SQUARE FEET OF APPLIED SURFACE AREA IN THE GRADE LOBBY WHERE APPLIED DIRECTLY TO A NONCOMBUSTIBLE BASE OR OVER FURRING STRIPS APPLIED TO A NONCOMBUSTIBLE BASE AND FIREBLOCKED AS REQUIRED BY SECTION 803.13.1. B. IN OTHER THAN GROUP I-3 OCCUPANCIES IN BUILDINGS LESS THAN THREE STORIES ABOVE GRADE PLANE, CLASS B INTERIOR FINISH FOR NONSPRINKLERED BUILDINGS AND CLASS C INTERIOR FINISH FOR SPRINKLERED BUILDINGS SHALL BE PERMITTED IN INTERIOR EXIT STAIRWAYS AND RAMPS. C. REQUIREMENTS FOR ROOMS AND ENCLOSED SPACES SHALL BE BASED UPON SPACES ENCLOSED BY PARTITIONS. WHERE A FIRE-RESISTANCE RATING IS REQUIRED FOR STRUCTURAL ELEMENTS, THE ENCLOSING PARTITIONS SHALL EXTEND FROM THE FLOOR TO THE CEILING. PARTITIONS THAT DO NOT COMPLY WITH THIS SHALL BE CONSIDERED ENCLOSING SPACES AND THE ROOMS OR SPACES ON BOTH SIDES SHALL BE CONSIDERED ONE. IN DETERMINING THE APPLICABLE REQUIREMENTS FOR ROOMS AND ENCLOSED SPACES, THE SPECIFIC OCCUPANCY THEREOF SHALL BE THE GOVERNING FACTOR REGARDLESS OF THE GROUP CLASSIFICATION OF THE BUILDING OR STRUCTURE. D. LOBBY AREAS IN GROUP A-1, A-2 AND A-3 OCCUPANCIES SHALL NOT BE LESS THAN CLASS B E. CLASS C INTERIOR FINISH MATERIALS SHALL BE PERMITTED IN PLACES OF ASSEMBLY WITH AN OCCUPANT LOAD OF 300 PERSONS OR LESS.

CONSTRUCTION GENERAL NOTES

- ALL DIMENSIONS TO FINISH FACE, U.N.O.
 ALL INTERIOR PARTITIONS TO BE TYPE A, U.N.O. SEE SHEET A010 FOR PARTITION SCHEDULE
 ALL INTERIOR WALLS TO BE PAINTED. U.N.O.
- ALL INTERIOR WALLS TO BE PAINTED, U.N.O. ALL CEILINGS TO BE 5/8" GWB - PAINTED - FLAT FINISH
- 5. ALL WALLS TO BE PAINTED EGGSHELL FINISH
 6. REPAIR ALL WALLS EXISTING TO REMAIN AS REQUIRED
- PROVIDE ARC-FAULT PROTECTION FOR ALL LIVING SPACE OUTLETS TO COMPLY
 ALL FLOORING TO BE LVT OR SIMILAR SPECIFIED BY OWNER, U.N.O.
 GC TO VERIFY INSULATION OF EXISTING EXTERIOR WALLS TO REMAIN MEETS R8/13 ACCORDING.
- GC TO VERIFY INSULATION OF EXISTING EXTERIOR WALLS TO REMAIN MEETS R8/13 ACCORDING
 TO 2017 IECC 402.1.1
 AIR LEAKAGE RATE NOT TO EXCEED 3 AIR CHANGES PER HOUR. GC TO TEST BUILDING THERMAL 18.
- ENVELOP IN ACCORDANCE WITH 2017 IECC 402.4.1.2

 11. GC TO PROVIDE NO FEWER THAN ONE APPROVE PORTABLE FIRE EXTINGUISHERS IN ACCORDANCE WITH SECTION 906. AREAS TO HAVE FIRE EXTIGUISHERS AS FOLLOWS: EA. STAIRWAY FLOOR LEVEL, STORAGE AND CONSTRUCTION SHED, WHERE SPECIAL HAZARDS EXIST.
- STAIRWAY FLOOR LEVEL, STORAGE AND CONSTRUCTION SHED, WHERE SPECIAL HAZARDS EXIST.

 SEE PLAN FOR FIRE EXTINGUISHER (F.E.) LOCATIONS.

 C. GC TO PROVIDE PORTABLE FIRE EXTINGUISHERS IN ALL KITCHEN AREAS. (F.E) CLASS A RATING
 TYPE, 2.5 LB 6"X4"X16"; HARDWARE INSTALLED AT 48" AFF. MAX.
- HANDRAILS AND GUARDS SHALL BE DESIGNED TO RESIST A LINEAR LOAD OF 50 POUNDS PER LINEAR FOOT (PLF) (0.73 KN/M).
 HANDRAILS AND GUARDS SHALL BE DESIGNED TO RESIST A CONCENTRATED LOAD OF 200 POUNDS (9.99 MA).
- GRAB BARS, SHOWER SEATS AND DRESSING ROOM BENCH SEATS SHALL BE DESIGNED TO RESIST A SINGLE CONCENTRATED LOAD OF 250 POUNDS (1.11 KN) APPLIED IN ANY DIRECTION AT ANY POINT ON THE GRAB BAR OR SEAT SO AS TO PRODUCE THE MAXIMUM LOAD EFFECTS
- 16. ACCESSORIES SUCH AS GRAB BARS, TOWEL BARS, PAPER DISPENSERS AND SOAP DISHES,
 PROVIDED ON OR WITHIN WALLS, SHALL BE INSTALLED AND SEALED TO PROTECT STRUCTURAL
 ELEMENTS FROM MOISTURE

 17. ALL WET AREAS TO BE PAINTED WITH SHERWIN WILLIAMS EMERALD INTERIOR PAINT, SEMI GLOSS, PRODUCT NUMBER: K38W00351 (OR SIMILAR); PAINT OFFERS WASHABILITY, PREVENTS
- STAINS FROM PENETRATING, AND CONTAINS PROPERTIES THAT INHIBIT THE GROWTH OF MOLD AND MILDEW ON THE SURFACE

 8. FRONT LOAD WASHER/DRYER COMBO UNIT. UNIT TO MEET REQUIREMENTS OF 2017 ICC SECTION
- 611
 19. GC TO PROVIDE EXTERIOR SIGNAGE PER 2017 DCBC 501.2

EXISTING TO REMAIN NEW CONSTRUCTION

3877. de sign

COPYRIGHT NOTICE:

STUDIO3877 EXPRESSLY RESERVES ITS COMMON LAW COPYRIGHT AND OTHER PROPERTY RIGHTS TO THESE PLANS. THESE PLANS ARE NOT TO BE REPRODUCED, CHANGED, OR COPIED IN ANY FORM OR MANNER WHATSOEVER, NOR ARE THEY TO BE ASSIGNED TO ANY THIRD PARTY WITHOUT OBTAINING THE EXPRESS WRITTEN

ARCHITECT:
//3877
DAVID TRACZ, AIA, NCARB
DAVID SHOVE BROWN, AIA, NCARB
3299 K STREET NW, SUITE 300
WASHINGTON DC 20007
[T] 202.350.4244
[W] WWW.3877.DESIGN

WASHINGTON DC 20007

[T] 202.350.4244

[W] WWW.3877.DESIGN

OWNER:

DISTRICT LINE DEVELOPMENT
MATT MEDVENE
31 HOBART AVE
SUMMIT NJ 07901

COLUMBIA, MD 21045

[T] 443.393.1070

[W] WWW.KKDESIGN.COM

STRUCTURAL ENGINEER

GAVIN & ASSOC. STRUCT

ENGINEERS
CHARLES GAVIN
PO BOX 5142

MCLEAN, VA 22103

CIVIL ENGINEER:
HUSKA CONSULTING, LLC
CHRIS HUSKA
1050 30TH STREET NW
WASHINGTON, DC 20007
[T] 702.425.3862
[W] WWW.HUSKACONSULTING.COM

ISSUE FOR BZA

DRAWING DATA

PROJECT: EASTERN AVE NE RESIDENCES
ADDRESS: 1106-1112 EASTERN AVE NE
WASHINGTON, DC 20007

SHEET SUBMISSION INDEX
100% SCHEMATIC DESIGN - 18 JUL 2025

100% DESIGN DEVELOPMENT - 15 AUG 2025
 100% BZA - 31 OCT 2025

REV NO. REVISION DATE

CEAL 9

I AM RESPONSIBLE FOR DETERMINING THAT THE ARCHITECTURAL DESIGN INCLUDED IN THIS APPLICATION ARE IN COMPLIANCE WITH ALL LAWS AND REGULATIONS OF THE DISTRICT OF COLUMBIA. I HAVE PERSONALLY PREPARED, OR DIRECTLY SUPERVISED THE

DEVELOPMENT OF THE ARCHITECTURAL DESIGNS INCLUDED IN THIS

APPLICATION.


SHEET TITLE: PROPOSED SITE PLAN

SCALE: As indicated

PROJECT NO: 2025.76

A100



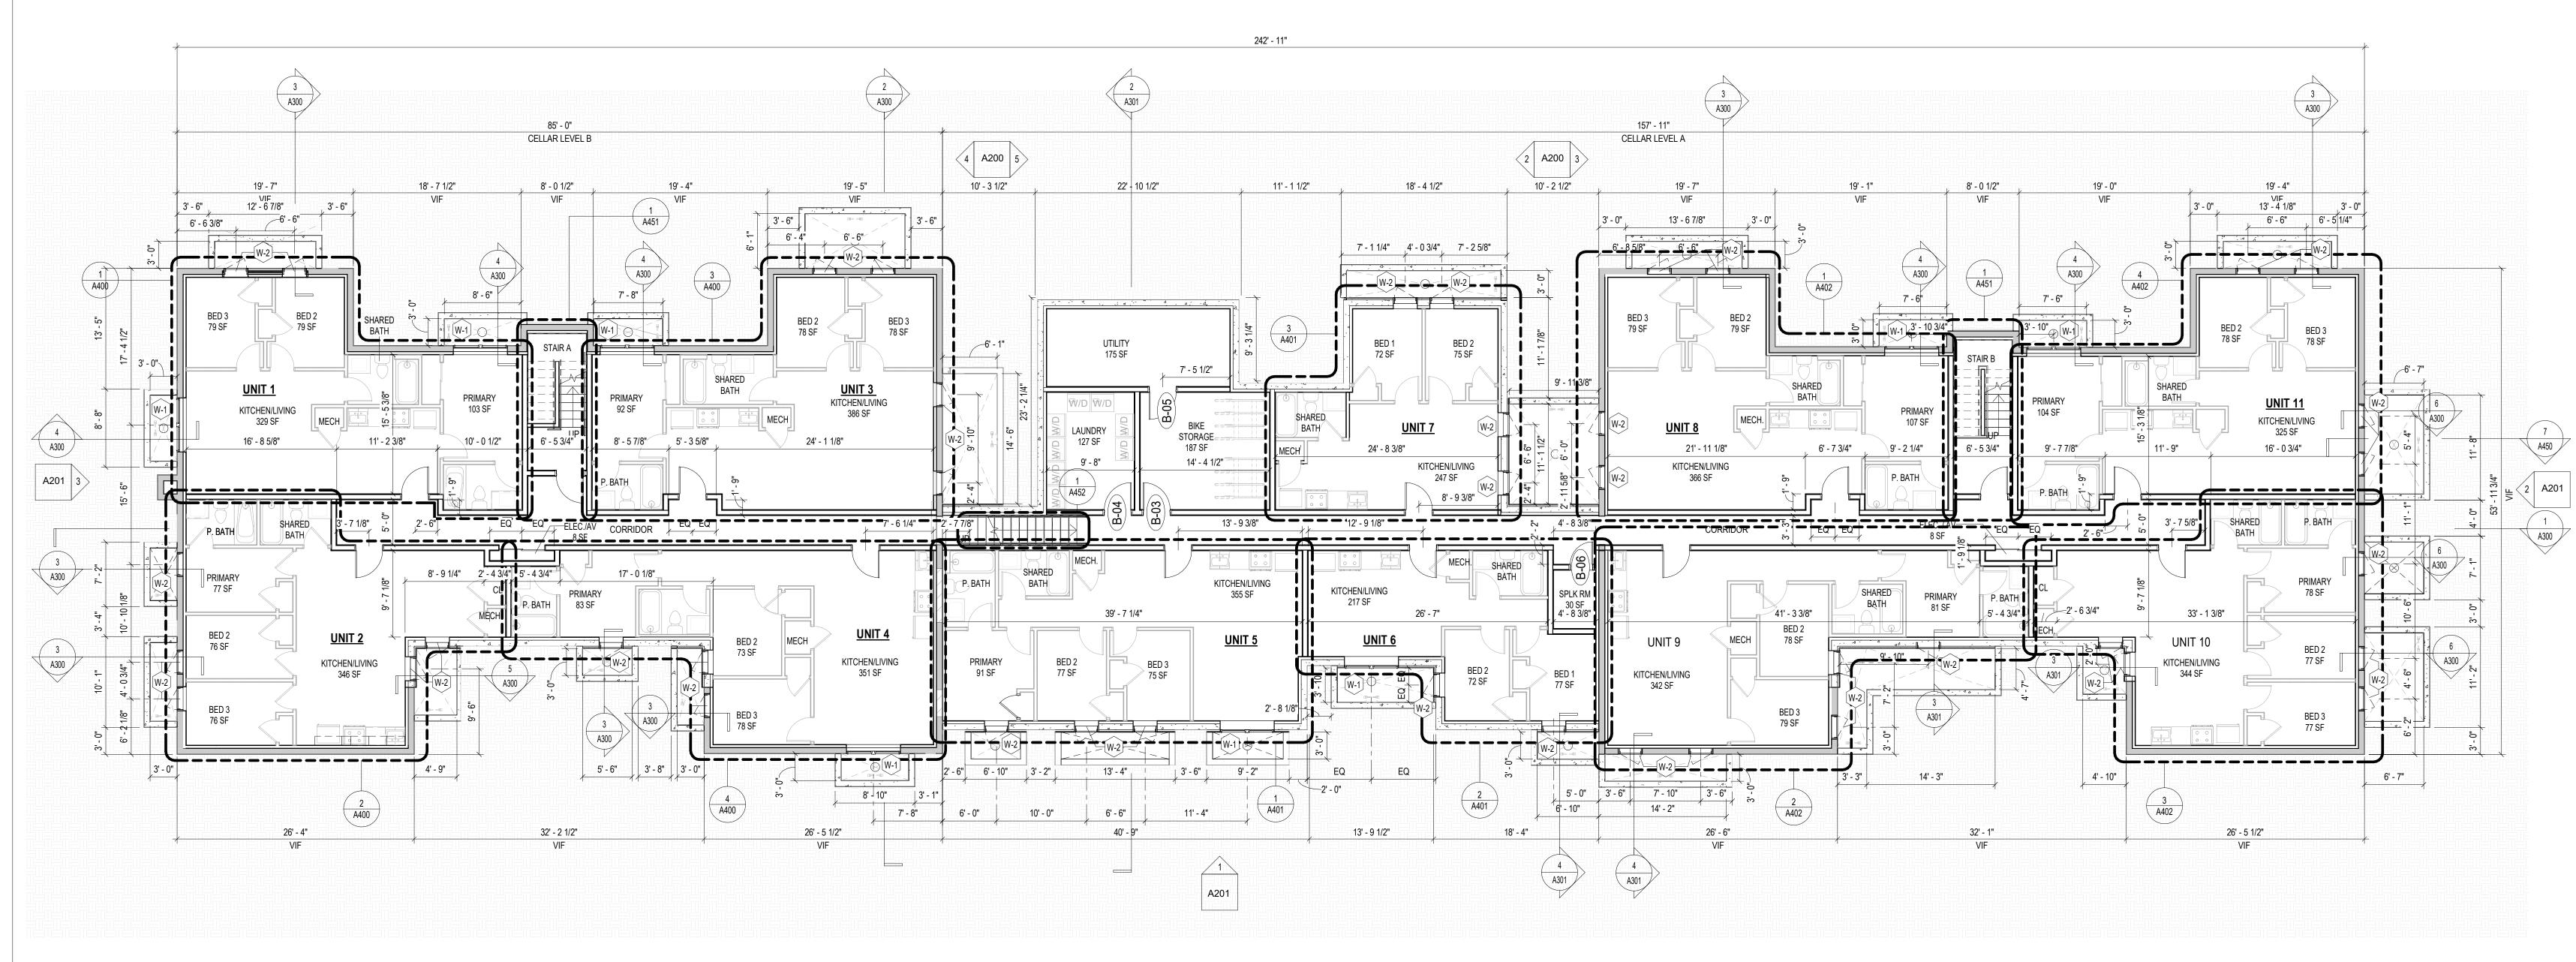

FINISH NO.	DESCRIPTION
LVT-01	LUXURY VINYL TILE
PT-01	GENERAL WALL PAINT
SF-01	MINCEY MARBLE SHOWER SURROUND
TL-01	TILE FLOORING - 12"X24"
TL-1B	MATCHING BASE TILE

*A108.2 APPENDIX A - FLOORING MATERIAL PROJECT ELECTIVE. WHERE PROJECTS ARE INTENDED TO QUALIFY FOR A "FLOORING MATERIAL" PROJECT ELECTIVE, ALL FLOORING INSTALLED WITHIN THE INTERIOR OF THE BUILDING SHALL COMPLY WITH SECTION 806.4 OR SHALL BE ONE OR MORE OF THE FOLLOWING FLOORING MATERIALS THAT ARE DEEMED TO COMPLY WITH VOC EMISSION LIMITS: 1. CERAMIC AND CONCRETE TILE 2. CLAY PAVERS 3. CONCRETE 4. CONCRETE PAVERS 5. METAL 6. ORGANIC-FREE, MINERAL-

*A108.5 APPENDIX A TOTAL VOC LIMIT PROJECT ELECTIVE. WHERE PROJECTS ARE INTENDED TO QUALIFY FOR A "TOTAL VOC LIMIT" PROJECT ELECTIVE IN ACCORDANCE WITH A MINIMUM OF 50 PERCENT OF ALL ADHESIVES AND SEALANTS, ARCHITECTURAL PAINTS AND COATINGS, FLOORING, ACOUSTICAL CEILING TILES AND WALL SYSTEMS AND INSULATION SHALL HAVE A TOTAL VOLATILE ORGANIC COMPOUNDS (TVOCS) EMISSION LIMIT OF ? 500 UG/M3. THE TEST METHODOLOGY USED TO DETERMINE COMPLIANCE SHALL BE FROM CDPH/EHLB/STANDARD METHOD V.1.1. THE EMISSIONS TESTING SHALL BE PERFORMED BY A LABORATORY THAT HAS THE

ACCREDITATION. *A108.8 APPENDIX A POST-CONSTRUCTION, PRE-OCCUPANCY BASELINE IAQ TESTING. WHERE PROJECTS ARE INTENDED TO QUALIFY FOR THIS PROJECT ELECTIVE, AFTER ALL INTERIOR FINISHES ARE INSTALLED, THE BUILDING SHALL BE TESTED FOR INDOOR AIR QUALITY AND THE TESTING RESULTS SHALL INDICATE THAT THE LEVELS OF VOCS MEET THE LEVELS DETAILED IN TABLE A108.8 USING TESTING PROTOCOLS IN ACCORDANCE WITH ASTM D 6196, ASTM D 5466, ASTM D 5197, ASTM D 6345, AND ISO 7708. TEST SAMPLES SHALL BE TAKEN IN NOT LESS THAN ONE LOCATION IN EACH 25,000 SQUARE FEET (1860 M2) OF FLOOR AREA OR IN EACH CONTIGUOUS FLOOR AREA.

CDPH/EHLB/STANDARD METHOD V.1.1 TEST METHODOLOGY IN THE SCOPE OF ITS ISO 17025

INTERIOR FINISHES (PER DCBC TABLE 803.11)

CLASS A = FLAME SPREAD INDEX 0-25; SMOKE-DEVELOPED INDEX 0-450 CLASS B = FLAME SPREAD INDEX 26-75; SMOKE-DEVELOPED INDEX 0-450 CLASS C = FLAME SPREAD INDEX 76-200; SMOKE-DEVELOPED INDEX 0-450 OCCUPANCY GROUP A-2, SPRINKLERED (MOST RESTRICTIVE) INTERIOR EXIT STAIRWAYS, INTERIOR EXIT RAMPS AND EXIT PASSAGEWAYS: CLASS B CORRIDORS AND ENCLOSURE FOR EXIT ACCESS STAIRWAYS AND EXIT ACCESS RAMPS:

CLASS B ROOMS AND ENCLOSED SPACES: CLASS C A. CLASS C INTERIOR FINISH MATERIALS SHALL BE PERMITTED FOR WAINSCOTTING OR PANELING OF NOT MORE THAN 1,000 SQUARE FEET OF APPLIED SURFACE AREA IN THE GRADE LOBBY WHERE APPLIED DIRECTLY TO A NONCOMBUSTIBLE BASE OR OVER FURRING STRIPS APPLIED TO A NONCOMBUSTIBLE BASE AND FIREBLOCKED AS REQUIRED BY SECTION 803.13.1. B. IN OTHER THAN GROUP I-3 OCCUPANCIES IN BUILDINGS LESS THAN THREE STORIES ABOVE GRADE PLANE, CLASS B INTERIOR FINISH FOR NONSPRINKLERED BUILDINGS AND CLASS C INTERIOR FINISH FOR SPRINKLERED BUILDINGS SHALL BE PERMITTED IN INTERIOR EXIT STAIRWAYS AND RAMPS. C. REQUIREMENTS FOR ROOMS AND ENCLOSED SPACES SHALL BE BASED UPON SPACES ENCLOSED BY PARTITIONS. WHERE A FIRE-RESISTANCE RATING IS REQUIRED FOR STRUCTURAL ELEMENTS, THE ENCLOSING PARTITIONS SHALL EXTEND FROM THE FLOOR TO THE CEILING. PARTITIONS THAT DO NOT COMPLY WITH THIS SHALL BE CONSIDERED ENCLOSING SPACES AND THE ROOMS OR SPACES ON BOTH SIDES SHALL BE CONSIDERED ONE. IN DETERMINING THE APPLICABLE REQUIREMENTS FOR ROOMS AND ENCLOSED SPACES, THE SPECIFIC OCCUPANCY THEREOF SHALL BE THE GOVERNING FACTOR REGARDLESS OF THE GROUP CLASSIFICATION OF THE BUILDING OR STRUCTURE. D. LOBBY AREAS IN GROUP A-1, A-2 AND A-3 OCCUPANCIES SHALL NOT BE LESS THAN CLASS B E. CLASS C INTERIOR FINISH MATERIALS SHALL BE PERMITTED IN PLACES OF ASSEMBLY WITH AN OCCUPANT LOAD OF 300 PERSONS OR LESS.

CONSTRUCTION GENERAL NOTES

- ALL DIMENSIONS TO FINISH FACE, U.N.O. ALL INTERIOR PARTITIONS TO BE TYPE A, U.N.O. SEE SHEET A010 FOR PARTITION SCHEDULE
- ALL INTERIOR WALLS TO BE PAINTED, U.N.O. ALL CEILINGS TO BE 5/8" GWB - PAINTED - FLAT FINISH
- ALL WALLS TO BE PAINTED EGGSHELL FINISH REPAIR ALL WALLS EXISTING TO REMAIN AS REQUIRED
- PROVIDE ARC-FAULT PROTECTION FOR ALL LIVING SPACE OUTLETS TO COMPLY ALL FLOORING TO BE LVT OR SIMILAR SPECIFIED BY OWNER, U.N.O.
- GC TO VERIFY INSULATION OF EXISTING EXTERIOR WALLS TO REMAIN MEETS R8/13 ACCORDING
- AIR LEAKAGE RATE NOT TO EXCEED 3 AIR CHANGES PER HOUR. GC TO TEST BUILDING THERMAL 18. ENVELOP IN ACCORDANCE WITH 2017 IECC 402.4.1.2
- GC TO PROVIDE NO FEWER THAN ONE APPROVE PORTABLE FIRE EXTINGUISHERS IN ACCORDANCE WITH SECTION 906. AREAS TO HAVE FIRE EXTIGUISHERS AS FOLLOWS: EA. STAIRWAY FLOOR LEVEL, STORAGE AND CONSTRUCTION SHED, WHERE SPECIAL HAZARDS EXIST. SEE PLAN FOR FIRE EXTINGUISHER (F.E.) LOCATIONS.
- TYPE, 2.5 LB 6"X4"X16"; HARDWARE INSTALLED AT 48" AFF. MAX.
 - HANDRAILS AND GUARDS SHALL BE DESIGNED TO RESIST A LINEAR LOAD OF 50 POUNDS PER LINEAR FOOT (PLF) (0.73 KN/M). HANDRAILS AND GUARDS SHALL BE DESIGNED TO RESIST A CONCENTRATED LOAD OF 200

GC TO PROVIDE PORTABLE FIRE EXTINGUISHERS IN ALL KITCHEN AREAS. (F.E) CLASS A RATING

- GRAB BARS, SHOWER SEATS AND DRESSING ROOM BENCH SEATS SHALL BE DESIGNED TO RESIST A SINGLE CONCENTRATED LOAD OF 250 POUNDS (1.11 KN) APPLIED IN ANY DIRECTION AT ANY POINT ON THE GRAB BAR OR SEAT SO AS TO PRODUCE THE MAXIMUM LOAD EFFECTS
- ACCESSORIES SUCH AS GRAB BARS, TOWEL BARS, PAPER DISPENSERS AND SOAP DISHES, PROVIDED ON OR WITHIN WALLS, SHALL BE INSTALLED AND SEALED TO PROTECT STRUCTURAL ELEMENTS FROM MOISTURE ALL WET AREAS TO BE PAINTED WITH SHERWIN WILLIAMS EMERALD INTERIOR PAINT, SEMI-
- GLOSS, PRODUCT NUMBER: K38W00351 (OR SIMILAR); PAINT OFFERS WASHABILITY, PREVENTS STAINS FROM PENETRATING, AND CONTAINS PROPERTIES THAT INHIBIT THE GROWTH OF MOLD AND MILDEW ON THE SURFACE FRONT LOAD WASHER/DRYER COMBO UNIT. UNIT TO MEET REQUIREMENTS OF 2017 ICC SECTION
- 19. GC TO PROVIDE EXTERIOR SIGNAGE PER 2017 DCBC 501.2

EXISTING TO REMAIN NEW CONSTRUCTION

w w w . 3 8 7 7 . d e s i g n

COPYRIGHT NOTICE:

STUDIO3877 EXPRESSLY RESERVES ITS COMMON LAW COPYRIGHT AND OTHER CHANGED, OR COPIED IN ANY FORM OR MANNER WHATSOEVER, NOR ARE THEY TO BE ASSIGNED TO ANY THIRD PARTY WITHOUT OBTAINING THE EXPRESS WRITTEN PERMISSION AND CONSENT OF STUDIO3877.

DAVID TRACZ, AIA, NCARB DAVID SHOVE BROWN, AIA, NCARB 3299 K STREET NW, SUITE 300 WASHINGTON DC 20007

KHALID KHALIFA 8850 COLUMBIA 100 PARWAY SUITE 316 COLUMBIA, MD 21045 [T] 202.350.4244 [T] 443.393.1070 [W] WWW.3877.DESIGN [W] WWW.KKDESIGN.COM DISTRICT LINE DEVELOPMENT MATT MEDVENE

STRUCTURAL ENGINEER GAVIN & ASSOC. STRUCTURAL **ENGINEERS** 31 HOBART AVE CHARLES GAVIN SUMMIT, NJ 07901 PO BOX 5142 [T] 703.589.4832 MCLEAN, VA 22103 [T] 703.409.1070 DISTRICTLINEDEVELOPMENT.COM [W] WWW.GAVINENGINEERING.COM

MEP ENGINEER: KK ENGINEERING, LLC

<u>CIVIL ENGINEER :</u> HUSKA CONSULTING, LLC CHRIS HUSKA 1050 30TH STREET NW WASHINGTON, DC 20007 [T] 702.425.3862 [W] WWW.HUSKACONSULTING.COM

[W] WWW.

ISSUE FOR BZA

DRAWING DATA

PROJECT: EASTERN AVE NE RESIDENCES ADDRESS: 1106-1112 EASTERN AVE NE **WASHINGTON, DC 20007**

- SHEET SUBMISSION INDEX
- 100% SCHEMATIC DESIGN 18 JUL 2025 • 100% DESIGN DEVELOPMENT - 15 AUG 2025

100% BZA - 31 OCT 2025

REVISION

REV NO.

I AM RESPONSIBLE FOR DETERMINING THAT THE ARCHITECTURAL DESIGN INCLUDED IN THIS APPLICATION ARE IN COMPLIANCE WITH ALL LAWS AND REGULATIONS OF THE DISTRICT OF COLUMBIA. I HAVE PERSONALLY PREPARED, OR DIRECTLY SUPERVISED THE


DEVELOPMENT OF THE ARCHITECTURAL DESIGNS INCLUDED IN THIS

APPLICATION.

SHEET TITLE: CELLAR - FLOOR PLAN

SCALE: As indicated

PROJECT NO: 2025.76

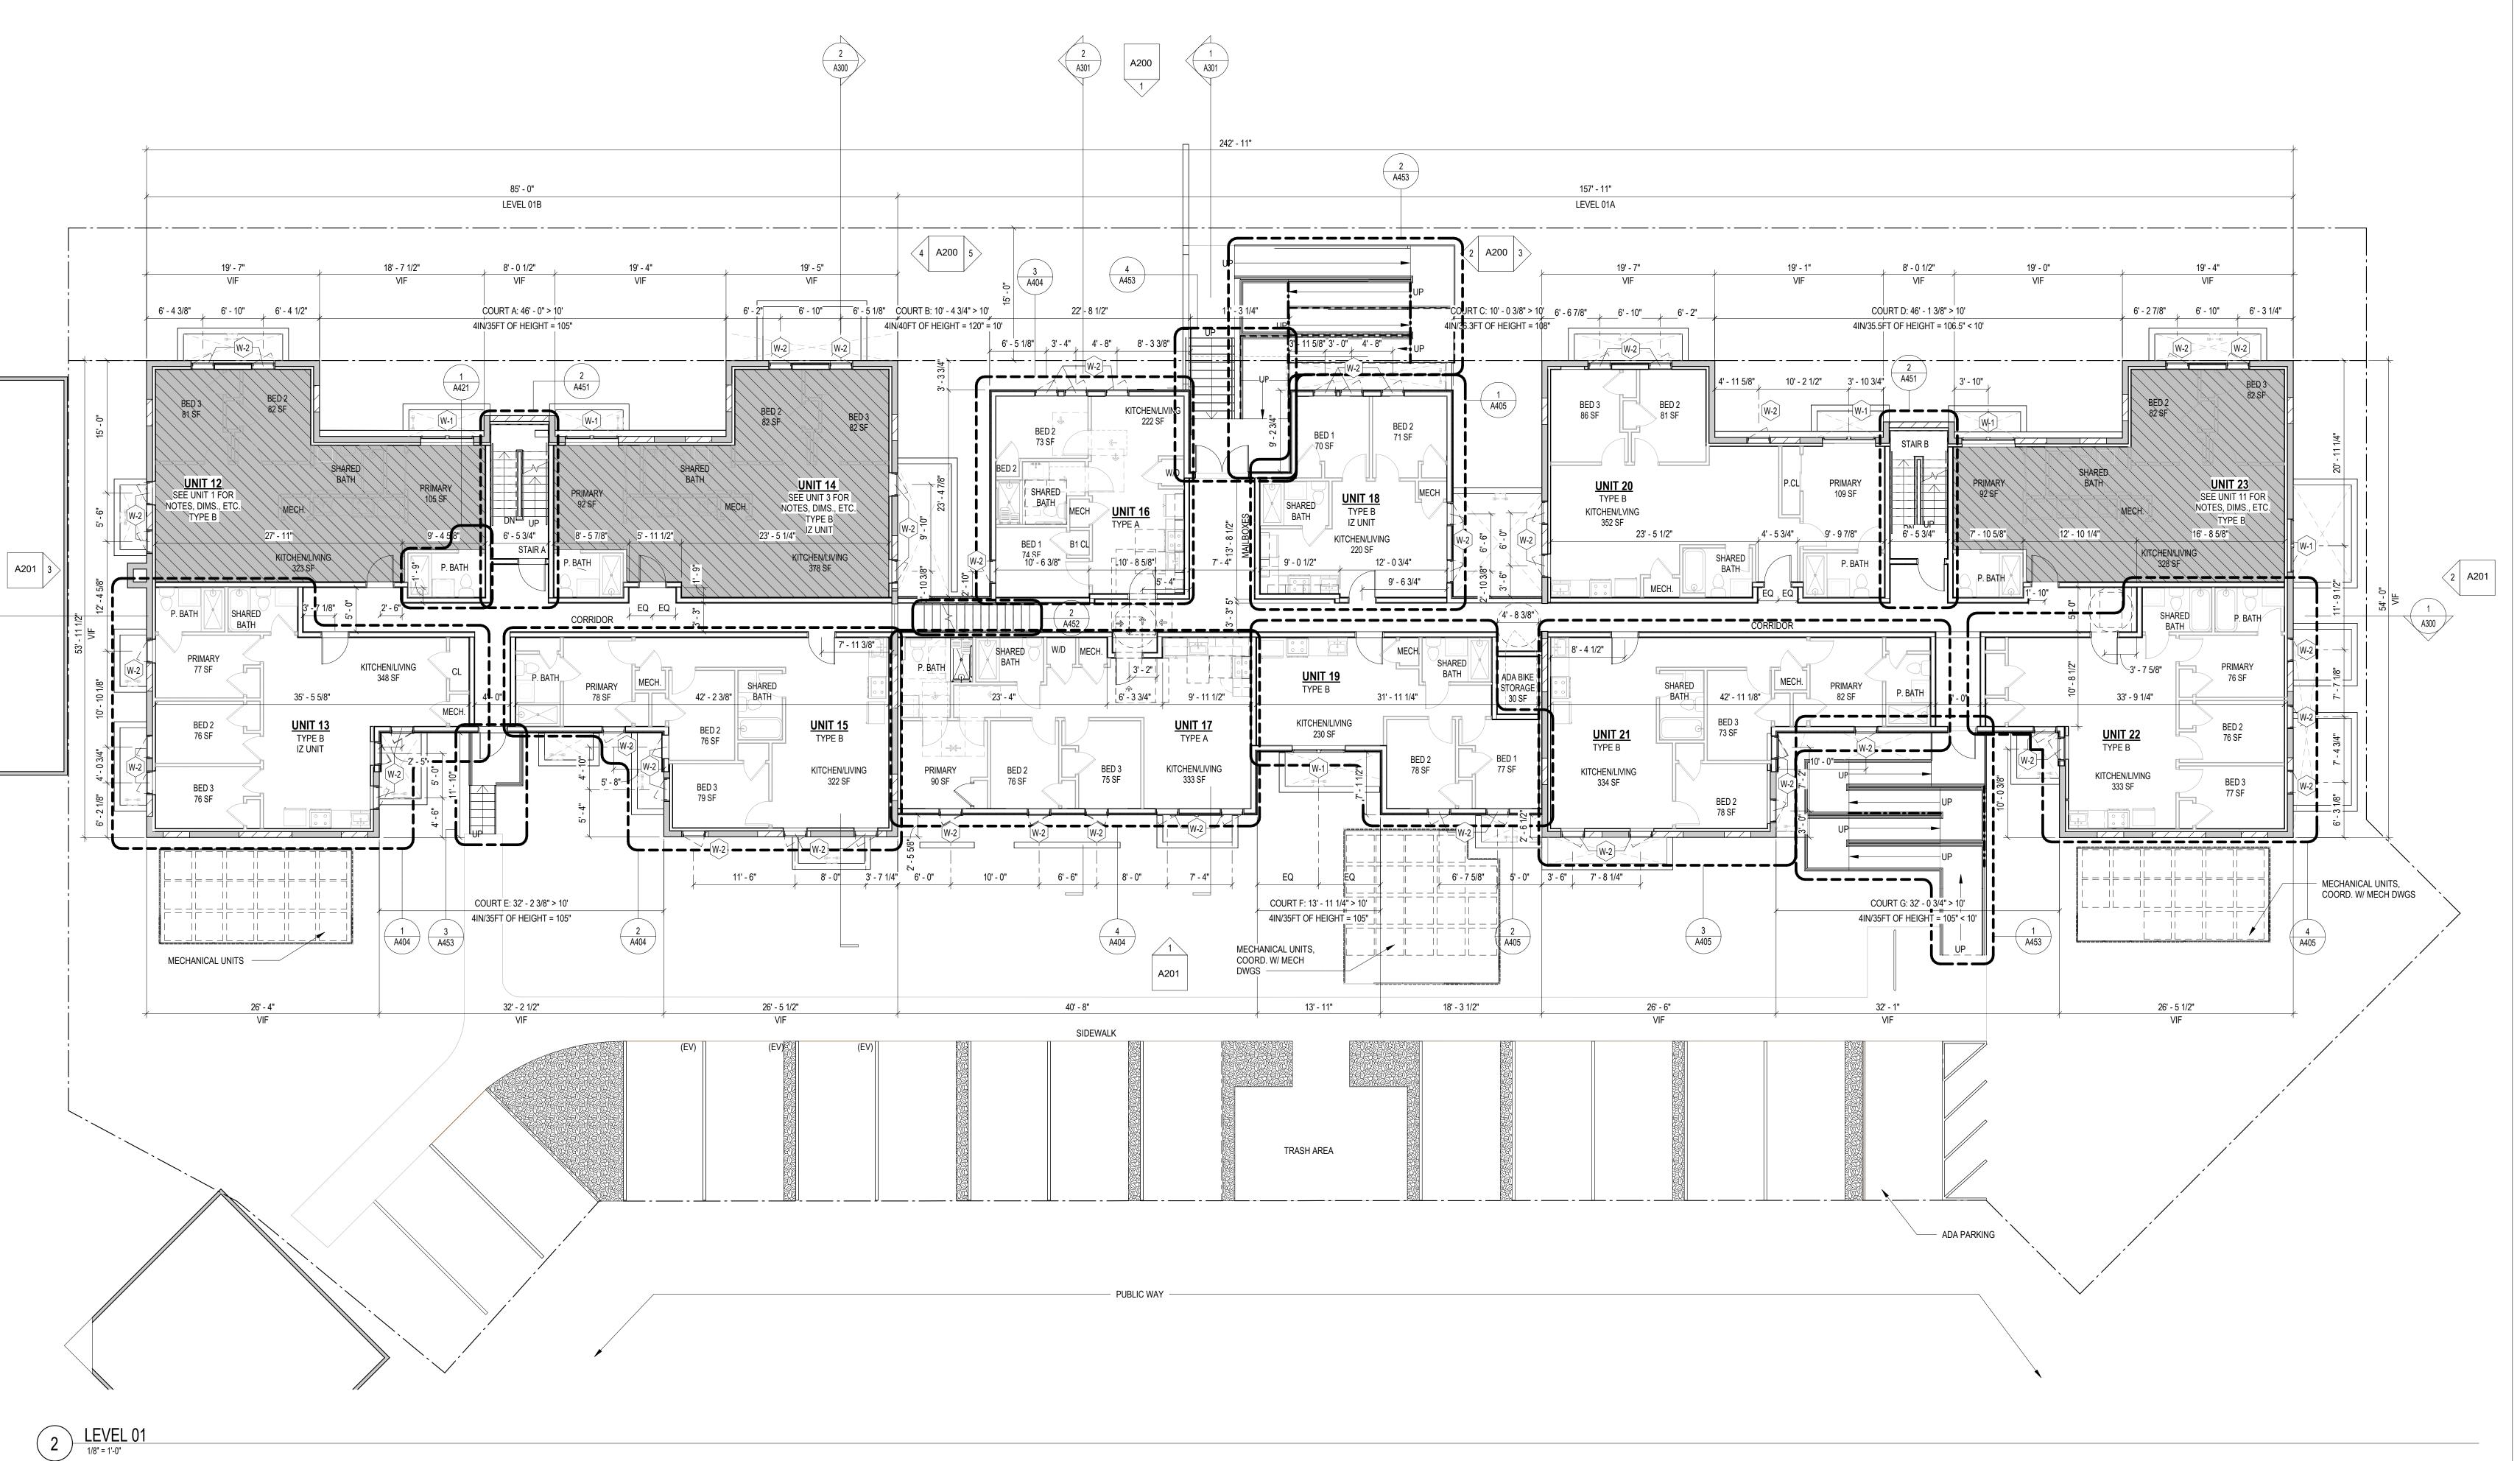

FINISH NO.	DESCRIPTION
LVT-01	LUXURY VINYL TILE
PT-01	GENERAL WALL PAINT
SF-01	MINCEY MARBLE SHOWER SURROUND
TL-01	TILE FLOORING - 12"X24"
TL-1B	MATCHING BASE TILE

*A108.2 APPENDIX A - FLOORING MATERIAL PROJECT ELECTIVE. WHERE PROJECTS ARE INTENDED TO QUALIFY FOR A "FLOORING MATERIAL" PROJECT ELECTIVE, ALL FLOORING INSTALLED WITHIN THE INTERIOR OF THE BUILDING SHALL COMPLY WITH SECTION 806.4 OR SHALL BE ONE OR MORE OF THE FOLLOWING FLOORING MATERIALS THAT ARE DEEMED TO COMPLY WITH VOC EMISSION LIMITS: 1. CERAMIC AND CONCRETE TILE 2. CLAY PAVERS 3. CONCRETE 4. CONCRETE PAVERS 5. METAL 6. ORGANIC-FREE, MINERAL-

*A108.5 APPENDIX A TOTAL VOC LIMIT PROJECT ELECTIVE. WHERE PROJECTS ARE INTENDED TO QUALIFY FOR A "TOTAL VOC LIMIT" PROJECT ELECTIVE IN ACCORDANCE WITH A MINIMUM OF 50 PERCENT OF ALL ADHESIVES AND SEALANTS, ARCHITECTURAL PAINTS AND COATINGS, FLOORING, ACOUSTICAL CEILING TILES AND WALL SYSTEMS AND INSULATION SHALL HAVE A TOTAL VOLATILE ORGANIC COMPOUNDS (TVOCS) EMISSION LIMIT OF ? 500 UG/M3. THE TEST METHODOLOGY USED TO DETERMINE COMPLIANCE SHALL BE FROM CDPH/EHLB/STANDARD METHOD V.1.1. THE EMISSIONS TESTING SHALL BE PERFORMED BY A LABORATORY THAT HAS THE CDPH/EHLB/STANDARD METHOD V.1.1 TEST METHODOLOGY IN THE SCOPE OF ITS ISO 17025

ACCREDITATION. *A108.8 APPENDIX A POST-CONSTRUCTION, PRE-OCCUPANCY BASELINE IAQ TESTING. WHERE PROJECTS ARE INTENDED TO QUALIFY FOR THIS PROJECT ELECTIVE, AFTER ALL INTERIOR FINISHES ARE INSTALLED, THE BUILDING SHALL BE TESTED FOR INDOOR AIR QUALITY AND THE TESTING RESULTS SHALL INDICATE THAT THE LEVELS OF VOCS MEET THE LEVELS DETAILED IN TABLE A108.8 USING TESTING PROTOCOLS IN ACCORDANCE WITH ASTM D 6196, ASTM D 5466, ASTM D 5197, ASTM D 6345, AND ISO 7708. TEST SAMPLES SHALL BE TAKEN IN NOT LESS THAN ONE LOCATION IN EACH 25,000 SQUARE FEET (1860 M2) OF FLOOR AREA OR IN EACH

CONTIGUOUS FLOOR AREA.

INTERIOR FINISHES (PER DCBC TABLE 803.11)

CLASS A = FLAME SPREAD INDEX 0-25; SMOKE-DEVELOPED INDEX 0-450 CLASS B = FLAME SPREAD INDEX 26-75; SMOKE-DEVELOPED INDEX 0-450 CLASS C = FLAME SPREAD INDEX 76-200; SMOKE-DEVELOPED INDEX 0-450 OCCUPANCY GROUP A-2, SPRINKLERED (MOST RESTRICTIVE) INTERIOR EXIT STAIRWAYS, INTERIOR EXIT RAMPS AND EXIT PASSAGEWAYS: CLASS B CORRIDORS AND ENCLOSURE FOR EXIT ACCESS STAIRWAYS AND EXIT ACCESS RAMPS:

CLASS B ROOMS AND ENCLOSED SPACES: CLASS C A. CLASS C INTERIOR FINISH MATERIALS SHALL BE PERMITTED FOR WAINSCOTTING OR PANELING OF NOT MORE THAN 1,000 SQUARE FEET OF APPLIED SURFACE AREA IN THE GRADE LOBBY WHERE APPLIED DIRECTLY TO A NONCOMBUSTIBLE BASE OR OVER FURRING STRIPS APPLIED TO A NONCOMBUSTIBLE BASE AND FIREBLOCKED AS REQUIRED BY SECTION 803.13.1. B. IN OTHER THAN GROUP I-3 OCCUPANCIES IN BUILDINGS LESS THAN THREE STORIES ABOVE GRADE PLANE, CLASS B INTERIOR FINISH FOR NONSPRINKLERED BUILDINGS AND CLASS C INTERIOR FINISH FOR SPRINKLERED BUILDINGS SHALL BE PERMITTED IN INTERIOR EXIT STAIRWAYS AND RAMPS. C. REQUIREMENTS FOR ROOMS AND ENCLOSED SPACES SHALL BE BASED UPON SPACES ENCLOSED BY PARTITIONS. WHERE A FIRE-RESISTANCE RATING IS REQUIRED FOR STRUCTURAL ELEMENTS, THE ENCLOSING PARTITIONS SHALL EXTEND FROM THE FLOOR TO THE CEILING. PARTITIONS THAT DO NOT COMPLY WITH THIS SHALL BE CONSIDERED ENCLOSING SPACES AND THE ROOMS OR SPACES ON BOTH SIDES SHALL BE CONSIDERED ONE. IN DETERMINING THE APPLICABLE REQUIREMENTS FOR ROOMS AND ENCLOSED SPACES, THE SPECIFIC OCCUPANCY THEREOF SHALL BE THE GOVERNING FACTOR REGARDLESS OF THE GROUP CLASSIFICATION OF THE BUILDING OR STRUCTURE. D. LOBBY AREAS IN GROUP A-1, A-2 AND A-3 OCCUPANCIES SHALL NOT BE LESS THAN CLASS B E. CLASS C INTERIOR FINISH MATERIALS SHALL BE PERMITTED IN PLACES OF ASSEMBLY WITH AN OCCUPANT LOAD OF 300 PERSONS OR LESS.

CONSTRUCTION GENERAL NOTES

- ALL DIMENSIONS TO FINISH FACE, U.N.O. ALL INTERIOR PARTITIONS TO BE TYPE A, U.N.O. SEE SHEET A010 FOR PARTITION SCHEDULE
- ALL INTERIOR WALLS TO BE PAINTED, U.N.O. ALL CEILINGS TO BE 5/8" GWB - PAINTED - FLAT FINISH
- ALL WALLS TO BE PAINTED EGGSHELL FINISH REPAIR ALL WALLS EXISTING TO REMAIN AS REQUIRED
- PROVIDE ARC-FAULT PROTECTION FOR ALL LIVING SPACE OUTLETS TO COMPLY ALL FLOORING TO BE LVT OR SIMILAR SPECIFIED BY OWNER, U.N.O.
- GC TO VERIFY INSULATION OF EXISTING EXTERIOR WALLS TO REMAIN MEETS R8/13 ACCORDING AIR LEAKAGE RATE NOT TO EXCEED 3 AIR CHANGES PER HOUR. GC TO TEST BUILDING THERMAL 18.
- ENVELOP IN ACCORDANCE WITH 2017 IECC 402.4.1.2 GC TO PROVIDE NO FEWER THAN ONE APPROVE PORTABLE FIRE EXTINGUISHERS IN ACCORDANCE WITH SECTION 906. AREAS TO HAVE FIRE EXTIGUISHERS AS FOLLOWS: EA. STAIRWAY FLOOR LEVEL, STORAGE AND CONSTRUCTION SHED, WHERE SPECIAL HAZARDS EXIST.
- SEE PLAN FOR FIRE EXTINGUISHER (F.E.) LOCATIONS. GC TO PROVIDE PORTABLE FIRE EXTINGUISHERS IN ALL KITCHEN AREAS. (F.E) CLASS A RATING TYPE, 2.5 LB 6"X4"X16"; HARDWARE INSTALLED AT 48" AFF. MAX.
- HANDRAILS AND GUARDS SHALL BE DESIGNED TO RESIST A LINEAR LOAD OF 50 POUNDS PER LINEAR FOOT (PLF) (0.73 KN/M). HANDRAILS AND GUARDS SHALL BE DESIGNED TO RESIST A CONCENTRATED LOAD OF 200
- GRAB BARS, SHOWER SEATS AND DRESSING ROOM BENCH SEATS SHALL BE DESIGNED TO RESIST A SINGLE CONCENTRATED LOAD OF 250 POUNDS (1.11 KN) APPLIED IN ANY DIRECTION AT ANY POINT ON THE GRAB BAR OR SEAT SO AS TO PRODUCE THE MAXIMUM LOAD EFFECTS
- ACCESSORIES SUCH AS GRAB BARS, TOWEL BARS, PAPER DISPENSERS AND SOAP DISHES. PROVIDED ON OR WITHIN WALLS, SHALL BE INSTALLED AND SEALED TO PROTECT STRUCTURAL ELEMENTS FROM MOISTURE ALL WET AREAS TO BE PAINTED WITH SHERWIN WILLIAMS EMERALD INTERIOR PAINT. SEMI-
- GLOSS, PRODUCT NUMBER: K38W00351 (OR SIMILAR); PAINT OFFERS WASHABILITY, PREVENTS STAINS FROM PENETRATING, AND CONTAINS PROPERTIES THAT INHIBIT THE GROWTH OF MOLD AND MILDEW ON THE SURFACE
- FRONT LOAD WASHER/DRYER COMBO UNIT. UNIT TO MEET REQUIREMENTS OF 2017 ICC SECTION
- 19. GC TO PROVIDE EXTERIOR SIGNAGE PER 2017 DCBC 501.2

EXISTING TO REMAIN NEW CONSTRUCTION



COPYRIGHT NOTICE:

STUDIO3877 EXPRESSLY RESERVES ITS COMMON LAW COPYRIGHT AND OTHER CHANGED, OR COPIED IN ANY FORM OR MANNER WHATSOEVER, NOR ARE THEY TO BE ASSIGNED TO ANY THIRD PARTY WITHOUT OBTAINING THE EXPRESS WRITTEN PERMISSION AND CONSENT OF STUDIO3877.

> **MEP ENGINEER:** KK ENGINEERING, LLC KHALID KHALIFA

8850 COLUMBIA 100 PARWAY

DAVID TRACZ, AIA, NCARB DAVID SHOVE BROWN, AIA, NCARB 3299 K STREET NW, SUITE 300 WASHINGTON DC 20007 [T] 202.350.4244

SUITE 316 COLUMBIA, MD 21045 [T] 443.393.1070 [W] WWW.3877.DESIGN [W] WWW.KKDESIGN.COM STRUCTURAL ENGINEER DISTRICT LINE DEVELOPMENT GAVIN & ASSOC. STRUCTURAL

MATT MEDVENE **ENGINEERS** 31 HOBART AVE CHARLES GAVIN SUMMIT, NJ 07901 PO BOX 5142 [T] 703.589.4832 MCLEAN, VA 22103 [W] WWW. [T] 703.409.1070 DISTRICTLINEDEVELOPMENT.COM [W] WWW.GAVINENGINEERING.COM

<u>CIVIL ENGINEER :</u> HUSKA CONSULTING, LLC CHRIS HUSKA 1050 30TH STREET NW WASHINGTON, DC 20007 [T] 702.425.3862 [W] WWW.HUSKACONSULTING.COM

ISSUE FOR BZA

DRAWING DATA

PROJECT: EASTERN AVE NE RESIDENCES ADDRESS: 1106-1112 EASTERN AVE NE **WASHINGTON, DC 20007**

- SHEET SUBMISSION INDEX
- 100% SCHEMATIC DESIGN 18 JUL 2025 • 100% DESIGN DEVELOPMENT - 15 AUG 2025

100% BZA - 31 OCT 2025

REVISION

DATE

REV NO.

SIGNATURE:


I AM RESPONSIBLE FOR DETERMINING THAT THE ARCHITECTURAL DESIGN INCLUDED IN THIS APPLICATION ARE IN COMPLIANCE WITH ALL LAWS AND REGULATIONS OF THE DISTRICT OF COLUMBIA. I HAVE PERSONALLY PREPARED, OR DIRECTLY SUPERVISED THE DEVELOPMENT OF THE ARCHITECTURAL DESIGNS INCLUDED IN THIS

APPLICATION.

SHEET TITLE: LEVEL 1 - FLOOR PLAN

SCALE: As indicated

PROJECT NO: 2025.76

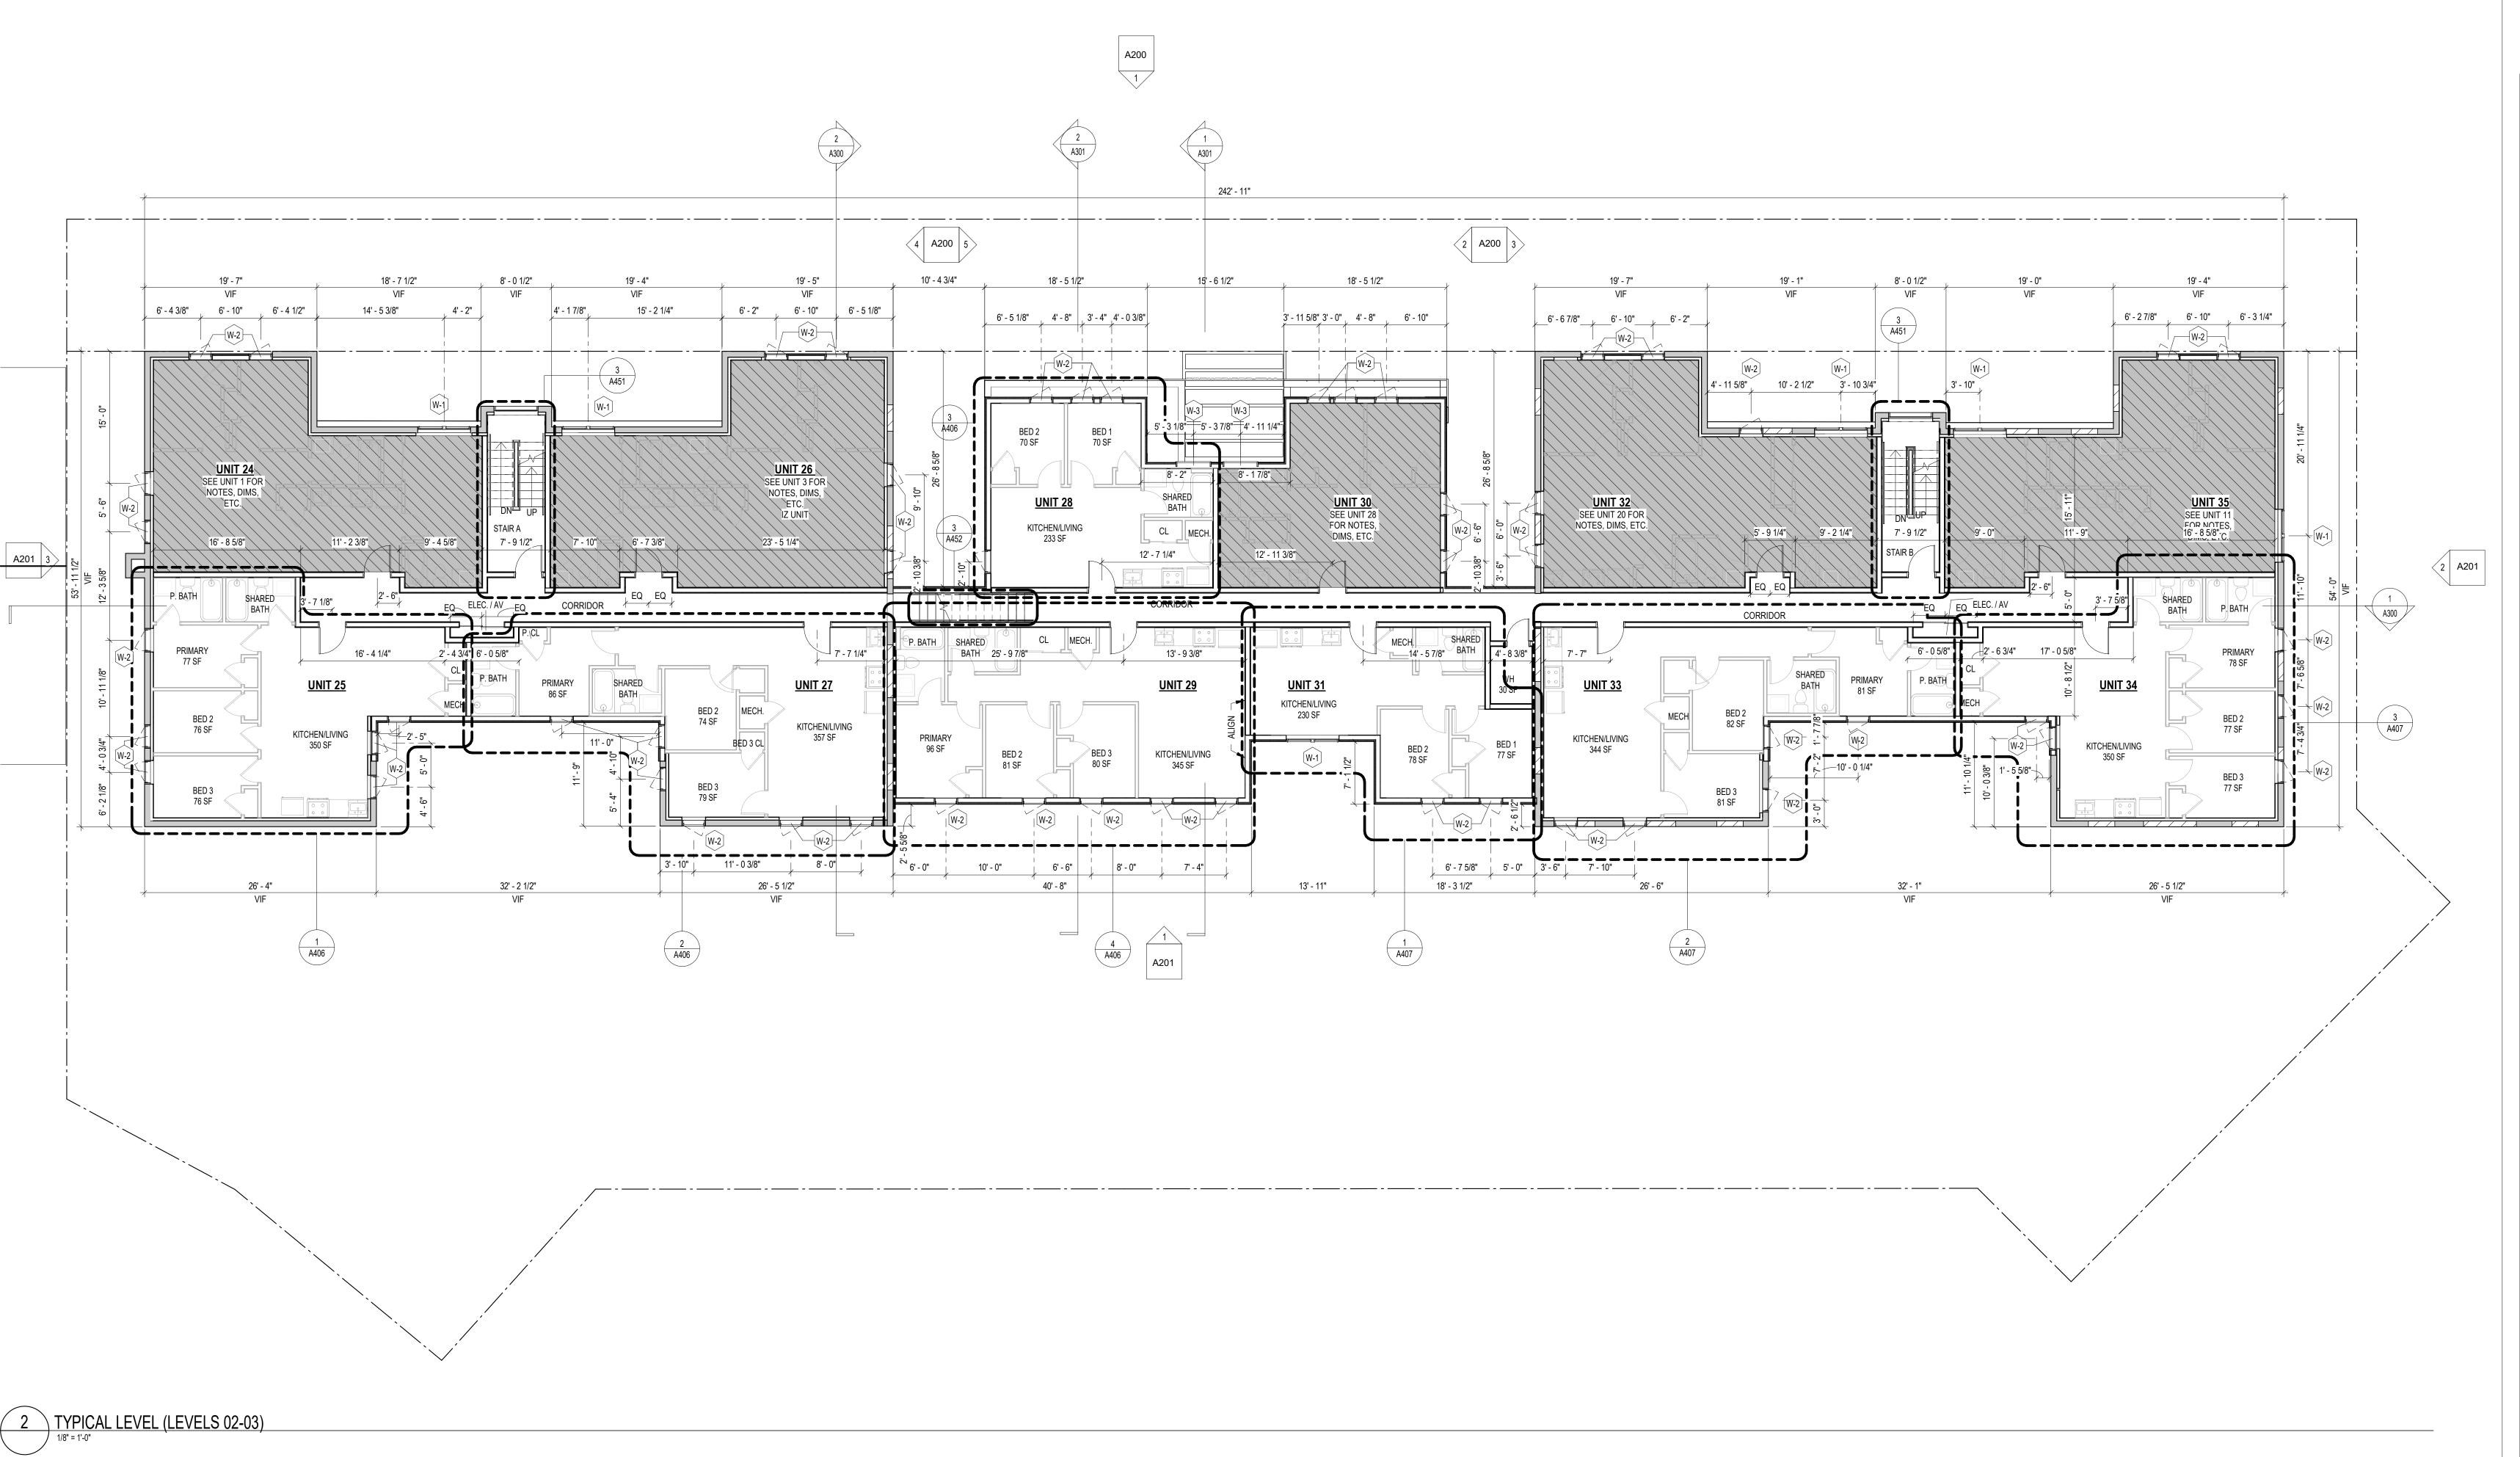

FINISH NO.	DESCRIPTION
LVT-01	LUXURY VINYL TILE
PT-01	GENERAL WALL PAINT
SF-01	MINCEY MARBLE SHOWER SURROUND
TL-01	TILE FLOORING - 12"X24"
TL-1B	MATCHING BASE TILE

*A108.2 APPENDIX A - FLOORING MATERIAL PROJECT ELECTIVE. WHERE PROJECTS ARE INTENDED TO QUALIFY FOR A "FLOORING MATERIAL" PROJECT ELECTIVE, ALL FLOORING INSTALLED WITHIN THE INTERIOR OF THE BUILDING SHALL COMPLY WITH SECTION 806.4 OR SHALL BE ONE OR MORE OF THE FOLLOWING FLOORING MATERIALS THAT ARE DEEMED TO COMPLY WITH VOC EMISSION LIMITS: 1. CERAMIC AND CONCRETE TILE 2. CLAY PAVERS 3. CONCRETE 4. CONCRETE PAVERS 5. METAL 6. ORGANIC-FREE, MINERAL-

*A108.5 APPENDIX A TOTAL VOC LIMIT PROJECT ELECTIVE. WHERE PROJECTS ARE INTENDED TO QUALIFY FOR A "TOTAL VOC LIMIT" PROJECT ELECTIVE IN ACCORDANCE WITH A MINIMUM OF 50 PERCENT OF ALL ADHESIVES AND SEALANTS, ARCHITECTURAL PAINTS AND COATINGS, FLOORING, ACOUSTICAL CEILING TILES AND WALL SYSTEMS AND INSULATION SHALL HAVE A TOTAL VOLATILE ORGANIC COMPOUNDS (TVOCS) EMISSION LIMIT OF ? 500 UG/M3. THE TEST METHODOLOGY USED TO DETERMINE COMPLIANCE SHALL BE FROM CDPH/EHLB/STANDARD METHOD V.1.1. THE EMISSIONS TESTING SHALL BE PERFORMED BY A LABORATORY THAT HAS THE

CDPH/EHLB/STANDARD METHOD V.1.1 TEST METHODOLOGY IN THE SCOPE OF ITS ISO 17025

ACCREDITATION. *A108.8 APPENDIX A POST-CONSTRUCTION, PRE-OCCUPANCY BASELINE IAQ TESTING. WHERE PROJECTS ARE INTENDED TO QUALIFY FOR THIS PROJECT ELECTIVE, AFTER ALL INTERIOR FINISHES ARE INSTALLED, THE BUILDING SHALL BE TESTED FOR INDOOR AIR QUALITY AND THE TESTING RESULTS SHALL INDICATE THAT THE LEVELS OF VOCS MEET THE LEVELS DETAILED IN TABLE A108.8 USING TESTING PROTOCOLS IN ACCORDANCE WITH ASTM D 6196, ASTM D 5466, ASTM D 5197, ASTM D 6345, AND ISO 7708. TEST SAMPLES SHALL BE TAKEN IN NOT LESS THAN ONE LOCATION IN EACH 25,000 SQUARE FEET (1860 M2) OF FLOOR AREA OR IN EACH CONTIGUOUS FLOOR AREA.

INTERIOR FINISHES (PER DCBC TABLE 803.11)

CLASS A = FLAME SPREAD INDEX 0-25; SMOKE-DEVELOPED INDEX 0-450 CLASS B = FLAME SPREAD INDEX 26-75; SMOKE-DEVELOPED INDEX 0-450 CLASS C = FLAME SPREAD INDEX 76-200; SMOKE-DEVELOPED INDEX 0-450 OCCUPANCY GROUP A-2, SPRINKLERED (MOST RESTRICTIVE) INTERIOR EXIT STAIRWAYS, INTERIOR EXIT RAMPS AND EXIT PASSAGEWAYS: CLASS B CORRIDORS AND ENCLOSURE FOR EXIT ACCESS STAIRWAYS AND EXIT ACCESS RAMPS:

OCCUPANT LOAD OF 300 PERSONS OR LESS.

CLASS B ROOMS AND ENCLOSED SPACES: CLASS C A. CLASS C INTERIOR FINISH MATERIALS SHALL BE PERMITTED FOR WAINSCOTTING OR PANELING OF NOT MORE THAN 1,000 SQUARE FEET OF APPLIED SURFACE AREA IN THE GRADE LOBBY WHERE APPLIED DIRECTLY TO A NONCOMBUSTIBLE BASE OR OVER FURRING STRIPS APPLIED TO A NONCOMBUSTIBLE BASE AND FIREBLOCKED AS REQUIRED BY SECTION 803.13.1. B. IN OTHER THAN GROUP I-3 OCCUPANCIES IN BUILDINGS LESS THAN THREE STORIES ABOVE GRADE PLANE, CLASS B INTERIOR FINISH FOR NONSPRINKLERED BUILDINGS AND CLASS C INTERIOR FINISH FOR SPRINKLERED BUILDINGS SHALL BE PERMITTED IN INTERIOR EXIT STAIRWAYS AND RAMPS. C. REQUIREMENTS FOR ROOMS AND ENCLOSED SPACES SHALL BE BASED UPON SPACES ENCLOSED BY PARTITIONS. WHERE A FIRE-RESISTANCE RATING IS REQUIRED FOR STRUCTURAL ELEMENTS, THE ENCLOSING PARTITIONS SHALL EXTEND FROM THE FLOOR TO THE CEILING. PARTITIONS THAT DO NOT COMPLY WITH THIS SHALL BE CONSIDERED ENCLOSING SPACES AND THE ROOMS OR SPACES ON BOTH SIDES SHALL BE CONSIDERED ONE. IN DETERMINING THE APPLICABLE REQUIREMENTS FOR ROOMS AND ENCLOSED SPACES, THE SPECIFIC OCCUPANCY THEREOF SHALL BE THE GOVERNING FACTOR REGARDLESS OF THE GROUP CLASSIFICATION OF THE BUILDING OR STRUCTURE. D. LOBBY AREAS IN GROUP A-1, A-2 AND A-3 OCCUPANCIES SHALL NOT BE LESS THAN CLASS B E. CLASS C INTERIOR FINISH MATERIALS SHALL BE PERMITTED IN PLACES OF ASSEMBLY WITH AN

CONSTRUCTION GENERAL NOTES

- ALL DIMENSIONS TO FINISH FACE, U.N.O. ALL INTERIOR PARTITIONS TO BE TYPE A, U.N.O. SEE SHEET A010 FOR PARTITION SCHEDULE
- ALL INTERIOR WALLS TO BE PAINTED, U.N.O. ALL CEILINGS TO BE 5/8" GWB - PAINTED - FLAT FINISH
- ALL WALLS TO BE PAINTED EGGSHELL FINISH
- REPAIR ALL WALLS EXISTING TO REMAIN AS REQUIRED PROVIDE ARC-FAULT PROTECTION FOR ALL LIVING SPACE OUTLETS TO COMPLY ALL FLOORING TO BE LVT OR SIMILAR SPECIFIED BY OWNER, U.N.O.
- GC TO VERIFY INSULATION OF EXISTING EXTERIOR WALLS TO REMAIN MEETS R8/13 ACCORDING
- AIR LEAKAGE RATE NOT TO EXCEED 3 AIR CHANGES PER HOUR. GC TO TEST BUILDING THERMAL 18. ENVELOP IN ACCORDANCE WITH 2017 IECC 402.4.1.2 GC TO PROVIDE NO FEWER THAN ONE APPROVE PORTABLE FIRE EXTINGUISHERS IN
- ACCORDANCE WITH SECTION 906. AREAS TO HAVE FIRE EXTIGUISHERS AS FOLLOWS: EA. STAIRWAY FLOOR LEVEL, STORAGE AND CONSTRUCTION SHED, WHERE SPECIAL HAZARDS EXIST. SEE PLAN FOR FIRE EXTINGUISHER (F.E.) LOCATIONS. GC TO PROVIDE PORTABLE FIRE EXTINGUISHERS IN ALL KITCHEN AREAS. (F.E) CLASS A RATING TYPE, 2.5 LB 6"X4"X16"; HARDWARE INSTALLED AT 48" AFF. MAX.
- HANDRAILS AND GUARDS SHALL BE DESIGNED TO RESIST A LINEAR LOAD OF 50 POUNDS PER LINEAR FOOT (PLF) (0.73 KN/M). HANDRAILS AND GUARDS SHALL BE DESIGNED TO RESIST A CONCENTRATED LOAD OF 200 POUNDS (0.89 KN)
- GRAB BARS, SHOWER SEATS AND DRESSING ROOM BENCH SEATS SHALL BE DESIGNED TO RESIST A SINGLE CONCENTRATED LOAD OF 250 POUNDS (1.11 KN) APPLIED IN ANY DIRECTION AT ANY POINT ON THE GRAB BAR OR SEAT SO AS TO PRODUCE THE MAXIMUM LOAD EFFECTS

ACCESSORIES SUCH AS GRAB BARS, TOWEL BARS, PAPER DISPENSERS AND SOAP DISHES,

- PROVIDED ON OR WITHIN WALLS, SHALL BE INSTALLED AND SEALED TO PROTECT STRUCTURAL ELEMENTS FROM MOISTURE ALL WET AREAS TO BE PAINTED WITH SHERWIN WILLIAMS EMERALD INTERIOR PAINT. SEMI-GLOSS, PRODUCT NUMBER: K38W00351 (OR SIMILAR); PAINT OFFERS WASHABILITY, PREVENTS
- STAINS FROM PENETRATING, AND CONTAINS PROPERTIES THAT INHIBIT THE GROWTH OF MOLD AND MILDEW ON THE SURFACE FRONT LOAD WASHER/DRYER COMBO UNIT. UNIT TO MEET REQUIREMENTS OF 2017 ICC SECTION
- 19. GC TO PROVIDE EXTERIOR SIGNAGE PER 2017 DCBC 501.2

EXISTING TO REMAIN NEW CONSTRUCTION

w w w . 3 8 7 7 . d e s i g n

COPYRIGHT NOTICE: STUDIO3877 EXPRESSLY RESERVES ITS COMMON LAW COPYRIGHT AND OTHER PROPERTY RIGHTS TO THESE PLANS. THESE PLANS ARE NOT TO BE REPRODUCED CHANGED, OR COPIED IN ANY FORM OR MANNER WHATSOEVER, NOR ARE THEY TO BE ASSIGNED TO ANY THIRD PARTY WITHOUT OBTAINING THE EXPRESS WRITTEN

ARCHITECT: MEP ENGINEER: KK ENGINEERING, LLC DAVID TRACZ, AIA, NCARB KHALID KHALIFA DAVID SHOVE BROWN, AIA, NCARB 8850 COLUMBIA 100 PARWAY 3299 K STREET NW, SUITE 300 SUITE 316 WASHINGTON DC 20007 COLUMBIA, MD 21045 [T] 202.350.4244 [T] 443.393.1070 [W] WWW.3877.DESIGN [W] WWW.KKDESIGN.COM

PERMISSION AND CONSENT OF STUDIO3877.

STRUCTURAL ENGINEER: DISTRICT LINE DEVELOPMENT GAVIN & ASSOC. STRUCTURAL MATT MEDVENE **ENGINEERS** 31 HOBART AVE CHARLES GAVIN SUMMIT, NJ 07901 PO BOX 5142 MCLEAN, VA 22103 [T] 703.589.4832 [W] WWW. [T] 703.409.1070 DISTRICTLINEDEVELOPMENT.COM [W] WWW.GAVINENGINEERING.COM

CIVIL ENGINEER: HUSKA CONSULTING, LLC CHRIS HUSKA 1050 30TH STREET NW WASHINGTON, DC 20007 [T] 702.425.3862 [W] WWW.HUSKACONSULTING.COM

ISSUE FOR BZA

DRAWING DATA

PROJECT: EASTERN AVE NE RESIDENCES ADDRESS: 1106-1112 EASTERN AVE NE **WASHINGTON, DC 20007**

- SHEET SUBMISSION INDEX
- 100% SCHEMATIC DESIGN 18 JUL 2025 • 100% DESIGN DEVELOPMENT - 15 AUG 2025 100% BZA - 31 OCT 2025

REVISION


DATE

I AM RESPONSIBLE FOR DETERMINING THAT THE ARCHITECTURAL DESIGN INCLUDED IN THIS APPLICATION ARE IN COMPLIANCE WITH ALL LAWS AND REGULATIONS OF THE DISTRICT OF COLUMBIA. I HAVE PERSONALLY PREPARED, OR DIRECTLY SUPERVISED THE DEVELOPMENT OF THE ARCHITECTURAL DESIGNS INCLUDED IN THIS

APPLICATION.

SHEET TITLE: TYPICAL LEVEL (LEVELS 02-03)

PROJECT NO: 2025.76

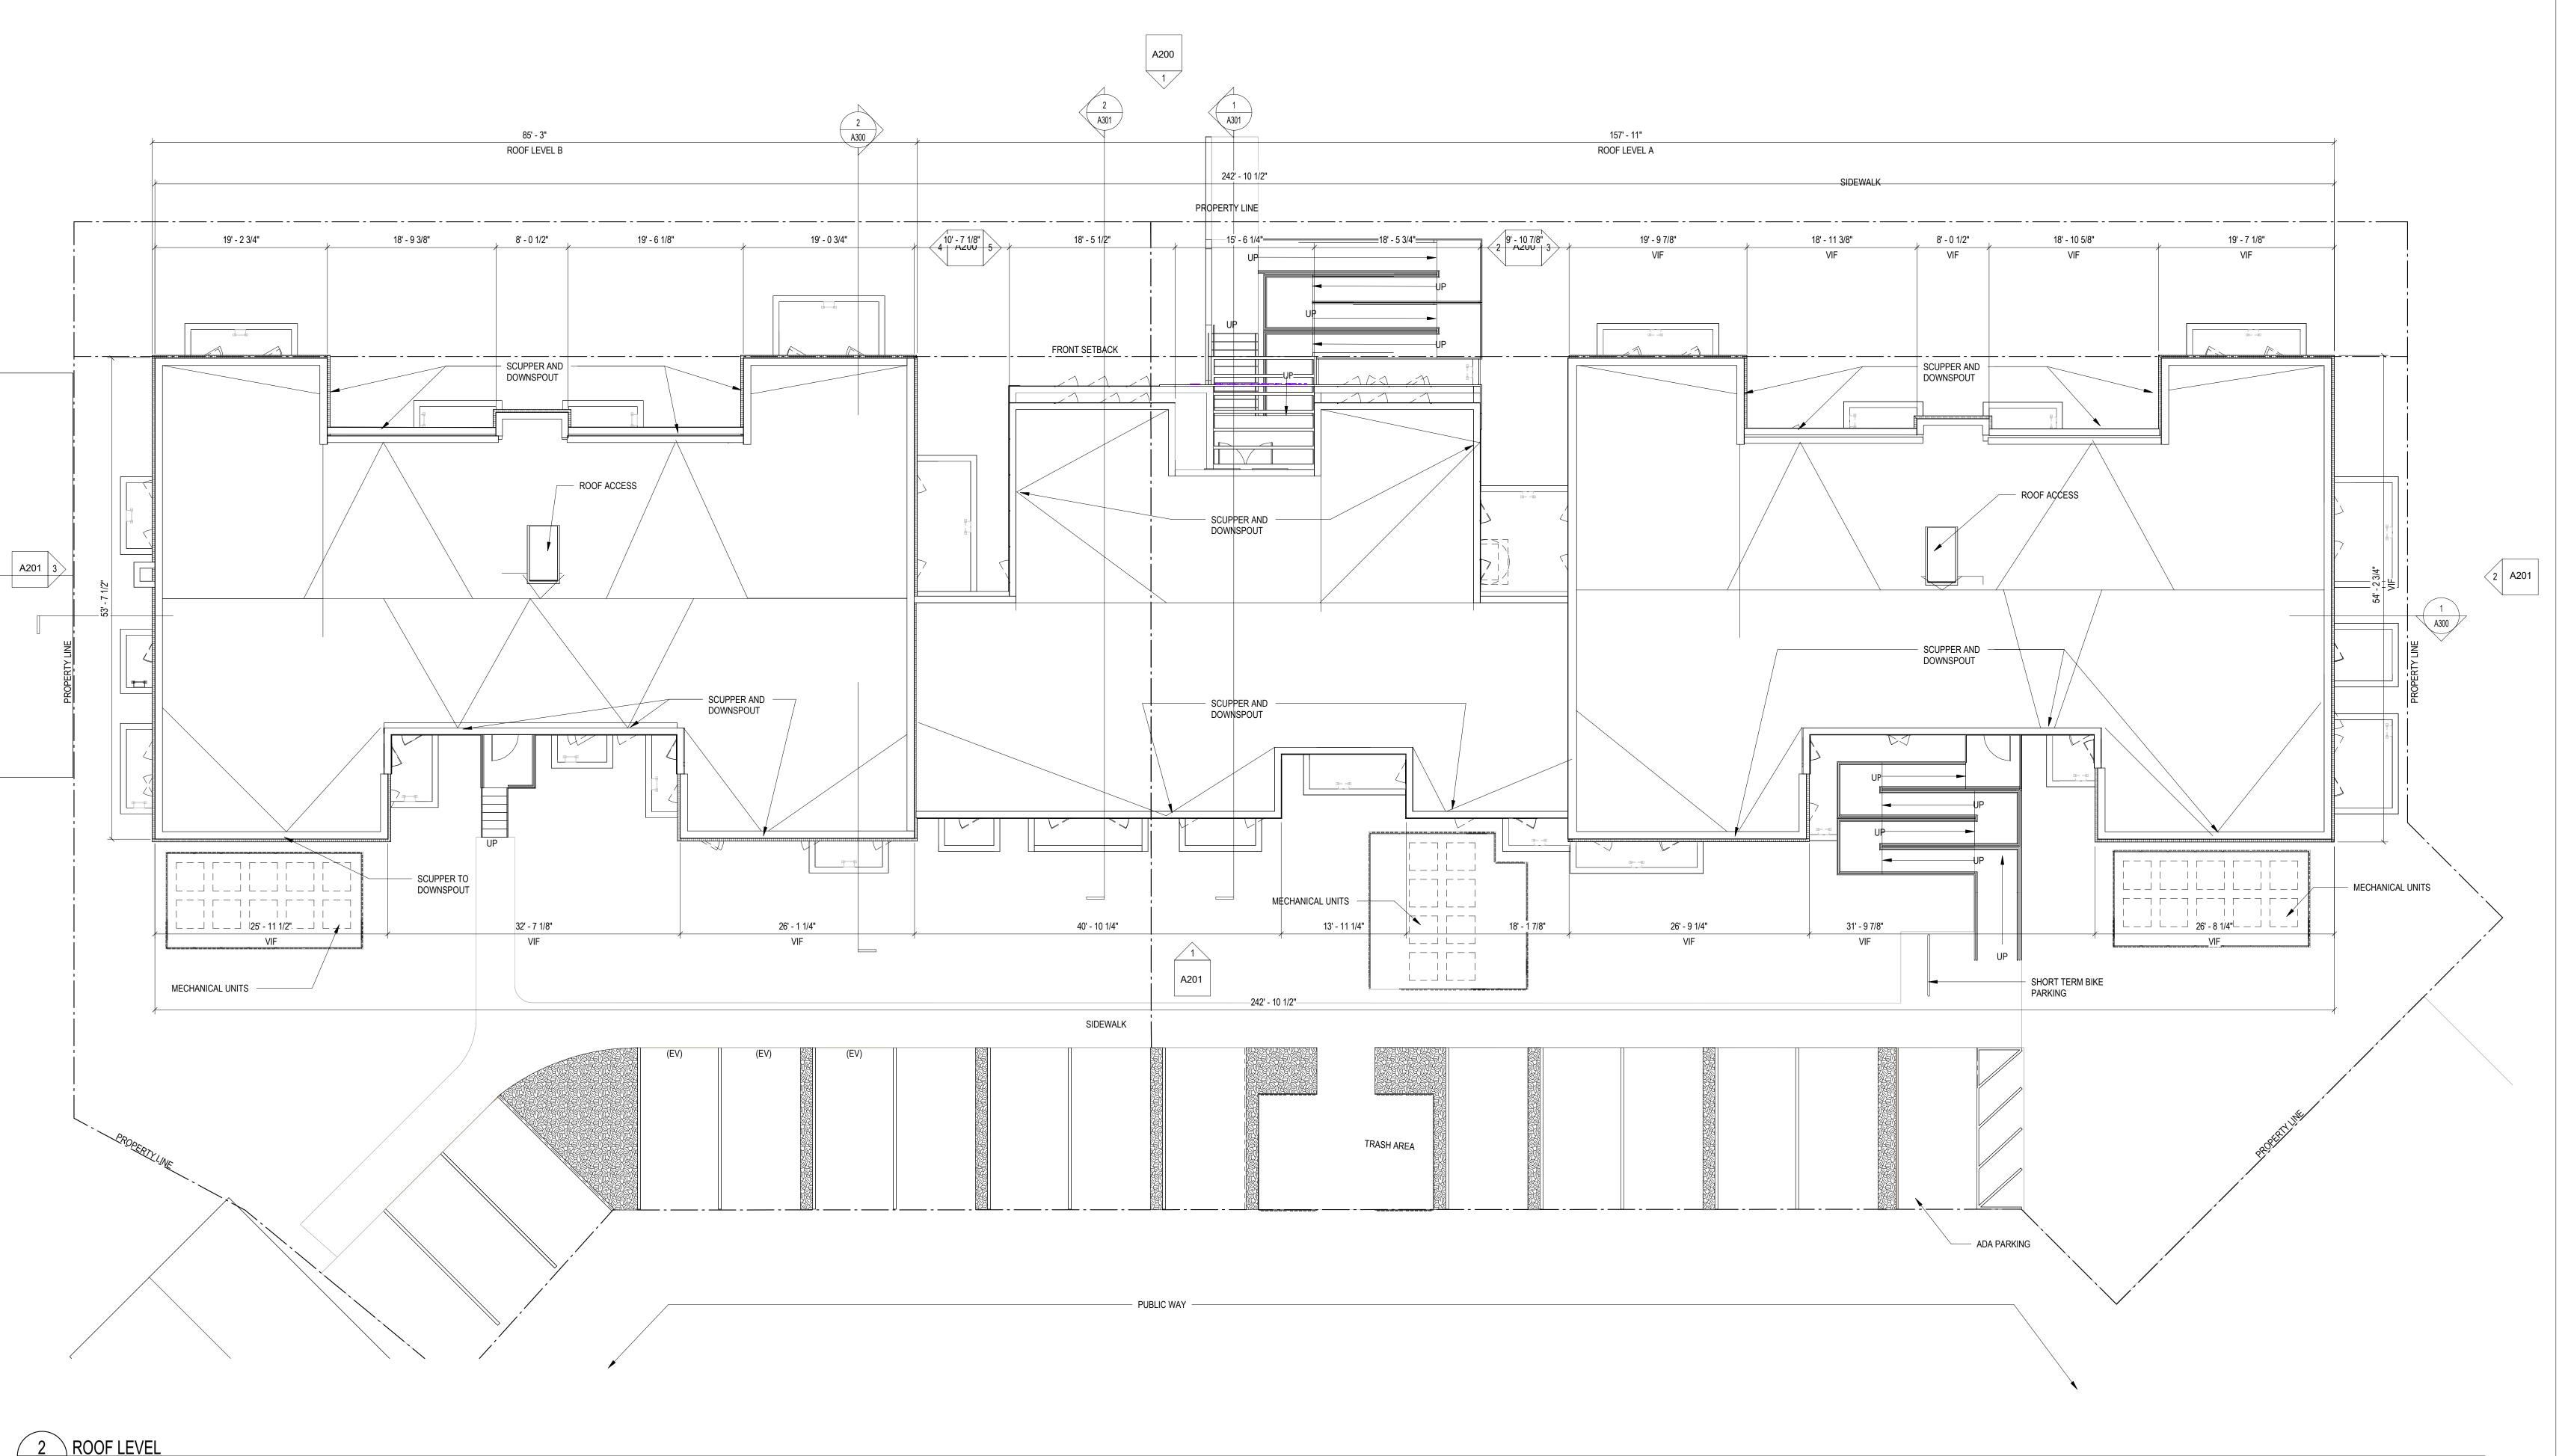

FINISH NO.	DESCRIPTION
LVT-01	LUXURY VINYL TILE
PT-01	GENERAL WALL PAINT
SF-01	MINCEY MARBLE SHOWER SURROUND
TL-01	TILE FLOORING - 12"X24"
TL-1B	MATCHING BASE TILE

*A108.2 APPENDIX A - FLOORING MATERIAL PROJECT ELECTIVE. WHERE PROJECTS ARE INTENDED TO QUALIFY FOR A "FLOORING MATERIAL" PROJECT ELECTIVE, ALL FLOORING INSTALLED WITHIN THE INTERIOR OF THE BUILDING SHALL COMPLY WITH SECTION 806.4 OR SHALL BE ONE OR MORE OF THE FOLLOWING FLOORING MATERIALS THAT ARE DEEMED TO COMPLY WITH VOC EMISSION LIMITS: 1. CERAMIC AND CONCRETE TILE 2. CLAY PAVERS 3. CONCRETE 4. CONCRETE PAVERS 5. METAL 6. ORGANIC-FREE, MINERAL-

*A108.5 APPENDIX A TOTAL VOC LIMIT PROJECT ELECTIVE. WHERE PROJECTS ARE INTENDED TO QUALIFY FOR A "TOTAL VOC LIMIT" PROJECT ELECTIVE IN ACCORDANCE WITH A MINIMUM OF 50 PERCENT OF ALL ADHESIVES AND SEALANTS, ARCHITECTURAL PAINTS AND COATINGS, FLOORING, ACOUSTICAL CEILING TILES AND WALL SYSTEMS AND INSULATION SHALL HAVE A TOTAL VOLATILE ORGANIC COMPOUNDS (TVOCS) EMISSION LIMIT OF ? 500 UG/M³. THE TEST METHODOLOGY USED TO DETERMINE COMPLIANCE SHALL BE FROM CDPH/EHLB/STANDARD METHOD V.1.1. THE EMISSIONS TESTING SHALL BE PERFORMED BY A LABORATORY THAT HAS THE CDPH/EHLB/STANDARD METHOD V.1.1 TEST METHODOLOGY IN THE SCOPE OF ITS ISO 17025

ACCREDITATION. *A108.8 APPENDIX A POST-CONSTRUCTION, PRE-OCCUPANCY BASELINE IAQ TESTING, WHERE PROJECTS ARE INTENDED TO QUALIFY FOR THIS PROJECT ELECTIVE, AFTER ALL INTERIOR FINISHES ARE INSTALLED, THE BUILDING SHALL BE TESTED FOR INDOOR AIR QUALITY AND THE TESTING RESULTS SHALL INDICATE THAT THE LEVELS OF VOCS MEET THE LEVELS DETAILED IN TABLE A108.8 USING TESTING PROTOCOLS IN ACCORDANCE WITH ASTM D 6196, ASTM D 5466, ASTM D 5197, ASTM D 6345, AND ISO 7708. TEST SAMPLES SHALL BE TAKEN IN NOT LESS THAN ONE LOCATION IN EACH 25,000 SQUARE FEET (1860 M2) OF FLOOR AREA OR IN EACH

CONTIGUOUS FLOOR AREA.

INTERIOR FINISHES (PER DCBC TABLE 803.11)

CLASS A = FLAME SPREAD INDEX 0-25; SMOKE-DEVELOPED INDEX 0-450 CLASS B = FLAME SPREAD INDEX 26-75; SMOKE-DEVELOPED INDEX 0-450 CLASS C = FLAME SPREAD INDEX 76-200; SMOKE-DEVELOPED INDEX 0-450 OCCUPANCY GROUP A-2. SPRINKLERED (MOST RESTRICTIVE) INTERIOR EXIT STAIRWAYS, INTERIOR EXIT RAMPS AND EXIT PASSAGEWAYS: CLASS B CORRIDORS AND ENCLOSURE FOR EXIT ACCESS STAIRWAYS AND EXIT ACCESS RAMPS: CLASS B ROOMS AND ENCLOSED SPACES: CLASS C

A. CLASS C INTERIOR FINISH MATERIALS SHALL BE PERMITTED FOR WAINSCOTTING OR PANELING OF NOT MORE THAN 1,000 SQUARE FEET OF APPLIED SURFACE AREA IN THE GRADE LOBBY WHERE APPLIED DIRECTLY TO A NONCOMBUSTIBLE BASE OR OVER FURRING STRIPS APPLIED TO A NONCOMBUSTIBLE BASE AND FIREBLOCKED AS REQUIRED BY SECTION 803.13.1. B. IN OTHER THAN GROUP I-3 OCCUPANCIES IN BUILDINGS LESS THAN THREE STORIES ABOVE GRADE PLANE, CLASS B INTERIOR FINISH FOR NONSPRINKLERED BUILDINGS AND CLASS C INTERIOR FINISH FOR SPRINKLERED BUILDINGS SHALL BE PERMITTED IN INTERIOR EXIT STAIRWAYS AND RAMPS. C. REQUIREMENTS FOR ROOMS AND ENCLOSED SPACES SHALL BE BASED UPON SPACES ENCLOSED BY PARTITIONS. WHERE A FIRE-RESISTANCE RATING IS REQUIRED FOR STRUCTURAL ELEMENTS, THE ENCLOSING PARTITIONS SHALL EXTEND FROM THE FLOOR TO THE CEILING. PARTITIONS THAT DO NOT COMPLY WITH THIS SHALL BE CONSIDERED ENCLOSING SPACES AND THE ROOMS OR SPACES ON BOTH SIDES SHALL BE CONSIDERED ONE. IN DETERMINING THE APPLICABLE REQUIREMENTS FOR ROOMS AND ENCLOSED SPACES, THE SPECIFIC OCCUPANCY THEREOF SHALL BE THE GOVERNING FACTOR REGARDLESS OF THE GROUP CLASSIFICATION OF THE BUILDING OR STRUCTURE. D. LOBBY AREAS IN GROUP A-1, A-2 AND A-3 OCCUPANCIES SHALL NOT BE LESS THAN CLASS B E. CLASS C INTERIOR FINISH MATERIALS SHALL BE PERMITTED IN PLACES OF ASSEMBLY WITH AN OCCUPANT LOAD OF 300 PERSONS OR LESS.

CONSTRUCTION GENERAL NOTES

- ALL DIMENSIONS TO FINISH FACE, U.N.O. ALL INTERIOR PARTITIONS TO BE TYPE A, U.N.O. SEE SHEET A010 FOR PARTITION SCHEDULE
- ALL INTERIOR WALLS TO BE PAINTED, U.N.O. ALL CEILINGS TO BE 5/8" GWB - PAINTED - FLAT FINISH
- ALL WALLS TO BE PAINTED EGGSHELL FINISH REPAIR ALL WALLS EXISTING TO REMAIN AS REQUIRED PROVIDE ARC-FAULT PROTECTION FOR ALL LIVING SPACE OUTLETS TO COMPLY
- ALL FLOORING TO BE LVT OR SIMILAR SPECIFIED BY OWNER, U.N.O.
- GC TO VERIFY INSULATION OF EXISTING EXTERIOR WALLS TO REMAIN MEETS R8/13 ACCORDING AIR LEAKAGE RATE NOT TO EXCEED 3 AIR CHANGES PER HOUR. GC TO TEST BUILDING THERMAL 18.
- ENVELOP IN ACCORDANCE WITH 2017 IECC 402.4.1.2 GC TO PROVIDE NO FEWER THAN ONE APPROVE PORTABLE FIRE EXTINGUISHERS IN ACCORDANCE WITH SECTION 906. AREAS TO HAVE FIRE EXTIGUISHERS AS FOLLOWS: EA. STAIRWAY FLOOR LEVEL, STORAGE AND CONSTRUCTION SHED, WHERE SPECIAL HAZARDS EXIST.
- SEE PLAN FOR FIRE EXTINGUISHER (F.E.) LOCATIONS. GC TO PROVIDE PORTABLE FIRE EXTINGUISHERS IN ALL KITCHEN AREAS. (F.E) CLASS A RATING TYPE, 2.5 LB 6"X4"X16"; HARDWARE INSTALLED AT 48" AFF. MAX. HANDRAILS AND GUARDS SHALL BE DESIGNED TO RESIST A LINEAR LOAD OF 50 POUNDS PER
- LINEAR FOOT (PLF) (0.73 KN/M). HANDRAILS AND GUARDS SHALL BE DESIGNED TO RESIST A CONCENTRATED LOAD OF 200
- GRAB BARS, SHOWER SEATS AND DRESSING ROOM BENCH SEATS SHALL BE DESIGNED TO
- RESIST A SINGLE CONCENTRATED LOAD OF 250 POUNDS (1.11 KN) APPLIED IN ANY DIRECTION AT ANY POINT ON THE GRAB BAR OR SEAT SO AS TO PRODUCE THE MAXIMUM LOAD EFFECTS ACCESSORIES SUCH AS GRAB BARS, TOWEL BARS, PAPER DISPENSERS AND SOAP DISHES, PROVIDED ON OR WITHIN WALLS, SHALL BE INSTALLED AND SEALED TO PROTECT STRUCTURAL
- ELEMENTS FROM MOISTURE ALL WET AREAS TO BE PAINTED WITH SHERWIN WILLIAMS EMERALD INTERIOR PAINT, SEMI-GLOSS, PRODUCT NUMBER: K38W00351 (OR SIMILAR); PAINT OFFERS WASHABILITY, PREVENTS STAINS FROM PENETRATING, AND CONTAINS PROPERTIES THAT INHIBIT THE GROWTH OF MOLD AND MILDEW ON THE SURFACE
- FRONT LOAD WASHER/DRYER COMBO UNIT. UNIT TO MEET REQUIREMENTS OF 2017 ICC SECTION
- 19. GC TO PROVIDE EXTERIOR SIGNAGE PER 2017 DCBC 501.2

EXISTING TO REMAIN NEW CONSTRUCTION



COPYRIGHT NOTICE:

STUDIO3877 EXPRESSLY RESERVES ITS COMMON LAW COPYRIGHT AND OTHER PROPERTY RIGHTS TO THESE PLANS. THESE PLANS ARE NOT TO BE REPRODUCED, CHANGED, OR COPIED IN ANY FORM OR MANNER WHATSOEVER, NOR ARE THEY TO BE ASSIGNED TO ANY THIRD PARTY WITHOUT OBTAINING THE EXPRESS WRITTEN PERMISSION AND CONSENT OF STUDIO3877.

ARCHITECT: DAVID TRACZ, AIA, NCARB DAVID SHOVE BROWN, AIA, NCARB 3299 K STREET NW, SUITE 300 WASHINGTON DC 20007 [T] 202.350.4244

8850 COLUMBIA 100 PARWAY SUITE 316 COLUMBIA, MD 21045 [T] 443.393.1070 [W] WWW.3877.DESIGN [W] WWW.KKDESIGN.COM STRUCTURAL ENGINEER: DISTRICT LINE DEVELOPMENT GAVIN & ASSOC. STRUCTURAL **ENGINEERS**

MEP ENGINEER: KK ENGINEERING, LLC

KHALID KHALIFA

MATT MEDVENE 31 HOBART AVE CHARLES GAVIN SUMMIT, NJ 07901 PO BOX 5142 [T] 703.589.4832 MCLEAN, VA 22103 [T] 703.409.1070 [W] WWW. [W] WWW.GAVINENGINEERING.COM DISTRICTLINEDEVELOPMENT.COM

<u>CIVIL ENGINEER :</u> HUSKA CONSULTING, LLC CHRIS HUSKA 1050 30TH STREET NW WASHINGTON, DC 20007 [T] 702.425.3862 [W] WWW.HUSKACONSULTING.COM

ISSUE FOR BZA

DRAWING DATA

PROJECT: EASTERN AVE NE RESIDENCES ADDRESS: 1106-1112 EASTERN AVE NE **WASHINGTON, DC 20007**

- SHEET SUBMISSION INDEX
- 100% SCHEMATIC DESIGN 18 JUL 2025 100% DESIGN DEVELOPMENT - 15 AUG 2025 100% BZA - 31 OCT 2025

REVISION

DATE

SIGNATURE:

REV NO.

I AM RESPONSIBLE FOR DETERMINING THAT THE ARCHITECTURAL DESIGN INCLUDED IN THIS APPLICATION ARE IN COMPLIANCE WITH ALL LAWS AND REGULATIONS OF THE DISTRICT OF COLUMBIA. I HAVE PERSONALLY PREPARED, OR DIRECTLY SUPERVISED THE

DEVELOPMENT OF THE ARCHITECTURAL DESIGNS INCLUDED IN THIS

APPLICATION.

SHEET TITLE: ROOF FLOOR PLAN

SCALE: As indicated

PROJECT NO: 2025.76