



RIGHT ELEVATION SCALE: 1/4" = 1'-0"

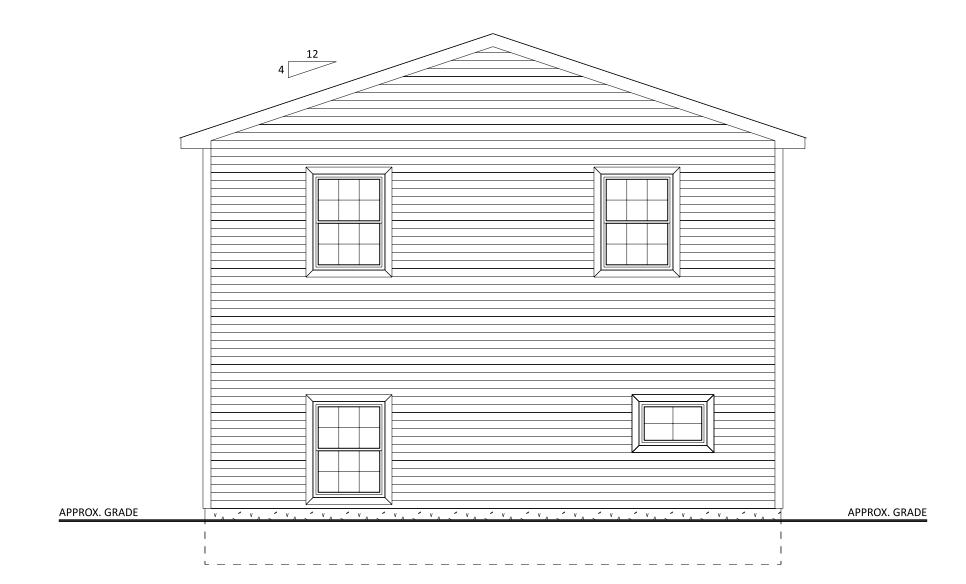

REAR ELEVATION SCALE: 1/4" = 1'-0"

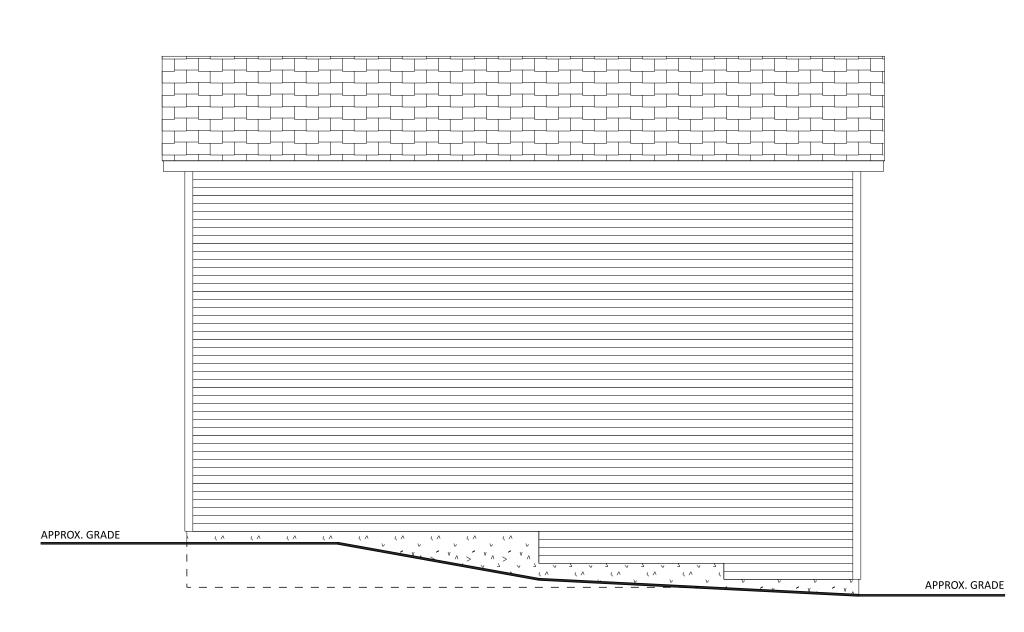

LEFT ELEVATION SCALE: 1/4" = 1'-0"

FASTENER SCHEDULE FOR STRUCTURAL MEMBERS

	BUILDING ELEMENTS	OF FASTENER	SPACING OF FASTENERS	
	ROOF			
CEILING JOISTS TO TOP PLATE		(3) 10d	TOE NAIL	
CEILING JOISTS NOT ATTACHER	O TO PARALLEL RAFTER, LAPS OVER	(4) 10d	FACE NAIL	
COLLAR TIE TO RAFTER, FACE	NAIL OR 1¼" X 20 GAGE RIDGE STRAP TO RAFTER	(4) 10d	FACE NAIL EACH RAFTE	
RAFTER OR ROOF TRUSS TO P	ATE	(3) 16d	TOE NAIL	
ROOF RAFTERS TO RIDGE, VALLEY OR HIP RAFTERS		(4) 16d	TOE NAIL	
	WALL			
STUD TO STUD		16d	24" O.C. FACE NAIL	
BUILT-UP HEADER, TWO PIECE	s	16d	16" O.C. EA. EDGE FACE NAIL	
CONTINUOUS HEADER TO STU	D	(4) 8d	TOE NAIL	
DOUBLE STUDS, FACE NAIL		10d	24" O.C.	
TOP PLATE TO TOP PLATE		10d	12" O.C. FACE N	
DOUBLE TOP PLATES, MINIMU FACE NAIL IN LAPPED AREA	M 48-INCH OFFSET OF END JOINTS,	(8) 16d		
BOTTOM PLATE TO JOIST, RIM	JOIST, BAND JOIST OR BLOCKING	16d	12" O.C. FACE N	
BOTTOM PLATE TO JOIST, RIM JOIST, BAND JOIST OR BLOCKING (AT BRACED WALL PANEL)		(3) 16d	16" O.C. FACE N	
TOP OR BOTTOM PLATE TO STUD		(3) 16d	END NAIL	
TOP PLATES, LAPS AT CORNERS AND INTERSECTIONS		(3) 10d	FACE NAIL	
JOIST TO SILL, TOP PLATE OR G	JOIST TO SILL, TOP PLATE OR GIRDER		TOE NAIL	
RIM JOIST, BAND JOIST, OR BLOCKI	NG TO SILL OR TOP PLATE (ROOF APPLICATIONS ALSO)	10d	6" O.C. TO NAIL	
BUILT-UP GIRDERS AND BEAMS, 2-INCH LUMBER LAYERS		10d	24" O.C. FACE NAIL AT T AND BOTTOM STAGGER ON OPPOSITE SIDES	
WOOD STRUCTURAL PANELS, SUBFLOOR, F	ROOF AND INTERIOR WALL SHEATHING TO FRAMING AND PARTICLEBOARD	WALL SHEATHING TO FRAMING		
5/16" - 1/2"	6d COMMON NAIL (SUBFLOOR, WALL) 8d COMMON NAIL (ROOF)	6	12	
19/32 " - 1"	8d COMMON NAIL	6	12	
$\frac{1}{2}$ " GYPSUM SHEATHING	$1\frac{1}{2}$ " GALVANIZED ROOFING NAIL; STAPLE GALVANIZED, $1\frac{1}{2}$ " LONG; $1-\frac{1}{4}$ " SCREWS, TYPE W OR S	7	7	
	$1\frac{3}{4}$ " GALVANIZED ROOFING NAIL; STAPLE GALVANIZED,			

ALTERNATE ATTACHMENTS

NOM. MATERIAL	DESCRIPTION OF FASTENER AND LENGTH	SPAC	SPACING OF FASTENERS		
THICKNESS (INCHES)	(INCHES)	EDGES (INCHES)	INTERMEDIATE SUPPORTS (INCHES)		
WOOD STRUCTURAL PANELS, SUBFLOO	I. R, ROOF AND INTERIOR WALL SHEATHING TO FRAMING AND PARTICLEBOAR		(
UP TO 2"	STAPLES 15 GA. 1 $\frac{3}{4}$ "	4	8		
	NAIL 2 1/4"	3	6		
	STAPLES 16 GA. 1 3/4 "	3	6		
23 32 " AND 3 "	STAPLES 14 GA. 2	4	8		
	STAPLES 15 GA. 1 3/4 "	3	6		
	NAIL 2 4"	4	8		

TABLE R602.3(3) REQUIREMENTS FOR WOOD STRUCTURAL PANEL WALL SHEATHING USED TO RESIST WIND PRESSURES

MINIMUN	MINIMUM NAIL MINIMUM WOOD		MINIMUM MAXII	MAXIMUM	MAXIMUM PANEL NAIL S	SPACING	MAXIMUM WIND SPEED (MPH)		
SIZE	PENETRATION (INCHES)	STRUCTURAL PANEL SPAN TH	PANEL THICKNESS (inches)	WALL STUD SPACING (inches)	EDGES (INCHES O.C.)	FIELD (INCHES O.C.)	WIND EXPOSURE CATEGORY B C D		TEGORY
6d COMMON (2.0" X 0.113")	1.5	24/0	3/8	16	6	12	110	90	85
8d COMMON (2.5" X 0.131")	1.75 24/16	7/16	16	6	12	130	110	105	
		24/16	24/16 7/16	24	6	12	110	90	85

GENERAL NOTES

- ALL CONSTRUCTION SHALL COMPLY WITH 2015 INTERNATIONAL RESIDENTIAL CODE - BUILDER MUST VERIFY ALL DIMENSIONS AND ACCURACY BEFORE CONSTRUCTION. - WRITTEN DIMENSIONS SHALL TAKE PRECEDENCE OVER SCALED MEASUREMENTS. - ALL STRUCTURAL LUMBER SHALL BE SPRUCE-PINE-FIR #2 OR BETTER, UNLESS OTHERWISE NOTED.
- IF APPLICABLE, WHERE GARAGE IS ATTACHED TO DWELLING UNIT, A (1) HOUR FIRE SEPARATION SHALL BE PROVIDED. (1 LAYER 1/2" DRYWALL) DOORS BETWEEN AREAS TO BE 20 MIN. C-LABEL DOOR WITH FIRE-CODE JAMB.
- ANY WOOD IN CONTACT WITH MASONRY TO BE PRESSURE-TREATED WOOD.
- GRADE MUST SLOPE AWAY FROM STRUCTURE. - WOOD FRAMING TO BE MIN. 8" FROM GRADE LEVEL, EXCEPT AT DOORWAYS.
- WOOD TRUSSES SHALL BE DESIGNED BY A REGISTERED ENGINEER, BUILDER MUST PROVIDE CUT-SHEETS TO CODE OFFICIAL PRIOR TO INSTALLATION.
- WALL BRACING PROVIDED BY CONTINUOUS SHEATHING METHODS AS PER SECTION 602.10.
- TEMPERED GLAZING REQUIREMENTS:
- (1) IN WINDOWS & DOORS WITHIN (18) INCHES OF WALKING SURFACE
- (2) IN ANY INDIVIDUAL PANEL GREATER THAN (9) SQ. FT. (3) - IN WINDOWS WITHIN (24) INCHES OF ANY OPENABLE DOOR WHEN DOOR IS IN CLOSED POSITION
- -BUILDING AREA = 672 S.F.

-BUILDING VOLUME = 11,424 C.F.	NEW GARAG	
CODE & LOADING INFORMATION	CONTACT INFORMATION	
	OWNER:	SHEET TITLE:
 OCCUPANCY TYPE = RESIDENTIAL STORAGE CONSTRUCTION TYPE = 5 B 	Maria Cerdenia	Cover sheet
- 1ST FLOOR SLAB ON GRADE	6122 Sligo Mill Rd. N.E.	DATE RECEIVED:
- ATTIC FLOOR LIVE = 30 PSF	Washington DC 20011	9/10/24
- SNOW LIVE = 30 PSF - DEAD LOADS = 10 PSF	Phone: 202-560-4831	SCALE:
- BASIC WIND SPEED = 115 MPH	1 1161161 202 300 1001	
- EXPOSURE CLASS C		AS NOTED
- FROST LINE DEPTH = 30" - SEISMIC DESIGN CATEGORY = B		DRAWING NO:
- SEISIVIC DESIGN CATEGORY = B - ASSUMED SOIL CLASS = GM, GC		D741-24
- SOIL BEARING CAPACITY = 2000 PSF		
(IF SOIL DIFFERS FROM ASSUMED		Board of Zonir
ABOVE REFER TO IRC CODES)		District of

Е

 ${\bf Designing \text{-} Drafting \text{-} 3D \ Color \ Renderings}$ 5219 Old Strasburg Rd. Kinzers, PA 17535 P. 717-442-5053 F. 717-370-5925

ANY CHANGES FROM THESE DRAWINGS MUST BE BROUGHT TO THE ATTENTION OF DRAFTING CONCEPTS AND APPROVED BEFORE CONSTRUCTION. ALL DIMENSIONS AND SITE CONDITIONS SHALL BE VERIFIED BY CONTRACTOR PRIOR TO CONSTRUCTION. THESE DRAWINGS SHALL NOT BE USED

JAMES A. KOPPENHAVER

FOR ANY OTHER PROJECTS.

555 VAN REED RD

WYOMISSING, PA 19610 PHONE: 484-794-9949

ITEM 9/25/24 FINAL


PROJECT TITLE:

EW GARAGE

TITLE: over sheet

RECEIVED: 9/10/24

> **AS NOTED** ING NO:

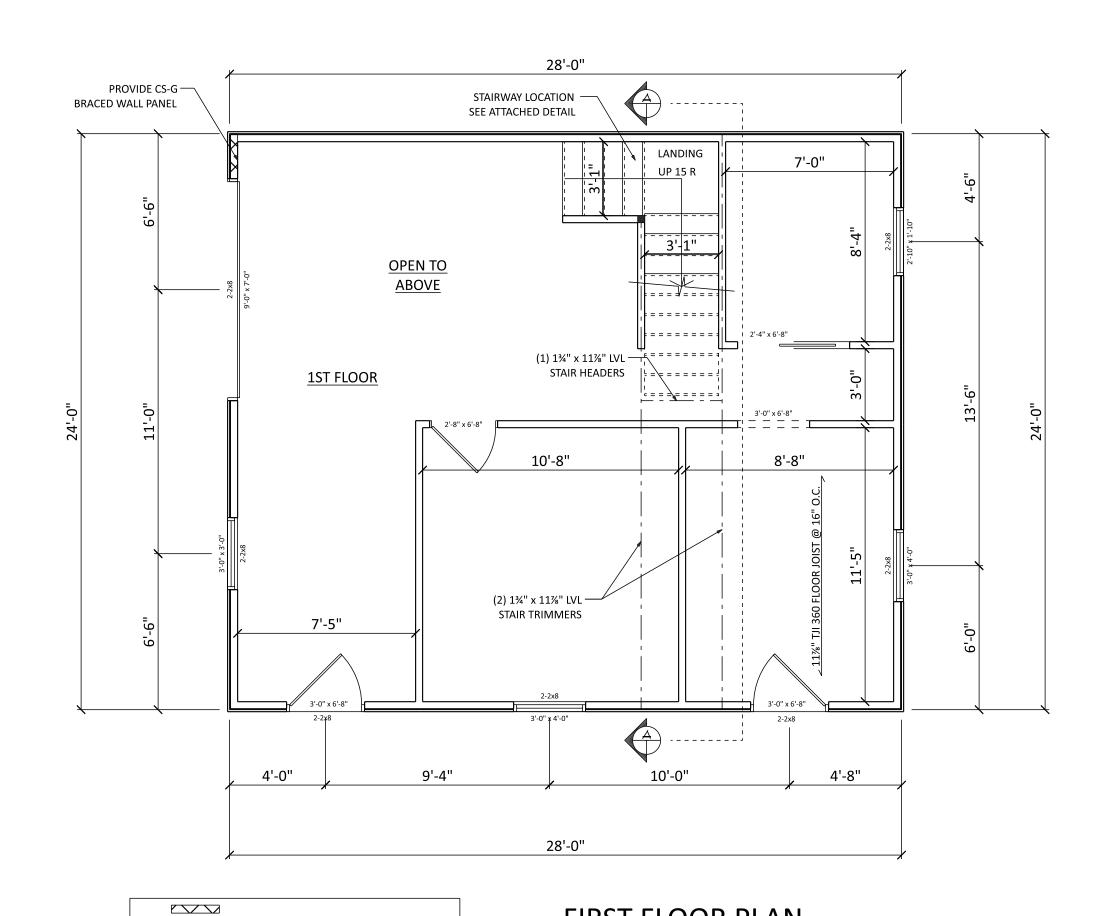


INDICATES CS-G BRACED WALL PANEL


8D COMMON (2½" × 0.131") NAILS AT 6" SPACING

(PANEL EDGES) AND AT 12" SPACING (INTERMEDIATE SUPPORTS)


FIRST FLOOR PLAN

SCALE: 1/4" = 1'-0"

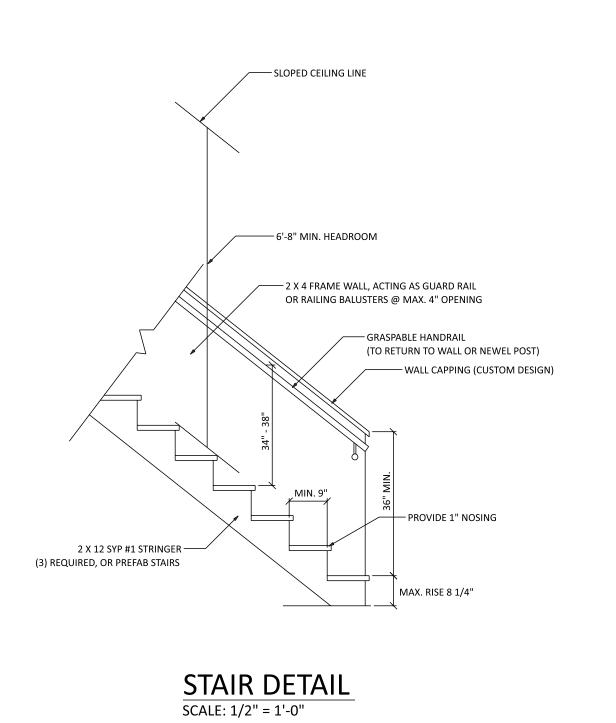


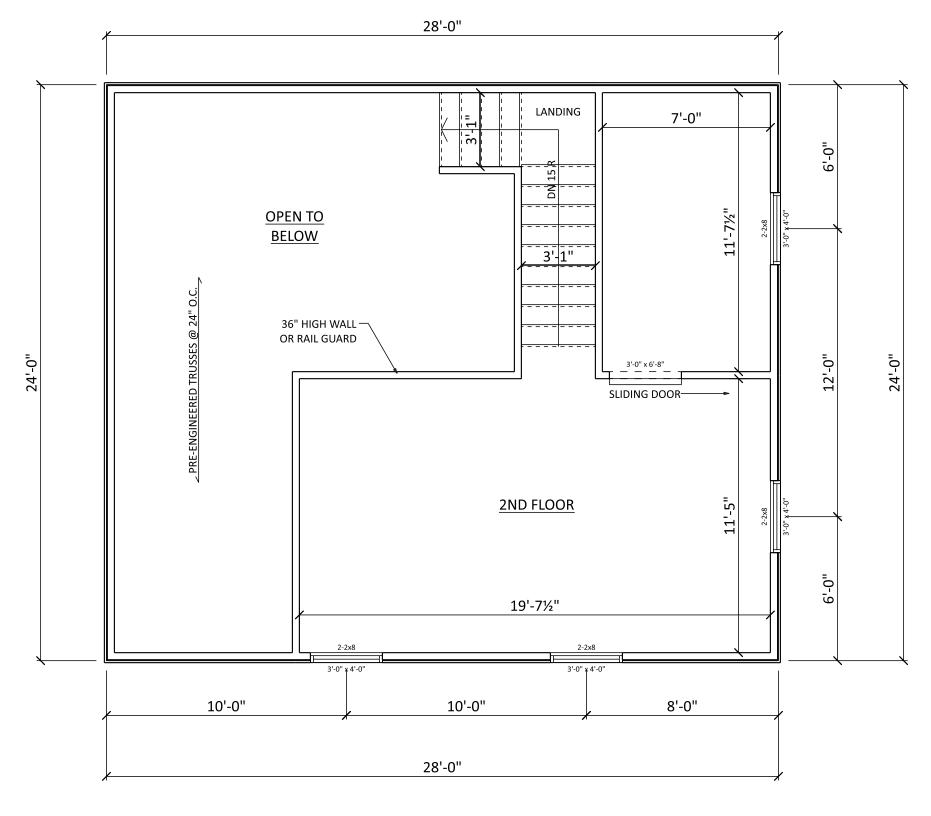

SECOND FLOOR PLAN
SCALE: 1/4" = 1'-0"

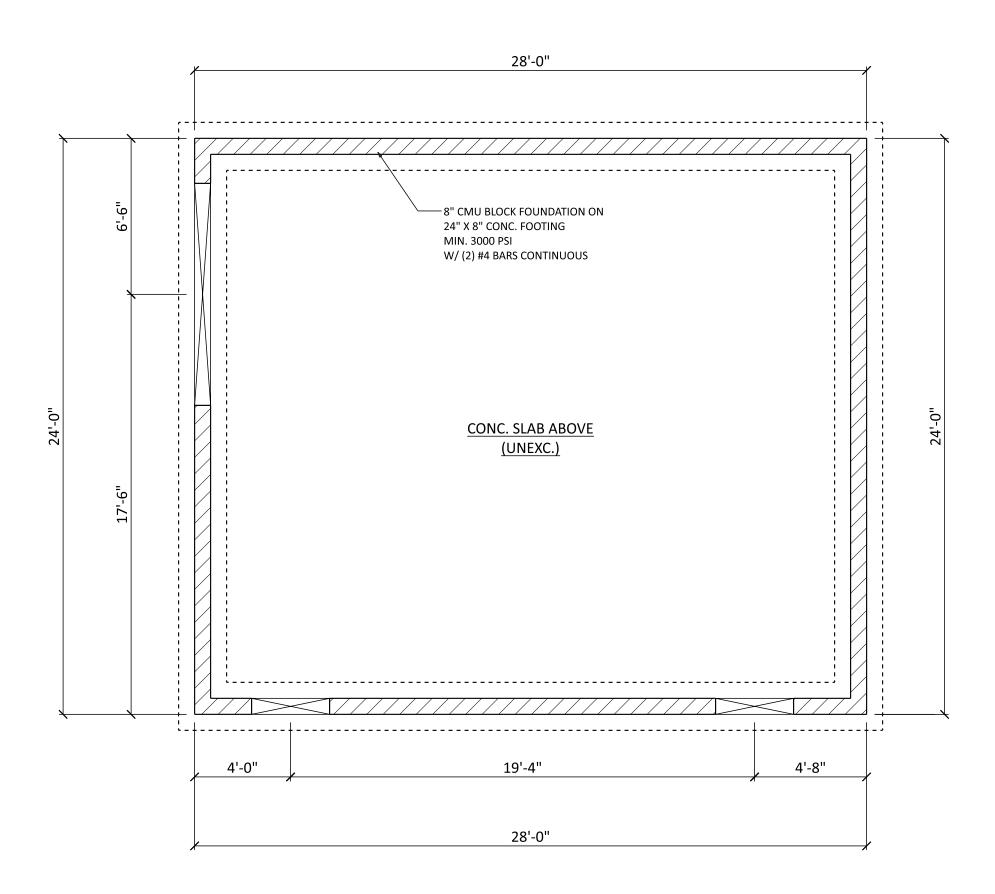

Existing Foundation Plan
SCALE: 1/4" = 1'-0"

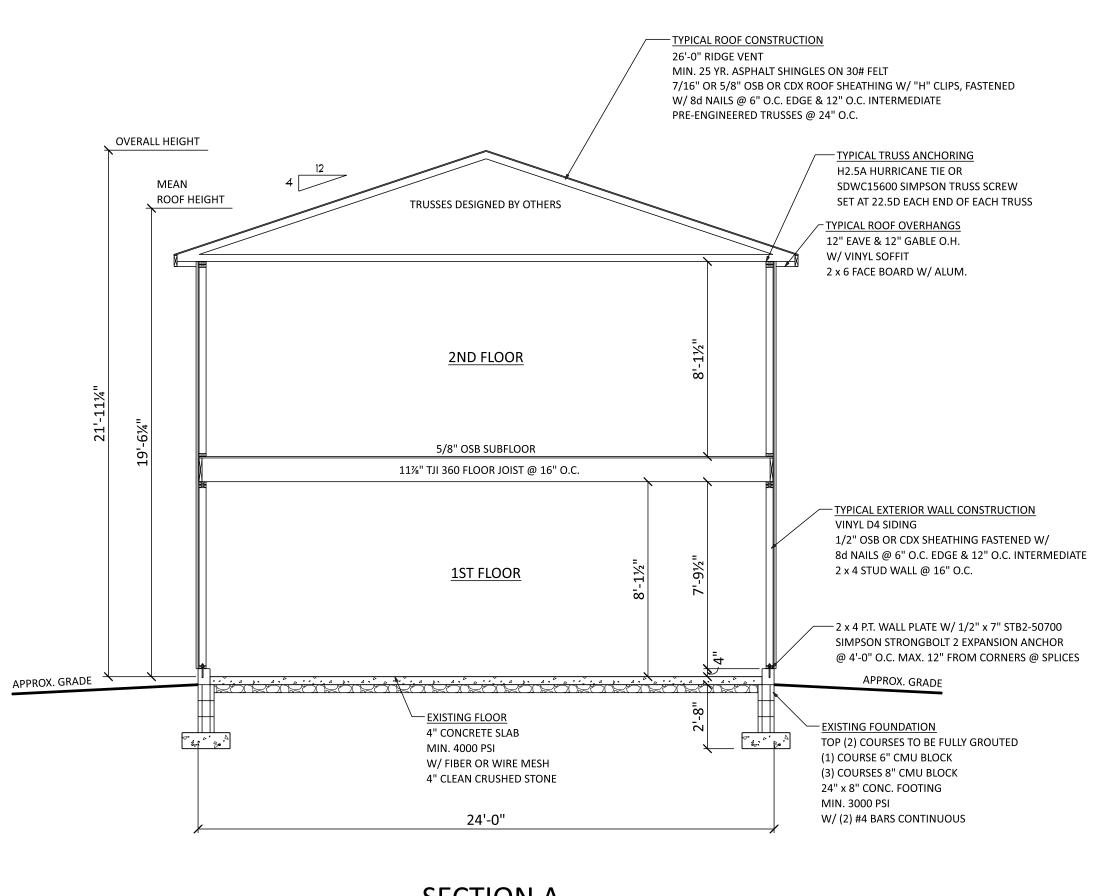

SECTION A

SCALE: 1/4" = 1'-0"

Е **DRAFTING** Designing - Drafting - 3D Color Renderings 5219 Old Strasburg Rd. Kinzers, PA 17535 P. 717-442-5053 F. 717-370-5925 ANY CHANGES FROM THESE DRAWINGS MUST BE BROUGHT TO THE ATTENTION OF DRAFTING CONCEPTS AND APPROVED BEFORE CONSTRUCTION. ALL DIMENSIONS AND SITE CONDITIONS SHALL BE VERIFIED BY CONTRACTOR PRIOR TO CONSTRUCTION.
THESE DRAWINGS SHALL NOT BE USED FOR ANY OTHER PROJECTS. JAMES A. KOPPENHAVER 555 VAN REED RD WYOMISSING, PA 19610 PHONE: 484-794-9949 ITEM FINAL PROJECT TITLE: **NEW GARAGE** SHEET TITLE:

Floor plans

9/10/24

AS NOTED

D741-24

DATE RECEIVED:

DRAWING NO:

SCALE: