SHEET LIST		
She	et No	Sheet Name

A00	COVER
A01	PROJECT INFORMATION
A02	LOCATION MAP
A03	EXISTING CONDITION PICTURES
A04	SITE PICTURES
A05	AREA PLANS - EXISTING & PROPOSED
A06	PARTIAL FLOOR PLANS - EXISTING & PROPOSED
A07	EXTERIOR ELEVATIONS - EXISTING & PROPOSED
A08	DETAILS
A09	SOLAR STUDY - WINTER SOLSTICE
A10	SOLAR STUDY - SPRING EQUINOX
A11	SOLAR STUDY - SUMMER SOLSTICE
A12	SOLAR STUDY - FALL EQUINOX



VIEW FROM REAR ALLEY

LAHAYE CAVAGNERO RESIDENCE - REAR YARD DECK

1738 HOBART ST NW, WASHINGTON DC 20009 | 25 MARCH 2025



PROJECT DESCRIPTION

CONSTRUCTION OF A WOOD-FRAME DECK IN THE REAR YARD OF AN ATTACHED SINGLE-FAMILY HOME

RELIEF REQUESTED:

11 DCMR § E 210 LOT OCCUPANCY EXCEPT AS PROVIDED ELSEWHERE IN THIS TITLE IN SUBTITLE § E 212.2, THE MAXIMUM PERMITTED LOT OCCUPANCY SHALL BE 60%


	BUILDING ADDRESS	1738 HOBART ST NW, WASHINGTON DC 20009
	SQUARE, SUFFICE, LOT	2588, 0103
	ZONE	RF-1
JURISDICTIONAL INFORMATION	JURISDICTION	WASHINGTON DC
DICTI RMA	HISTORIC DISTRICT	MOUNT PLEASANT HISTORIC DISTRICT
JRISI OFN	WARD, ANC, SMD	1, 1D, 1D05
= -	CLASSIFICATION OF WORK	RENOVATION + REAR DECK ADDITION
	APPLICABLE CODE	 11 DCMR ZONING REGULATIONS 2015 INTERNATION RESIDENTIAL CODE, AS AMMENDED BY 2017 DCMR 12B RESIDENTIAL CODE AMENDMENTS 2015 INTERNATIONAL ENERGY CONSERVATION CODE - RESIDENTIAL PROVISIONS, AS AMMENDED BY 2017 DCMR 12I

		ALLOWABLE/REQUIRED	EXISTING	PROPOSED
	USE CATEGORY	11 DCMR U §301	RESIDENTIAL	RESIDENTIAL
ZONING	LOT AREA	1,800 SF MIN	1,700 SF	1,700 SF
	LOT OCCUPANCY	60% MAX	62.17% (1,057 SF/1,700 SF)	69.64% (1,184 SF/1,700 SF)
	DENSITY	2 DWELLING UNITS MAX	1 DWELLING UNIT	1 DWELLING UNIT
CRITERIA	PARKING SPACES	1 PER 2 DWELLING UNITS MIN	0	0***
Y RIC	FRONT YARD SETBACK	NO LESSER OR GREATER THAN EXISTING SETBACKS ON THE SAME BLOCK	16'	16'
N. C. (B. C.	SIDE YARD SETBACK	NOT REQUIRED FOR PRINCIPAL BUILDING; 5' MIN IF PROVIDED	N/A	N/A
DESIGN	REAR YARD SETBACK	20' MIN	14.5'	4'-9.75"
	HEIGHT / STORIES *	35' MAX / 3 MAX	20' / 2 + CELLAR	20' / 2 + CELLAR
	PENTHOUSE HEIGHT / STORIES	12' MAX / 1 MAX	N/A	N/A
	PENTHOUSE AREA **	210 SF MAX	N/A	N/A
	PERVIOUS SURFACE	20% MIN	6% (102 SF)	6% (102 SF)

bestudio

CAVAGNERO LAHAYE RESIDENCE

PROJECT INFORMATION

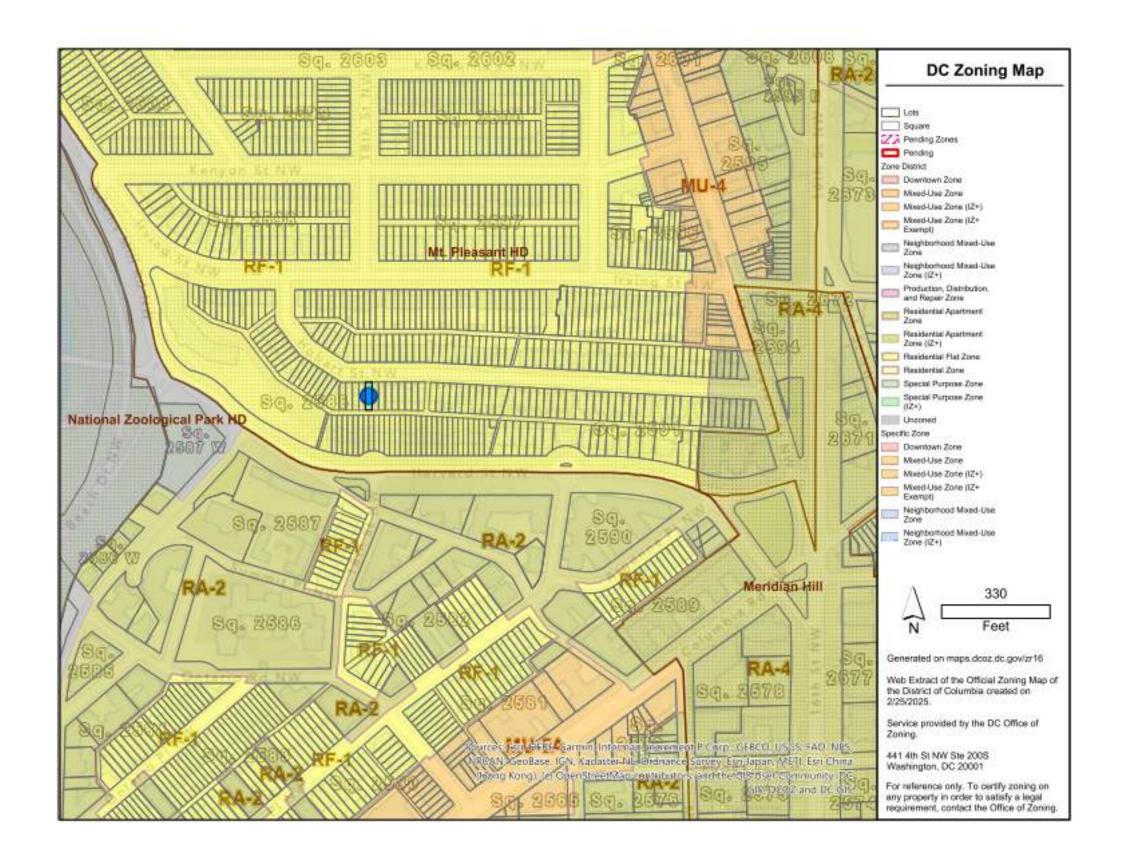

LOCATION MAP

GRAPHIC SCALE FOR REFENCE ONLY DO

GRAPHIC SCALE FOR REFENCE ONLY DO

NOT SCALE OFF DRAWINGS

0 2

OWNER: ELEONORA CAVAGNERO & JEROME LAHAYE


CAVAGNERO LAHAYE RESIDENCE

DATE: 03/28/2025

8



1 - REAR ALLEY LOOKING EAST

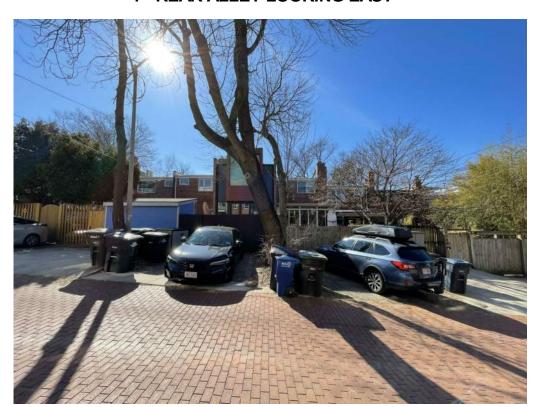

3 - REAR ALLEY LOOKING SOUTH



2 - REAR ALLEY LOOKING WEST



4 - SUBJECT PROPERTY REAR ELEVATION

EXISTING CONDITION PICTURES

A03

bestudio



5 - NEIGHBORING PROPERTY PRECEDENT




6 - REAR ALLEY LOOKING NORTH EAST


bestudio

CAVAGNERO LAHAYE RESIDENCE

SITE PICTURES

A04

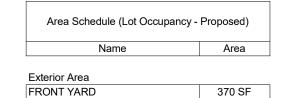

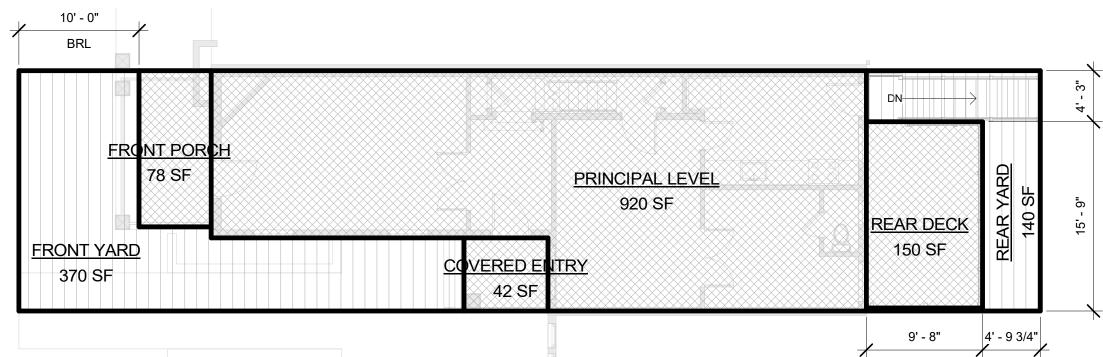

 REAR YARD
 140 SF

 510 SF

 Floor Area

 COVERED ENTRY
 42 SF

 FRONT PORCH
 78 SF


 PRINCIPAL LEVEL
 920 SF

 REAR DECK
 150 SF

 1,190 SF

1,190 SF 1,700 SF

2 LEVEL 01 - PROPOSED 1/8" = 1'-0"

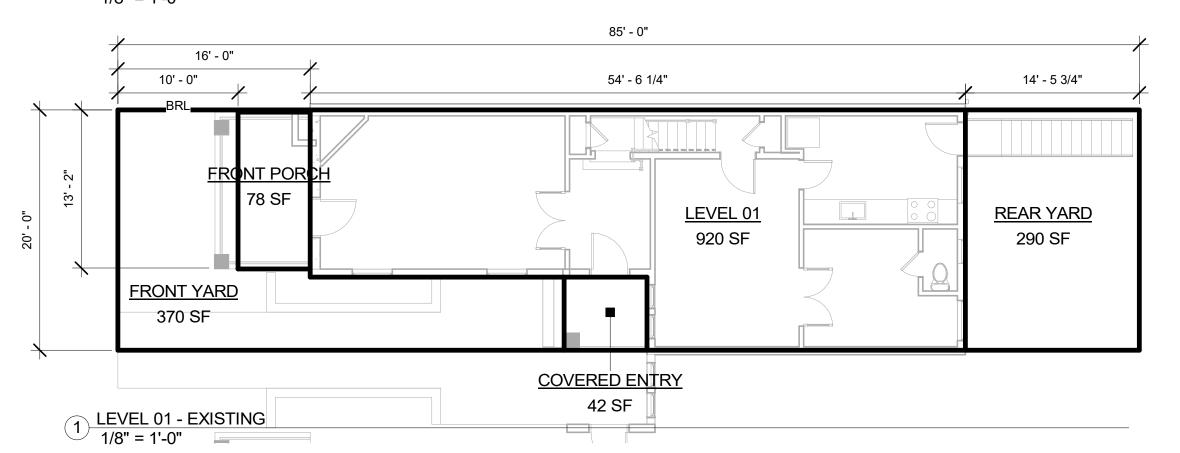

Area Schedule (Lot Occupa	ncy - Existing)
Name	Area

Floor Area	
LEVEL 01	920 SF
FRONT PORCH	78 SF
COVERED ENTRY	42 SF

1,040 SF

Exterior Area

FRONT YARD 370 SF

REAR YARD 290 SF

660 SF

1,700 SF

CAVAGNERO LAHAYE RESIDENCE

AREA PLANS - EXISTING & PROPOSED


1/8" = 1'-0"

GRAPHIC SCALE FOR REFENCE ONLY DO NOT SCALE OFF DRAWINGS


bestudio s o' 2' 8' 14'

OWNER: ELEONORA CAVAGNERO & JEROME LAHAYE DATE: 03/28/2025


A05

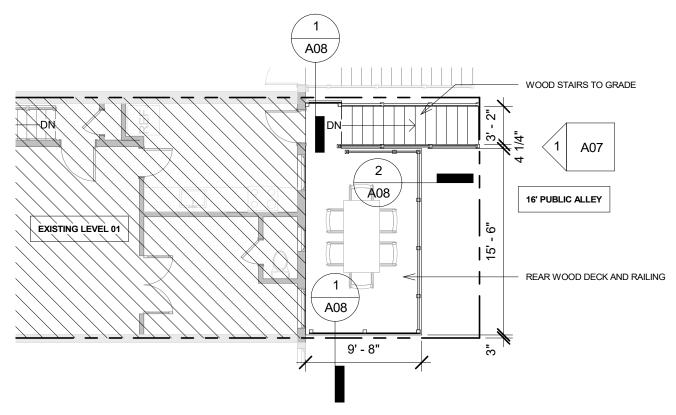


PARTIAL FLOOR PLAN - PROPOSED FIRST FLOOR 1/8" = 1'-0"

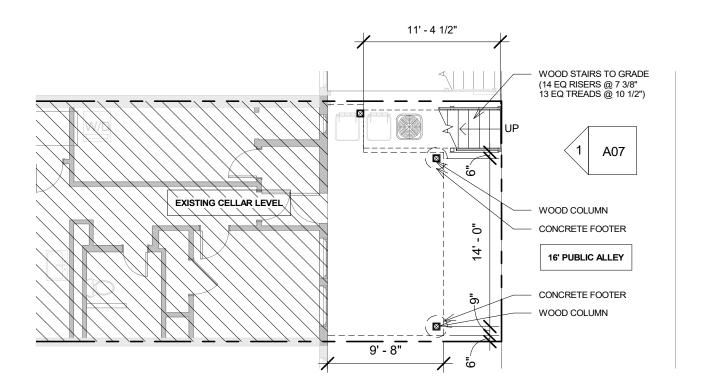

PARTIAL FLOOR PLAN - PROPOSED CELLAR 1/8" = 1'-0"

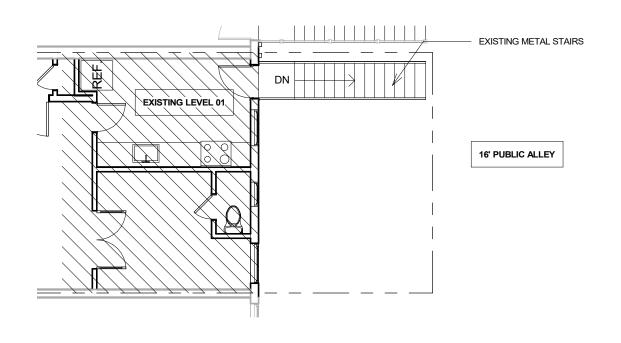


3 PARTIAL FLOOR PLAN - EXISTING FIRST FLOOR 1/8" = 1'-0"

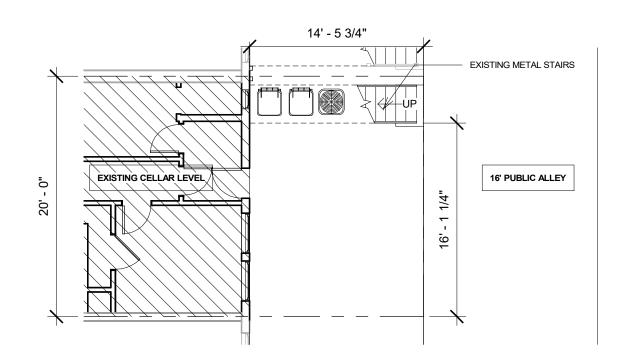


PARTIAL FLOOR PLAN - EXISTING CELLAR 1/8" = 1'-0"

DATE: 03/28/2025



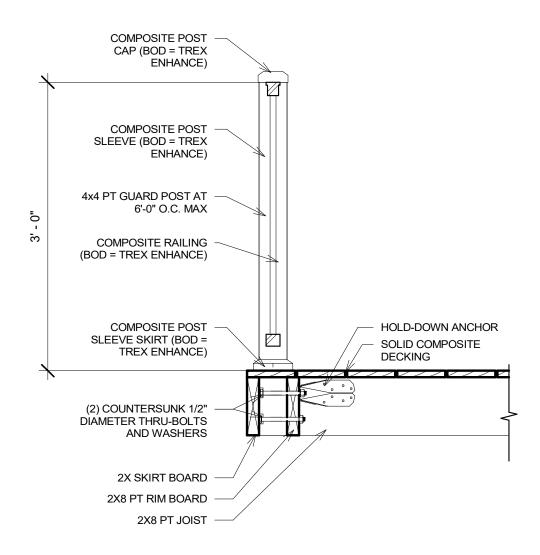

2 SECTION DETAIL - GUARD 1" = 1'-0"

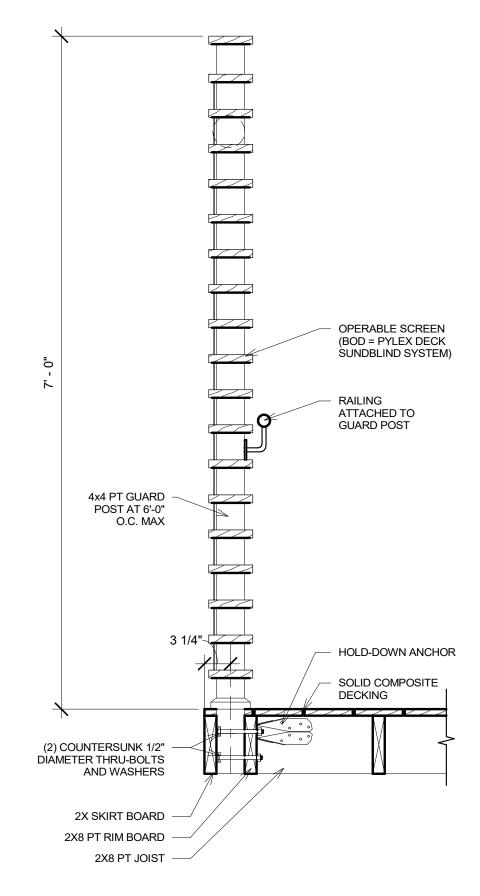

1 SECTION DETAIL - PRIVACY SCREEN
1" = 1'-0"

CAVAGNERO LAHAYE RESIDENCE

OWNER: ELEONORA CAVAGNERO & JEROME LAHAYE


DATE: 03/28/2025

DETAILS

OFF DATE: 05/28/2025




1 SOLAR STUDY - PROPOSED DESIGN AT WINTER SOLTICE MORNING

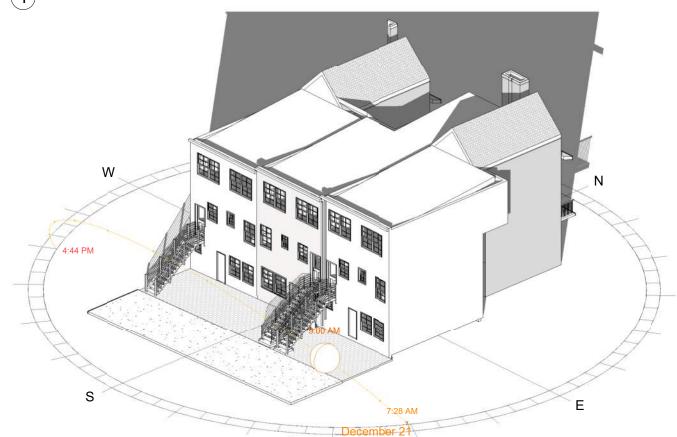

3 SOLAR STUDY - EXISTING DESIGN AT WINTER SOLTICE MORNING




2 SOLAR STUDY - PROPOSED DESIGN AT WINTER SOLTICE EVENING

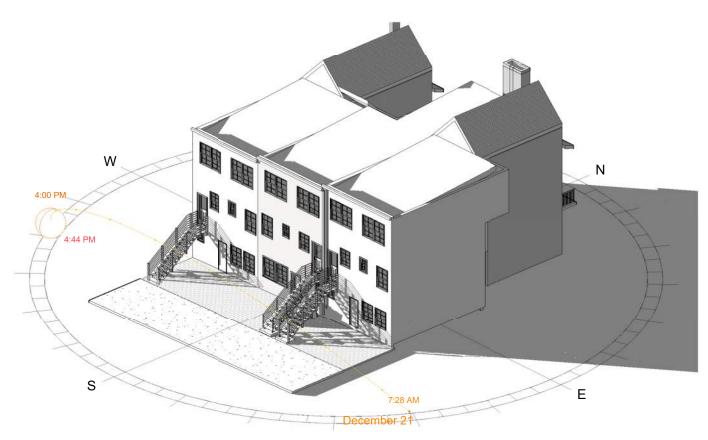


bestudio

SOLAR STUDY - EXISTING DESIGN AT WINTER SOLTICE EVENING

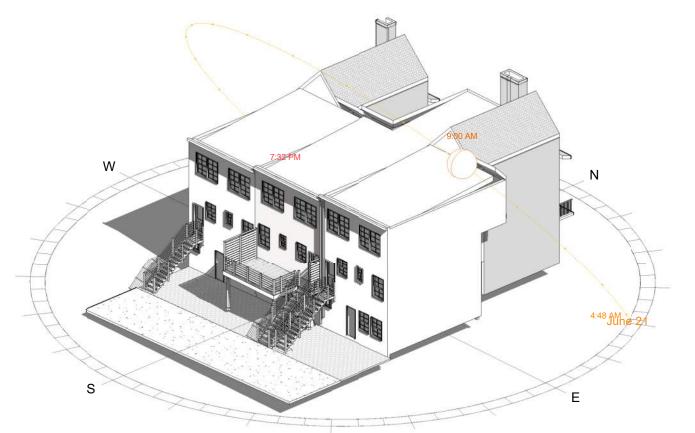

2 SOLAR STUDY - PROPOSED DESIGN AT SPRING EQUINOX EVENING

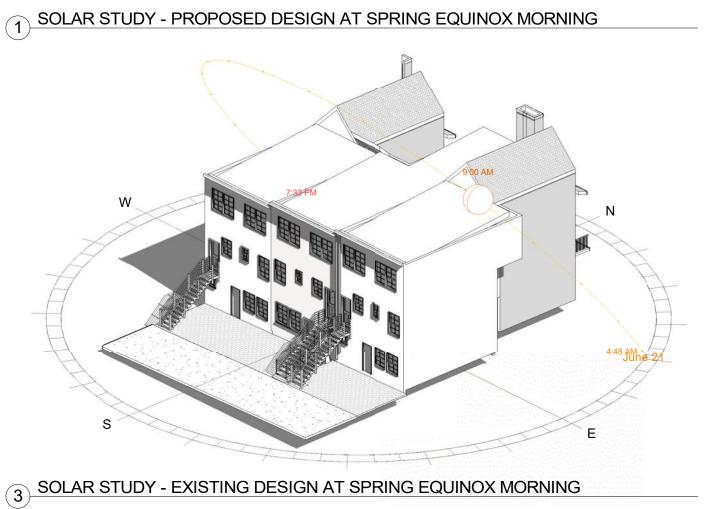

4 SOLAR STUDY - EXISTING DESIGN AT SPRING EQUINOX EVENING

CAVAGNERO LAHAYE RESIDENCE

SOLAR STUDY - SPRING EQUINOX

A10

GRAPHIC SCALE FOR REFENCE ONLY DO NOT SCALE OFF DRAWINGS


CE ONLY DO F DRAWINGS


bestudio

14'

OWNER: ELEONORA CAVAGNERO & JEROME LAHAYE

DATE: 03/28/2025

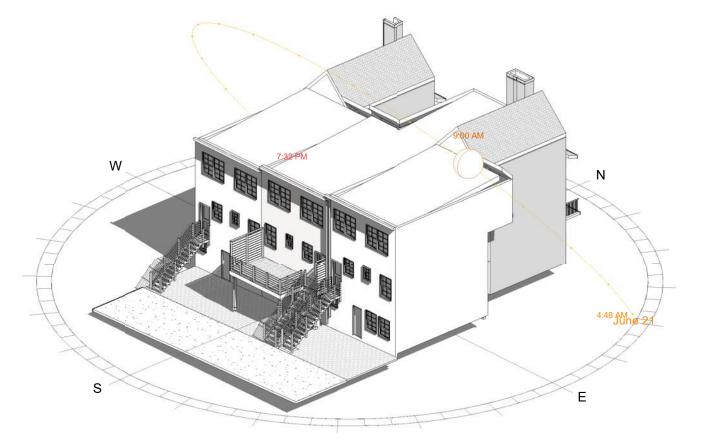


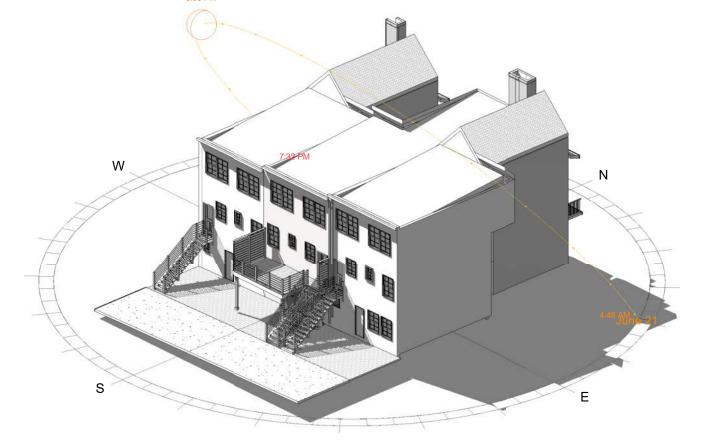

1 SOLAR STUDY - PROPOSED DESIGN AT SUMMER SOLTICE MORNING

SOLAN STODY - PROPOSED DESIGNAT SOMMEN SOLTICE MICHANING

2 SOLAR STUDY - PROPOSED DESIGN AT SUMMER SOLTICE EVENING

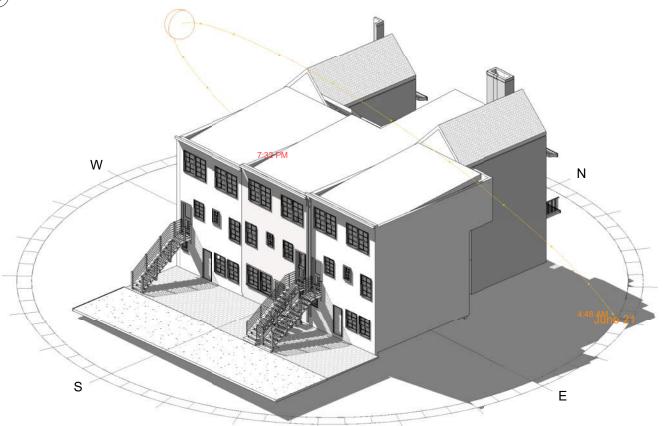

3 SOLAR STUDY - EXISTING DESIGN AT SUMMER SOLTICE MORNING

SOLAR STUDY - EXISTING DESIGN AT SUMMER SOLTICE EVENING

CAVAGNERO LAHAYE RESIDENCE


OWNER: ELEONORA CAVAGNERO & JEROME LAHAYE DATE: 03/28/2025


SOLAR STUDY - SUMMER SOLSTICE

GRAPHIC SCALE FOR REFENCE ONLY DO NOT SCALE OFF DRAWINGS

bestudio O' 2' 8'

A11

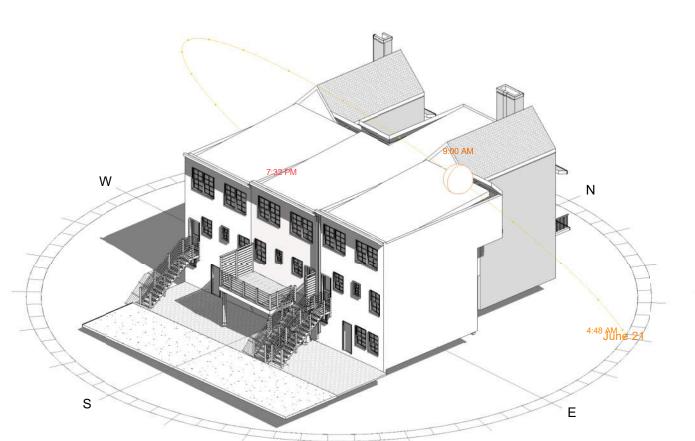

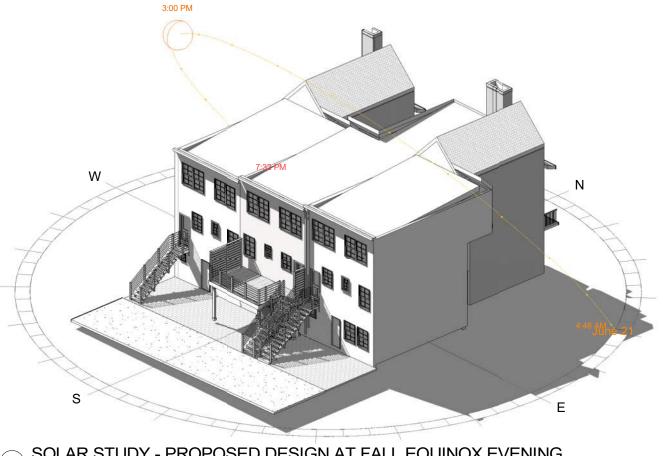


1 SOLAR STUDY - PROPOSED DESIGN AT FALL EQUINOX MORNING

8-90 AM

1-18 Wine 2-1

2 SOLAR STUDY - PROPOSED DESIGN AT FALL EQUINOX EVENING
3:00 PM

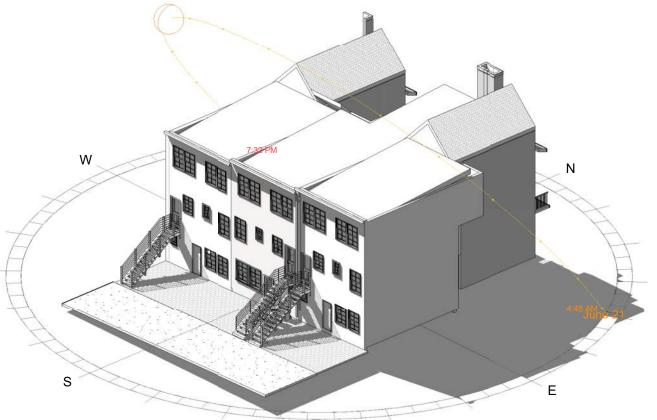

3 SOLAR STUDY - EXISTING DESIGN AT FALL EQUINOX MORNING

SOLAR STUDY - EXISTING DESIGN AT FALL EQUINOX EVENING

CAVAGNERO LAHAYE RESIDENCE

OWNER: ELEONORA CAVAGNERO & JEROME LAHAYE DATE: 03/28/2025

SOLAR STUDY - FALL EQUINOX

A12

GRAPHIC SCALE FOR REFENCE ONLY DO NOT SCALE OFF DRAWINGS

bestudio O' 2' 8' 14