PRIVATE RESIDENCE

903 'R' Street, N.W. Washington D.C. Lot 2 Square 363

CODE:

- -Plans conform with IRC/IECC codes 2018
- -All wood in contact with soil or masonry foundations will meet the ASTM standard A153 and A653, class 185.
- -All framing lumber to be SPF#2 unless indicated otherwise.
- -Design criteria used are as follows:
 - -Roof load -30lbs/sf.
 - -Roof and floor dead load I Olbs/sf.
 - -Seismic design category B.
 - -Termite damage subjectivity-moderate to heavy.
 - -Winter design temerature 15 degrees F, -9 degrees C.
 - -Subjectivity yo damage from weather -heavy.
 - -Subjectivity to decay -moderate.
 - -Floor live load in sleeping areas -40lbs/sf.
 - -Wind speed -90mph (3 sec. gust method) 90mph 40 m/s.
 - -Frost line depth -30".
 - -Flood hazard -yes.
- -Subfloors -3/4" APA subfloor/underlayment rated, tongue and groove, glued and nailed to joists.
- -Roof sheathing 1/2" OSB with spacers.
- -Roofing -2 | 5|bs per square asphalt shingles over | 5|b. felt.

SCOPE OF WORK:

BRAND NEW DECK CONSTRUCTION & BUILD ...
COMPLETELY DEMOLISH CURRENT DECK ... HAUL AWAY & DISPOSE OF ...

CREATION & BUILD OF A BRAND NEW DECK ... WITH ... METAL SPIRAL STAIRCASE ... TO THE GROUND LEVEL

- * BRAND NEW DECK WILL BE IN THE SIZE OF ... 14 FEET WIDE ... BY ... 12 FEET FORWARD ...
- * ALL NEW ... TREX "SELECT" COMPOSITE ... FLOOR BOARDS ... COLOR OF CHOICE
- * ALL NEW WOOD ... RAIL SYSTEM ... ALL THE WAY AROUND ... THIS NEW WOOD RAIL SYSTEM WILL BE IN THE SAME ... TYPE \$ STYLE ... AS IN THE PICTURE THAT HOMEOWNER SENT TO DECKMAN ...
- * ALL NEW ... METAL (BLACK IN COLOR) ... SPIRAL STAIRCASE ... ON THE ... LEFT HAND SIDE ... OF THE DECK (AS ONE IS STANDING IN THE BACKYARD LOOKING AT THE DECK) ... AND GOING DOWN TO THE GROUND LEVEL
- * ALL NEW WOOD SUB-STRUCTURE ... WITH ... 6 INCH BY 6 INCH ... SUPPORT POSTS ... WITH ... "CEMENT FOOTERS" (AS PER INSPECTION CODE) ...
- * ALL NEW WOOD ... "JOIST SUPPORT BOARDS" ... THAT GO UNDER THE TREX "SELECT" FLOOR BOARDS ...
- * "JOIST TAPE" ... WILL ALSO BE USED ON TOP OF ... JOIST SUPPORT BOARDS ... TO HELP PREVENT DETERIORATION
- * HAULING AWAY AND DISPOSING OF ALL OLD WOOD, TRASH \$ DEBRIS
- * ALL NEW WOOD WILL BE; GRADE A, PRESSURE TREATED, PRE-CURED (PRE-AGED), PINE WOOD ...
- * Brushing And Rolling On Our Proprietary "DeckMan"
 Protective Coating On Your Deck's ... Outside Fascia Boards,
 Visible Wood Support Posts ... Color To Match The Trex
 "Select" Floor Colors Or Other Color Of Choice ...

INDEX	
COVER SHEET	CS01
PROPOSED FIRST FLOOR PLAN	A001
PROPOSED SECOND FLOOR PLAN	A002
PROPOSED REAR ELEVATION	A003
PROPOSED LEFT ELEVATION	A004
STAIR DETAILS	A005
3D VIEW	A006
3D VIEW	A007
3D VIEW	800A
SECOND FLOOR FRAMING PLAN	S001

NEW DECK BUILD Matt Bosserman 903 'R' Street, N.W. Washington D.C. Lot 2 Square 363

Scale:
As Noted

Date:
14/01/2024 07:50:11

DATE

Designed By:

REVISION

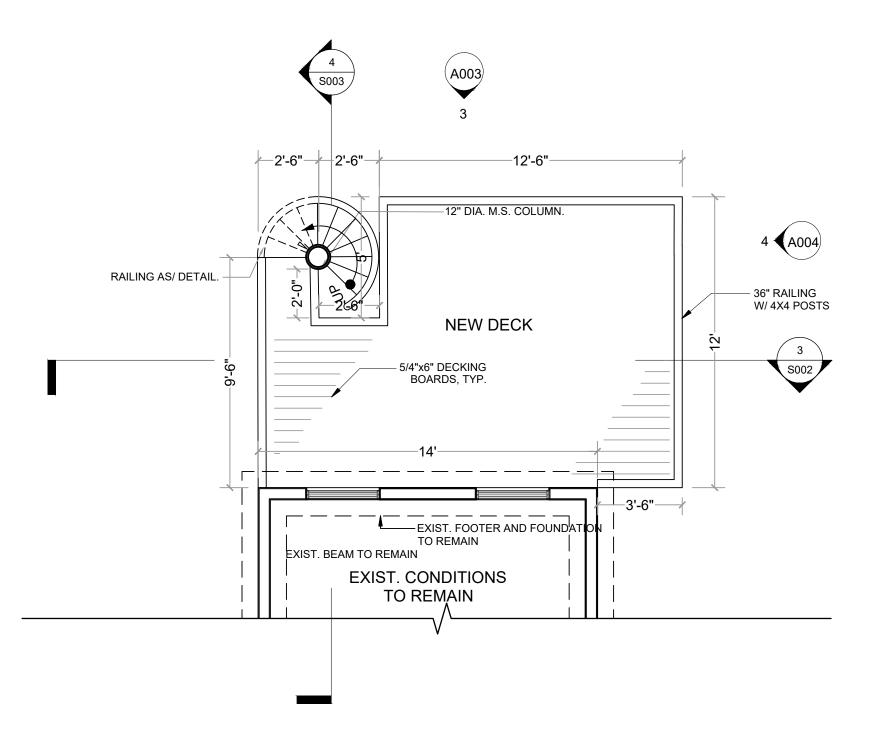
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CS01

COVFR SHFFT

ard of Zoning Adjustment District of Columbia



LEGEND:

EXISTING WALLS TO REMAIN

EXISTING DOORS TO REMAIN

EXISTING WINDOWS TO REMAIN

EX.

NEW DECK BUILD

Matt Bosserman

903 'R' Street, N.W.

Washington D.C.

Scale:
As Noted
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4/01/2024 08:10:11

Lot

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Drawn By: A.H.M. Mahmood Hasan

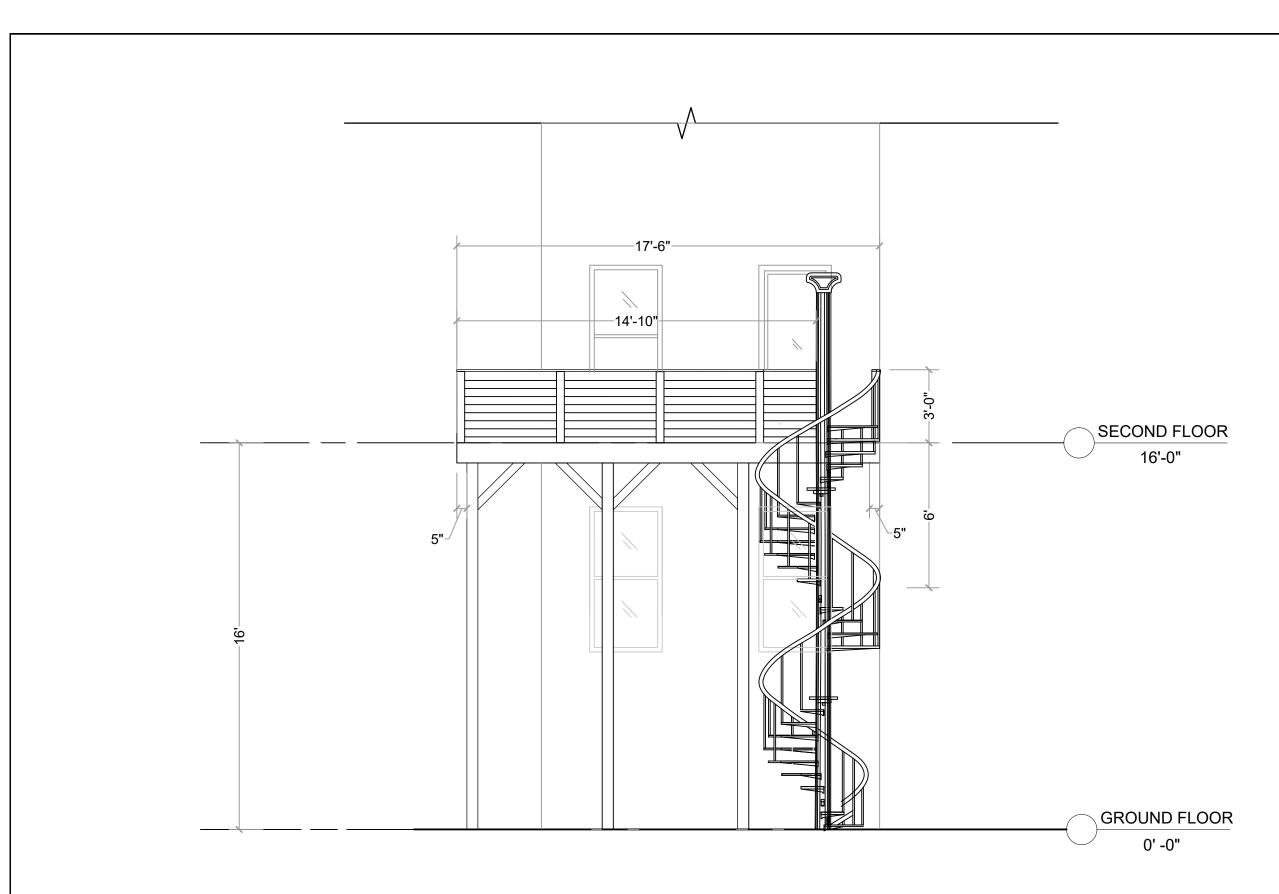
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A002

PROPOSED FLOOR PLANS

PROPOSED SECOND FLOOR PLAN

SCALE: 1/4" = 1'-0"



PROPOSED REAR ELEVATION

SCALE: 1/4" = 1'-0"

NEW DECK BUILD Matt Bosserman 903 'R' Street, N.W. Washington D.C. Lot 2 Square 363

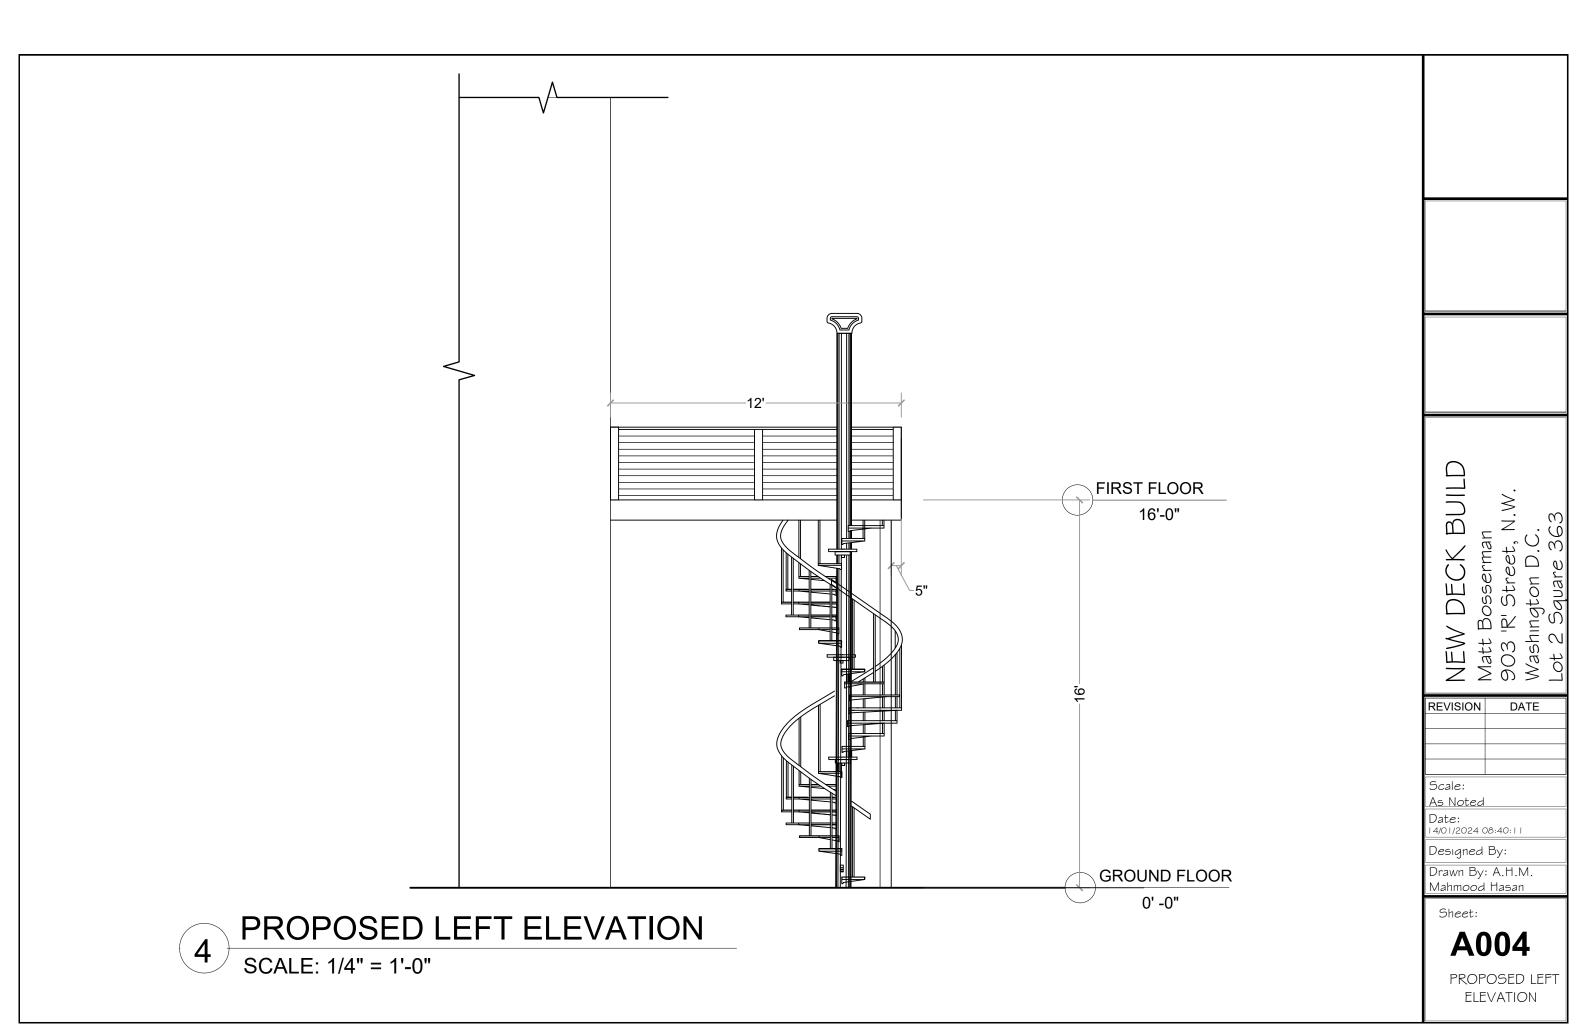
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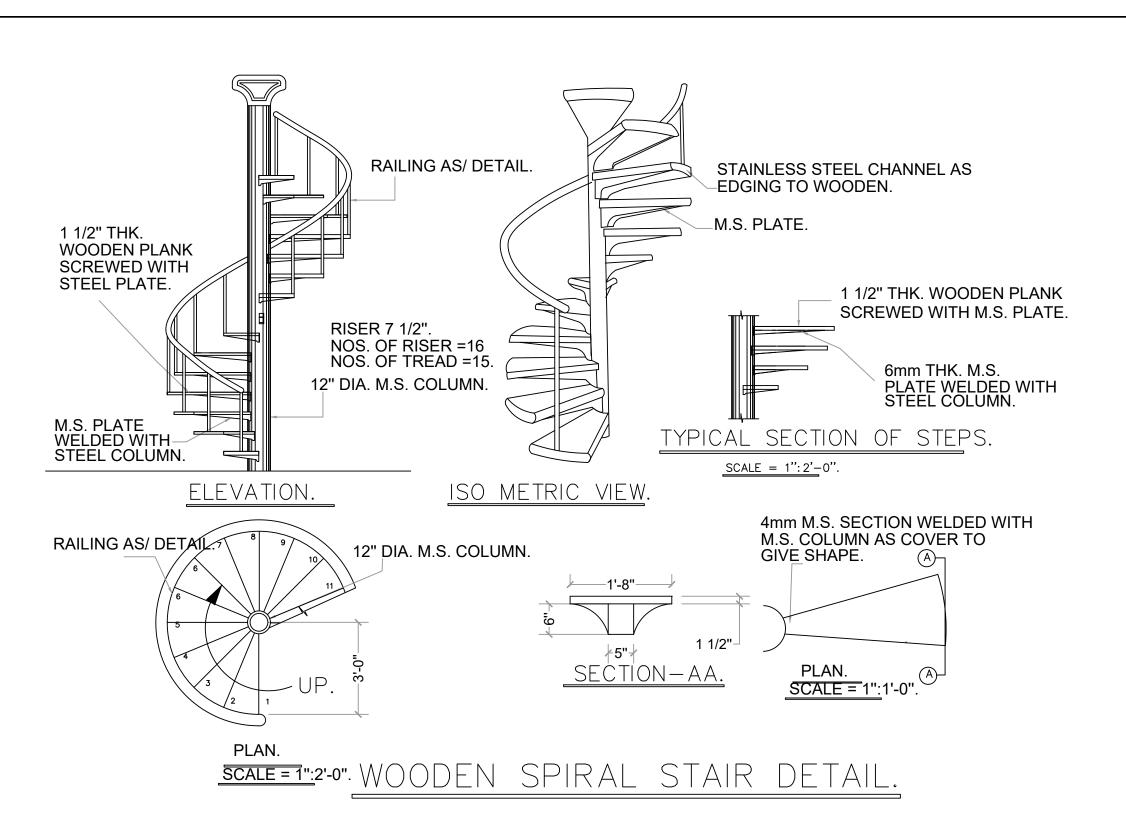
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PROPOSED REAR ELEVATION





STAIR DETAILS

SCALE: 1/4" = 1'-0"

NEW DECK BUILD
Matt Bosserman
903 'R' Street, N.W.
Washington D.C.
Lot 2 Square 363

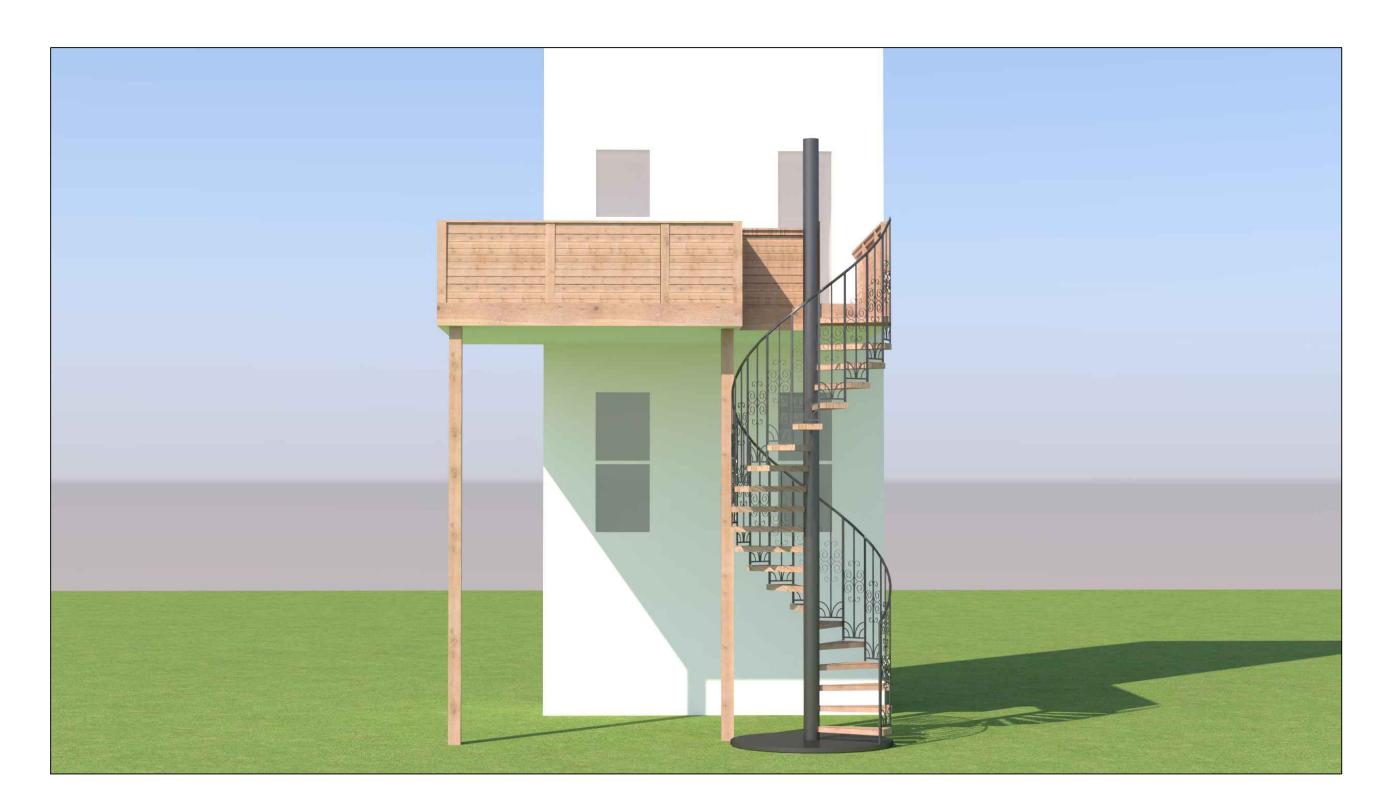
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STAIR DETAILS



6 3D VIEW
SCALE: NOT TO SCALE

NEW DECK BUILD
Matt Bosserman
903 'R' Street, N.W.
Washington D.C.
Lot 2 Square 363

REVISION DATE

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Drawn By: A.H.M.
Mahmood Hasan

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A006

3D VIEW



7

3D VIEW

SCALE: NOT TO SCALE

NEW DECK BUILD
Matt Bosserman
903 'R' Street, N.W.
Washington D.C.
Lot 2 Square 363

REVISION DATE

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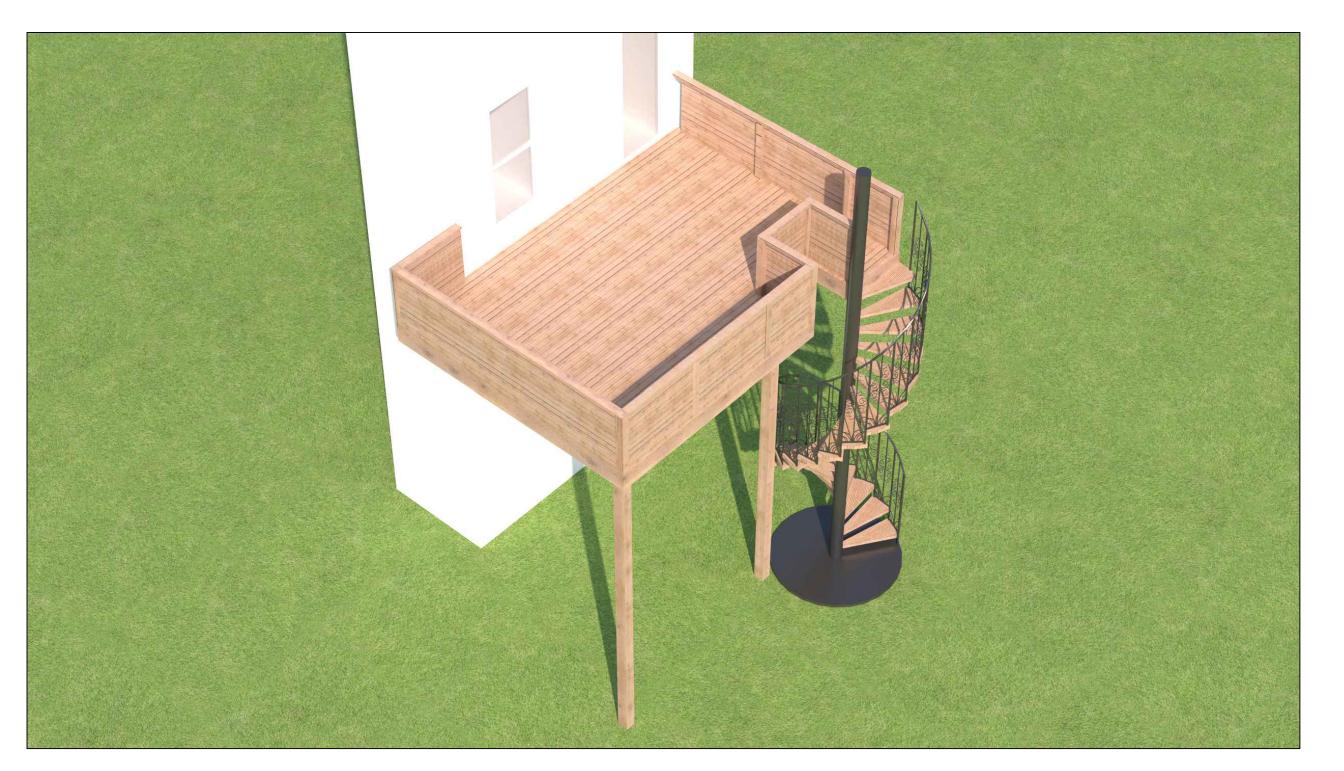
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3D VIEW



8 3D VIEW

SCALE: NOT TO SCALE

NEW DECK BUILD
Matt Bosserman
903 'R' Street, N.W.
Washington D.C.
Lot 2 Square 363

REVISION DATE

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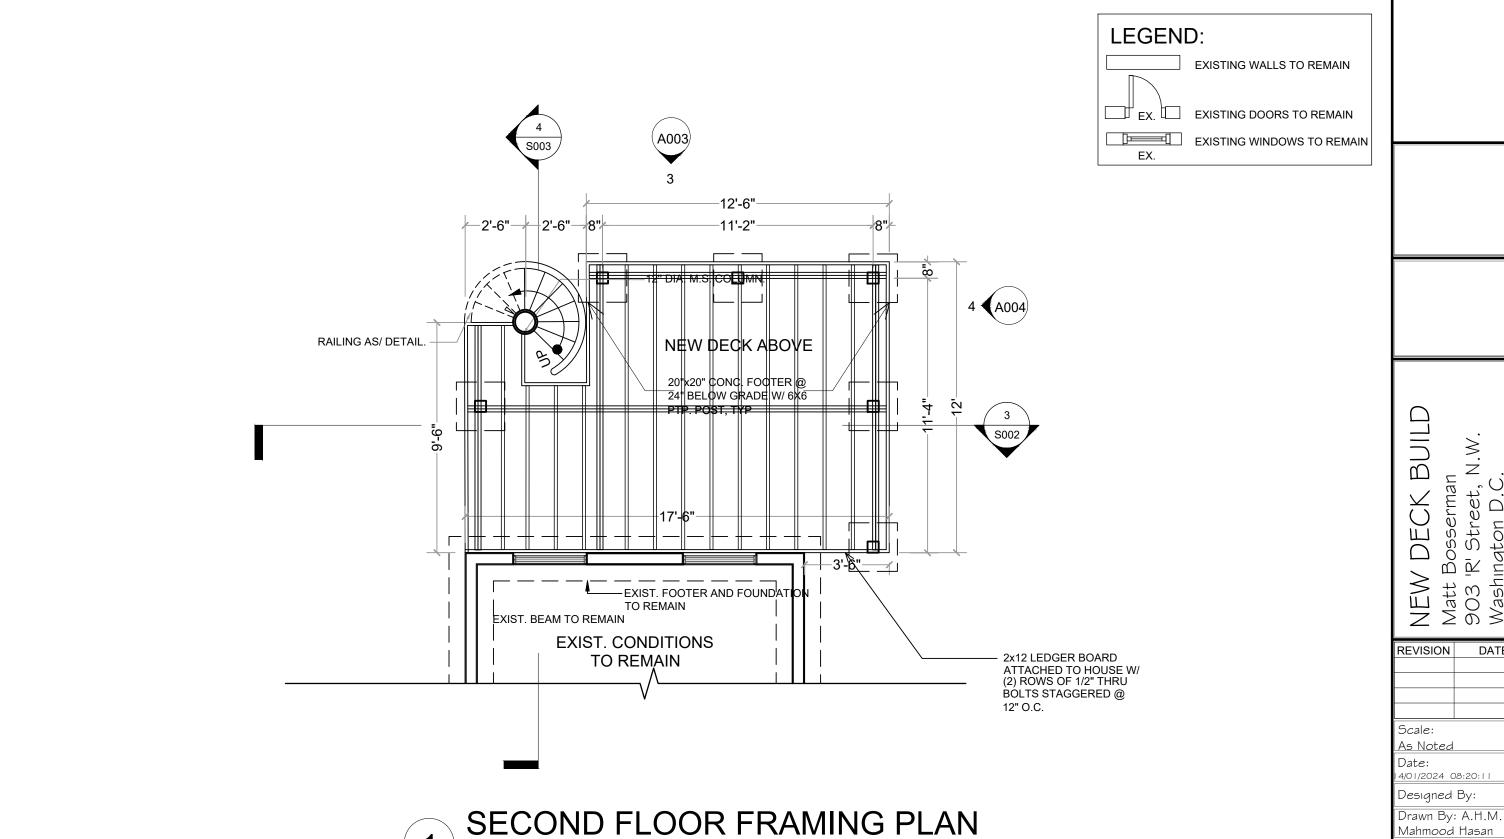
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Drawn By: A.H.M. Mahmood Hasan

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A008

3D VIEW



SCALE: 1/4" = 1'-0"



NEW DECK BUILD Matt Bosserman 903 'R' Street, N.W. Washington D.C. Lot 2 Square 363

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FLOOR FRAMING **PLANS**