#### BEFORE THE DISTRICT OF COLUMBIA BOARD OF ZONING ADJUSTMENT

#### APPLICATION OF D.C. DEPARTMENT OF GENERAL SERVICES

ANC 3F

#### STATEMENT OF THE APPLICANT

#### I. <u>NATURE OF RELIEF SOUGHT</u>

This statement is submitted on behalf of the Applicant, District of Columbia Department of General Services (the "Applicant"), the operator<sup>1</sup> of the property known as "Hearst Park" located at 3950  $37^{\text{th}}$  Street NW (Square 1905, Lot 802) (the "Property"), in support of its application for special exception relief, pursuant to 11 DCMR Subtitle X § 901.2, from the requirements for vehicular parking (Subtitle C § 701.5) for new public parks and recreation facilities.

#### II. JURISDICTION OF THE BOARD

The Board of Zoning Adjustment (the "Board") has jurisdiction to grant the special exception relief requested herein pursuant to Subtitle X § 901.2 of the Zoning Regulations.

#### III. <u>BACKGROUND</u>

#### A. The Property and the Surrounding Neighborhood

The Property is in the R-1-B Zone District and is a large lot of 191,668 sq. ft. A copy of the zoning map is attached at <u>**Tab A**</u>. The Property is a public park known as "Hearst Park" that is operated by the Applicant. The Property is improved with tennis courts and a soccer field. There is no curb cut at the Property. The Property is not located in a historic district.

<sup>&</sup>lt;sup>1</sup> The Property is owned by the federal government, but is operated by the District of Columbia and the Department of General Services.

The Property is well-buffered by trees and vegetation from the surrounding Cleveland Park neighborhood. There is also a significant grade change at the Property particularly along 37<sup>th</sup> Street NW, Quebec Street NW, and the shared lot line with Hearst Elementary School. Thus, the park area of the Property is approximately 15-20' lower than the street level along the western, southern, and northern sides of the Property.

The Property is bound by 37<sup>th</sup> Street NW to the west, Quebec Street NW to the south, Idaho Avenue NW to the east, and the Hearst Elementary School to the north. There is a basketball court, a playground, and a recreation center located on the Hearst Elementary School lot, which is owned by the District of Columbia. The surrounding neighborhood is generally single-family, detached homes. The Sidwell Friends School is directly across 37<sup>th</sup> Street and Wisconsin Avenue is one block to the west of the Property.

#### **B.** Traffic Conditions and Mass Transit

The Property is well-serviced by public transportation. There are several bus stops within one to two blocks of the Property, including lines 30N, 30S, 31, 33, 37, 96, H3, H4, D32 and W47.<sup>2</sup> The Van Ness Metrorail Station is approximately ½ of a mile from the Property and the Cleveland Park Metrorail Station is less than <sup>3</sup>/<sub>4</sub> of a mile from the Property. There is a Capital Bikeshare station at Wisconsin and Newark Street NW, which is three blocks from the Property. A second Capital Bikeshare station is located approximately 0.3 miles away at Wisconsin Avenue and Veazy Street NW.

In terms of on-street parking, there is time-restricted parking along both sides of 37<sup>th</sup> Street NW. On the north-bound side, parking is limited to four hours, and on the south-bound side

 $<sup>^2</sup>$  Bus routes 31 and 37 are "priority" bus routes, although the Property is not entitled to the 50% exemption from parking under Subtitle C § 702.1(c) because it is in the R-1-B zone.

parking is limited to two hours. Likewise, there is two-hour restricted parking on Quebec Street NW.

#### C. The Project

The Applicant proposes to improve and enhance the facilities at Hearst Park, including the addition of an outdoor swimming pool and adjacent pool house (the "Project"). A copy of the architectural plan set is attached at <u>**Tab B**</u>. The pool house is the only structure that is part of the Project and will be located at and replace the existing tennis courts. The pool house is a two-story building that will front on 37<sup>th</sup> Street NW and will have approximately 5,749 square feet of gross floor area. *See <u>Tab B</u>*.

As part of the Project, the Applicant will renovate the two tennis courts, add a tennis practice wall, and a new grass soccer field. The Applicant will also replace the existing concrete park pathways with raised wood paths. The existing heritage Willow Oak trees will be fully preserved.

The Project will meet all the development standards in the R-1-B zone with the exception of parking, as described below.

#### IV. <u>NATURE OF SPECIAL EXCEPTION RELIEF SOUGHT AND STANDARD</u> <u>OF REVIEW</u>

The Applicant requests special exception relief from the requirements for vehicular parking. Under Subtitle C § 701.5, a parks and recreation facility requires 0.5 parking spaces per 1,000 sq. ft. of gross floor area. The Project proposes approximately 5,749 square feet of gross floor area, which would require three parking spaces. The Project does not propose to provide any parking.

Under D.C. Code § 6-641.07(g)(2) and 11 DCMR X § 901.2, the Board is authorized to grant a special exception where it finds the special exception:

Will be in harmony with the general purpose and intent of the Zoning Regulations and Zoning Maps;
 Will not tend to affect adversely, the use of neighboring property in accordance with the Zoning Regulations and Zoning Maps; and
 Subject in specific cases to special conditions specified in the Zoning Regulations. 11 DCMR Subtitle X § 901.2.

Relief granted through a special exception is presumed appropriate, reasonable, and compatible with other uses in the same zoning classification, provided the specific requirements for the relief are met. In reviewing an application for special exception relief, "[t]he Board's discretion . . . is limited to a determination of whether the exception sought meets the requirements of the regulation." *First Baptist Church of Wash. v. District of Columbia Bd. of Zoning Adjustment*, 432 A.2d 695, 701 (D.C. 1981) (quoting *Stewart v. District of Columbia Bd. of Zoning Adjustment*, 305 A.2d 516, 518 (D.C. 1973)). If the applicant meets its burden, the Board must ordinarily grant the application. *Id*.

#### V. APPLICANT MEETS BURDEN FOR SPECIAL EXCEPTION RELIEF

#### A. The Relief is Harmonious with the General Purpose and Intent of the Zoning Regulations and Maps

The Project will be in harmony with the purpose and intent of the Zoning Regulations and related maps. The Project will further the purpose of the R-1-B zone to promote stable residential areas and a suitable environment for family life. Subtitle D § 300.1(b). The improvements to Hearst Park are intended to benefit the community by upgrading the facilities and adding a public outdoor swimming pool. To that end, Ward 3 is the only ward in DC that does not have an outdoor public swimming pool.

The park will better meet its purpose to serve the community without parking. If the Applicant were required to set aside space for three parking spaces, plus a curb cut, it would remove valuable wooded and/or recreation space from the park. As the park is intended to

primarily serve the nearby community, it is expected that many people will access the park by walking or public transportation. Accordingly, the parking relief is harmonious with the purpose and intent of the Zoning Regulations.

#### B. The Relief will not tend to Adversely Affect the Use of Neighboring Property

The existing Hearst Park facilities do not have parking, so the Project will maintain existing conditions. Nonetheless, it is expected that many community members will walk to the park. There is ample on-street parking in the vicinity. In particular, there is public parking on 37<sup>th</sup> Street NW that does not require a residential parking permit. Further, there are several public transportation options to access the Property, including Metrobus and Metrorail. Accordingly, the parking relief will not adversely affect neighboring property.

#### C. The Project Satisfies the Special Conditions of Subtitle C § 703

In addition to the general special exception standard, the Project satisfies the special conditions for parking relief pursuant to Subtitle C § 703, as follows:

# i. The Applicant meets several of the conditions for parking relief under Subtitle C § 703.2.

(a) Due to the physical constraints of the property, the required parking spaces cannot be provided either on the lot or within six hundred feet (600 ft.) of the lot in accordance with Subtitle  $C \S 701.8$ ;

Due to the characteristics of the park, the required parking spaces cannot be provided at the Property. There are no existing curb cuts at the Property and, therefore, no means for vehicular ingress/egress. Providing a curb cut would require breaking up the existing sidewalk.

To compound the lack of curb cuts, the Property is ringed by trees and other natural vegetation. On 37<sup>th</sup> Street NW and Quebec Street NW there is a thick and uninterrupted line of vegetation along the Property's western and southern lot lines. The adjacent public space on 37<sup>th</sup> Street is also dotted with large, mature trees. The Property's eastern lot line on Idaho Avenue NW

is not as heavily planted, but still features a row of large, existing trees that will be preserved. Many of the Property's existing trees are heritage Willow Oak trees that will be preserved. The Property's northern lot line is landlocked by the Hearst Elementary School lot.

There is also a significant change in grade, particularly along 37<sup>th</sup> Street and Quebec Street. This change in grade creates a condition where the park is approximately 15-20' below street level along the western and southern lot lines. The change in grade creates constraints in providing any vehicular access to the Property.

In addition to the physical constraints, to locate parking on the Property would substantially disrupt the intended programming for the park. The pool house, pool, and tennis courts are located on the southern end of the Property and the soccer field takes up much of the remainder of the lot. There is a walking path that rings the Property that would be disrupted by parking.

Accordingly, due to the physical constraints of the Property, the required parking spaces cannot be provided.

# *(b) The use or structure is particularly well served by mass transit, shared vehicle, or bicycle facilities;*

The Property is well-serviced by public transportation, including numerous bus lines, metro stations, and bike share facilities. There is a bus stop for lines H3 and H4 one block from the Property at the corner of Porter Street and Idaho Avenue NW. There are also bus stops approximately two blocks from the Property on Wisconsin Avenue that provide access to bus lines 30N, 30S, 31, 33, 37, 96, H3, and H4.<sup>3</sup> The Van Ness Metrorail Station is approximately <sup>1</sup>/<sub>2</sub> of a mile from the Property and the Cleveland Park Metrorail Station is less than <sup>3</sup>/<sub>4</sub> of a mile from the Property. There are two Capital Bikeshare stations within 0.3 miles of the Property.

 $<sup>^3</sup>$  Bus routes 31 and 37 are "priority" bus routes, although the Property is not entitled to the 50% exemption from parking under Subtitle C § 702.1(c) because it is in the R-1-B zone.

(e) The nature of the use or structure or the number of residents, employees, guests, customers, or clients who would reasonably be expected to use the proposed building or structure at one time would generate demand for less parking than the minimum parking standards;

The Project is intended to serve the nearby community. As with most parks in the District, it is expected that neighbors will walk to the park and would not require vehicular parking. The proposed pool house is devoted to servicing the pool, and no other uses will be located within the pool house. Thus, with the exception of a limited number of staff, the structure will not attract more guests or visitors than the pool itself.

# *(i) The presence of healthy and mature canopy trees on or directly adjacent to the property;*

The Property is ringed by healthy and mature canopy trees along each street lot line. *See* <u>**Tab C**</u>. Hearst Park is densely planted with trees and vegetation, particularly along 37<sup>th</sup> Street, Quebec Street and Idaho Avenue. The Applicant would have to remove mature canopy trees in order to provide access to on-site parking. Given the nature of the park use, this should be avoided.

# ii. The reduction in parking is for the amount Applicant is physically unable to provide and is proportionate to the reduction in parking demand.

As outlined above, the configuration of the Property, which lacks curb cuts, is surrounded by thick vegetation and heritage trees, and has a substantial change in elevation, means the Applicant is physically unable to provide three parking spaces at the Property. Further, the Project's parking demand is greatly reduced as a result of the nature of the park use and the abundant access to public transportation options. Accordingly, the Applicant meets the requirements of Subtitle C § 703.3.

#### iii. The Applicant Will Contact DDOT to Discuss a Transportation Demand Management Plan

As required by Subtitle C § 703.4, the Applicant will contact the District Department of Transportation to discuss the parameters of a transportation demand management plan for the Property.

#### VI. <u>COMMUNITY OUTREACH</u>

Pursuant to Advisory Neighborhood Commission (ANC) 3F's procedures and guidelines, the Applicant will contact ANC 1A shortly after the application is filed. The Applicant will present to ANC 3F at the next available public meeting.

#### VI. <u>CONCLUSION</u>

For the reasons stated above, the Project meets the applicable standards for special exception relief under the Zoning Regulations. Accordingly, the Applicant respectfully requests the Board grant the application.

Respectfully Submitted,

COZEN O'CONNOR

Samantha Mazo Eric J. DeBear 1200 19<sup>th</sup> Street NW Washington, DC 20036

# Tab A



# Tab B

	APPLICABLE	CODES:	ZONING NOTES:		ZONING NOTE
	Building:	12 DCMR A, Building Code Supplement, International Building Code – 2012 Edition (IBC)	Zoning has been review Zoning Determination le	ved by Matthew Le Grant, DCRA Zoning Administrator in etter dated 1-29-2018	GAR:
	Electrical:	12 DCMR C, Electrical Code Supplement, National Electric Code (NFPA 70) – 2011 Edition	Project Name:	Hearst Park and Pool	Vehicle Parking:
	Mechanical:	12 DCMR E, Mechanical Code Supplement, International Mechanical Code – 2012 Edition.	Project Address:	3950 37th Street, NW Washington, DC 20008	-
	Plumbing:	12 DCMR F, Plumbing Code Supplement, International Plumbing Code – 2012 Edition.	Square: Lot:	1905 802	
	Fire Prevention:	12 DCMR H, Fire Code Supplement, International Fire	Zoning Classification:	оо2 R-1-В	
	Accessibility	Code – 2012 Edition (IFC) 2010 Americans with Disabilities Act Standards for	Lot Area:	191,688 Square Feet (4.4 Acres)	
	Accessibility:	Accessible Design (ADA); ICC A117.1, Accessible and Usable Buildings and Facilities – 2009 Edition	Flood Zone:	FEMA Flood Zone Map Area 1100010004C Zone X - Minimal Flood Hazard	
	Other:	National Fire Protection Association (NFPA) standards, as referenced by the 2012 IBC, including NFPA 10, NFPA 13, NFPA 72, etc.	Existing Use:	Department of Parks and Recreation Park bounded by 3J1h St to the west, Quebec St. to the south, Idaho Ave to the south east, Idaho Ave. District Department of Transportation (DDOT) right-of-way and	
		12 DCMR D, Fuel Gas Code Supplement, International Fuel Gas Code – 2012 Edition		Hearst DCPS Elementary School to the north. The site is an open, partially wooded field with a natural grass	
		12 DCMR I, Energy Code Supplement, International Energy Conservation Code – 2012 Edition		soccer field and 3 tennis courts, located in the southwest corner.	
		12 DCMR K, Green Construction Code Supplement, International Green Construction Code – 2012 Edition	Proposed Use:	Open, partially wooded field with, natural grass soccer field in the northern portion of the site, outdoor pool and pool house, pool staff office, storage and pool equipment and storage rooms) and 2 tennis courts. No	
		12 DCMR L, Swimming Pool and Spa Code Supplement, International Swimming Pool and Spa Code – 2012 Edition		on-site parking is planned.	Bicycle Parking:
		DC Law 8-36 District of Columbia Environmental Policy Act of 1989	FAR:	Section C-1604.2: Public education buildings and structures, public recreation and community centers, and public libraries shall be permitted a maximum floor	
		DCMR Title 11- Zoning Requirements		area ratio as set forth in table Table C § Section 1604.2: 0.9 Max FAR (172,519 SF allowed). The proposed building is a two-story structure with a total of 5,749 sq.ft	
	PROJECT S			FAR will be based on the Use Category of Parks and	Deliver Space:
	The Departmer Recreation proj Hearst Park cu	t of General Services and Department of Parks & ect involves improvements to the existing park. rrently serves Ward 3 as a multi-purpose public open		Recreation for the site as defined under Section B, 200.2 (2). Building area = 5,749 gsf which is below the maximum permitted gross floor area and complies with the FAR requirement for the R-1-B Zoning District.	
	improvements/	for passive and active recreation. Park upgrades are to include a new outdoor pool with pool house for Hearst Park. The intent of the design	Allowable Height:	Section C-1602.2: A public recreation and community	Retaining Walls:
	is to maintain th	he passive character of the park, while providing ties for structured/ organized sports including soccer		center may be erected to a height as follows: In an R, RF, or RA Zoning District, a public recreation and community center may be erected to a height not to exceed forty-five feet (45 ft.)	
		d grass restoration at disturbed areas		In accordance with Section B-307.1, the height of the project will be measured from the curb, projected from	
	3. Site utilities	d drainage installation at sports field and storm water piping aving and stairs		the center of the front property line along 37th St. NW, to the top of the main parapet. The Project height at	
	<ol> <li>5. Permeable</li> <li>6. Raised wood</li> <li>7. Fencing</li> </ol>	paving oden walkways, landings and platforms		this Building Height Measuring Point is 16 '-6 ". The proposed Project complies with the height requirement for the R-1-B zone.	
	8. Site access	sories	Number of Stories:	In accordance to Section D-303.1, the building is	
		emoval of existing site features f existing plantings and trees		limited to three stories. The proposed (2) story project complies with the R-1-B zoning height restrictions	
<ol> <li>Removal of existing storm water infrastructure</li> <li>Pool House</li> </ol>		Lot Width:	In accordance to Section C-1605, no lot width is		
	1. Construction unit wall, construction	on of a new steel frame, bearing concrete masonry oncrete deck and steel deck structure clad in metal		prescribed for public recreation and community center uses.	
	2. Membrane	aluminum siding. roofing, extensive and intensive green roofs. quipment, office, lobby and locker/bathing/toilet	Yard Designations:	Front Yard Section B-315.3, If a lot has more than one (1) street lot line, the owner of the lot may choose the	
	facilities. 4. Sheeting a	nd shoring		street lot line that shall determine the application of any front setback requirement.	
	6. Fencing 7. Mechanica	nforcement under footings I, plumbing and electrical systems		The front yard setback is to be considered along 37th Street NW.	
	<ol> <li>Sump syste</li> <li>Generator</li> <li>Machineroo</li> <li>Exterior ele</li> </ol>	omless passenger elevator		The side yards are the Hearst Elementary School to the north and Quebec St. NW and Idaho Ave. NW to the south. Side yard setback = 8' minimum. Page 16 of Appendix 'A 'illustrates a 12' side yard setback at	
	Tennis Courts 1. New tennis 2. Fencing	court and practice area.		Quebec St. NW. The rear yard is the DDOT Idaho Ave. Right-of-Way to the east. The soccer field may extend into the rear	
	Swimming Poo 1. In ground s	l & Deck .ix-lane pool with zero-entry area		yard.	
	<ol> <li>Chair lift.</li> <li>Pool equips</li> </ol>				
	PROJECT AREA	2.774 #			
	1st Floor 2nd Floor	3,774 sq.ft. 1,048 sq.ft.			
	Total Conditioned Attached Exterior	· · · ·			
	Total Building	5,749 sq.ft.			
	Building Footprint	, including cantilever 5,028 sq.ft.			
	Pool Deep End	514 sq.ft.			
	Shallow End	3,370 sq.ft.			
	Subtotal	3,884 sq.ft.			

1

0

2

0

TES (Continued):

3

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The project is exempt from Green Area Ratio because it is located within the R-1-B Zoning District (Section B-601.2).

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Section C-701.5: Parks and Recreation -0.5 spaces per 1,000 SF. Parking will be required for the proposed structure. Two (2) off-street parking spaces are required.

Section C-703: Special exceptions from minimum parking number requirements: Section C-703.1 -This section provides flexibility from the minimum required number of parking spaces when the provision of the required number of spaces would be contrary to other District of Columbia regulations; or impractical or unnecessary due to the shape or configuration of the site, a lack of demand for parking, or proximity to transit.

Approval of a special exception by the Board of Zoning Adjustment will be required pursuant to Section C-703.2

FAR will be based on the Use Category of Parks and Recreation for the site as defined under Section B, 200.2 (2). Building area = 5,208 gsf which is below the maximum permitted gross floor area and complies with the FAR requirement for the R-1-B Zoning District.

Approval of a special exception by the Board of Zoning Adjustment will be required pursuant to Section C-703.2

Section C-802.1: Parks and Recreation Use Long Term Bicycle Parking: None required Short Term Bicycle Parking: 1 space for each 10,000 SF but not less than 6 spaces

Six (6) short-term bicycle spaces are required, and will be provided (14) are to be provided in excess of base requirements by Section C, 804.

Section C-901.1: Parks and Recreation- More than 30,000 SF GFA, 1 required. The building area is less than 30,000 GF A, therefore a delivery space is not required.

The western and southern edges of the site will require retaining walls. The retaining walls will extend above grade at the western and southern edges of the site by no more than 4'.

Section C-1401.3: A retaining wall shall not exceed four feet (4 ft.) in height in the following locations, unless a lower height is required by Section C-1401.5 and 1401.6:

(a) Along a street frontage or property line;

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(b) Within any required side setback;
(c) In the R-1-A, R-1-B, R-6, R-7, R-8, R-9, R-11, R-12, R-14, R-15, R-16, R- 19, and R-21 zones, within twenty-five feet (25 ft.) of the rear property line, as measured from the rear property line inward; and
(d) In the R-2, R-3, R-10, R-13, R-17, R-20, and RF zones, within twenty feet (20 ft.) of the rear property line, as measured from the rear property line inward.

#### **BUILDING ANALYSIS:**

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Use Classification: The IBC requires the occupancy of each space to be individually classified. The mixed uses in the Pool House will include office and lobby space, locker rooms, and associated storage and support spaces. Per IBC §303.1.1, a building or tenant space used for assembly purposes with an occupant load of less than 50 persons is classified as a Group B occupancy. An occupant load calculation was performed for the building and it was determined that the Pool House, which serves an assembly function (pool) has a current occupant load of 49 persons. Therefore, the occupancy classifications for the uses in accordance with the IBC include Group B and Group S-1 occupancies.

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The building is a non-separated occupancy per IBC §508.3. This approach does not require fire separations between occupancies, and the requirements for fire protection systems are based on the most restrictive occupancy [IBC §508.3].

Building Height: Based on a Group S-1 occupancy, the most restrictive occupancy in the building for height and area limitations, and Type IIB constriction, the allowable building height is 3 stories and 55 feet and the allowable area is 17,500 square feet

Construction Type: The required fire resistance ratings of the walls, structural elements, floors, ceilings and roofs are based on the construction type of the building as specified in IBC Table 601. Table 6 summarizes the fire resistance requirements of structural elements for Type IIB building construction. The use of combustible materials is required to comply with IBC §603.

Table 6 – Fire-Resistance Ratings for Building Elements [IBC Table 601]

BUILDING ELEMENT	HOURS
Primary Structural Frame	0
Interior and Exterior Load-bearing walls	0
Exterior Non-load-bearing walls	See folllowing
Interior Non-loadbearing walls	0
Floor construction and secondary members	0
Roof construction and secondary members	0

TABLE 602 - Fire-resistance rating requirements for exteriorwalls based on fire separation distanceFire Separation Distance XGroup S-1 & Type IIBX < 5'2 HOUR5' < X < 10'10' < X < 30'X > 30'0 HOUR

#### BUILDINGS (Continued):

Interior Finishes: Interior wall and ceiling finishes and trim are classified in accordance with ASTM E 84, Standard Test Method for Surface Burning Characteristics of Building Materials. Interior finish materials are grouped in the following classes, based on their flame spread and smoke developed indexes [IBC §803.1]: Class A – Flame spread index 0-25, smoke developed index 0-450 Class B – Flame spread index 26-75, smoke developed index 0-450 Class C – Flame spread index 76-200, smoke developed index 0-450

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Table 8 summarizes the interior finish requirements for the building depending [IBC Table 803.9].

OCCUPANCY	EXITS	CORRIDORS	OPEN AREA
Group B (not sprink'd)	Class A	Class B	Class C
Group S (not sprink'd)	Class B	Class B	Class C

In addition to interior wall and ceiling finishes, requirements are also specified for interior floor finish and floor covering materials. Interior floor finish materials are classified in accordance with NFPA 253, Standard Method of Test for Critical Radiant Flux for Floor Covering Systems Using a Radiant Heat Energy Source as follows [IBC §804.2]: Class I – Critical radiant heat flux ≥ 0.45 W/cm2 Class II – Critical radiant heat flux ≥ 0.22 W/cm2

Floor finish must be a minimum of Class II or must comply with the DOC FF-1 "pill test" (CPSC 16 CFR Part 1630) or ASTM D 2859 in all occupancies [IBC §804.4.1].

Traditional type floors and floor coverings such as wood, vinyl, linoleum, or terrazzo, and resilient floor covering materials that are not comprised of fibers are permitted [IBC §804.1].

Automated Sprinklers System: The Pool House building is not required to be equipped with an automatic sprinkler system per IBC §903.

Standpipe & Hose: The Pool House building is not required to be equipped with a standpipe and hose system per IBC §904 as the floor level of the highest story does not exceed 30 feet above the lowest level of fire department access.

Fire extinguishers: Fire extinguishers are required for Group B and Group S occupancies [12 DCMR A §906.1]. - At generator - At chemical storage

Fire Alarm & Detection: The Pool House building is not required to be equipped with a fire alarm system per IBC §907.

Automated External Defibrillator: Per DC Reg 44–232.01, DC Recreational Facilities are required to have a minimum of (1) automated external defibrillator

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#### OCCUPANT LOAD FACTORS:

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The required number and capacity of exits are based on the design occupant load. The occupant load represents the maximum number of persons anticipated to occupy any floor area, and is used to determine the minimum number of persons for which means of egress must be provided. Table 10.1 summarizes the applicable occupant load factors for the project based on the anticipated uses.

USE	OCCUPANT LOAD FACTOR (sf / Person)
Locker rooms	50 Gross
Business (office areas)	100 Gross
Storage / mechanical equipment areas	300 Gross
Pool Deck	15 Gross
Swimming Pool	50 Gross

Posted bather load as indicated on pool deck signage is calculated by ISPSC occupant loads as defined by table 403.1 Maximum Bather Load. Pool's allowable occupancy to be capped at the maximum bather load.

Pool Class: B PUBLIC POOL. A pool intended for public recreational use.

Excerpt from Table 403.1 for Pool Decks with Deck ares at least equal to water surface area (but less than twice the water surface area).

USE	OCCUPANT LOAD FACTOR (sf / Person)
Shallow Instructional / Wading Pools	12 sf / user
Deep Area (Not including Diving)	15 sf / user
Diving Area (Per each Diving Board	Not applicable to project

#### PROJECT Hearst Park & Pool 3950 37th Street, NW Washington, DC 20008

### OWNER'S REPRESENTATIVE

**Department of General Services** 2000 14th Street NW, 8th Floor Washington DC, 20009

#### ARCHITECT

**cox graae + spack architects** 2909 M Street NW Washington DC 20007 T: 202.965.7070 F: 202.965.7144



#### **CIVIL ENGINEER**

Wiles Mensch Corporation Adress: 510 8th Street SE Washington DC 20003 T: 202.436.9384

#### STRUCTURAL ENGINEER

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#### MPE ENGINEER

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#### LANDSCAPE ARCHITECT

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#### POOL CONSULTANT

**Counsilman-Hunsaker** 10733 Sunset Office Dr., Suite 400 St. Louis, MO 63127 T: 314.894.1245

#### AV/ IT/ ACOUSTICS CONSULTANT

Polysonics 405 Belle Air Lane Warrenton, VA 20186 T: 540.341.4988

T: 540.34	1.4988	ALLAN L. SPACE
Mark	Date	Description
01	6/11/18	Design Development Se
02	11/20/18	FTG Permit Submissior

01	6/11/18	Design Development Set
02	11/20/18	FTG Permit Submission
03	02/06/19	Permit Submission
04	03/20/19	Building Permit


Drawing Title: ZONING AND CODE INFORMATION

Graphic Scale:

Project No: 1614

Date: 03/20/2019 Drawing No: **G002** 



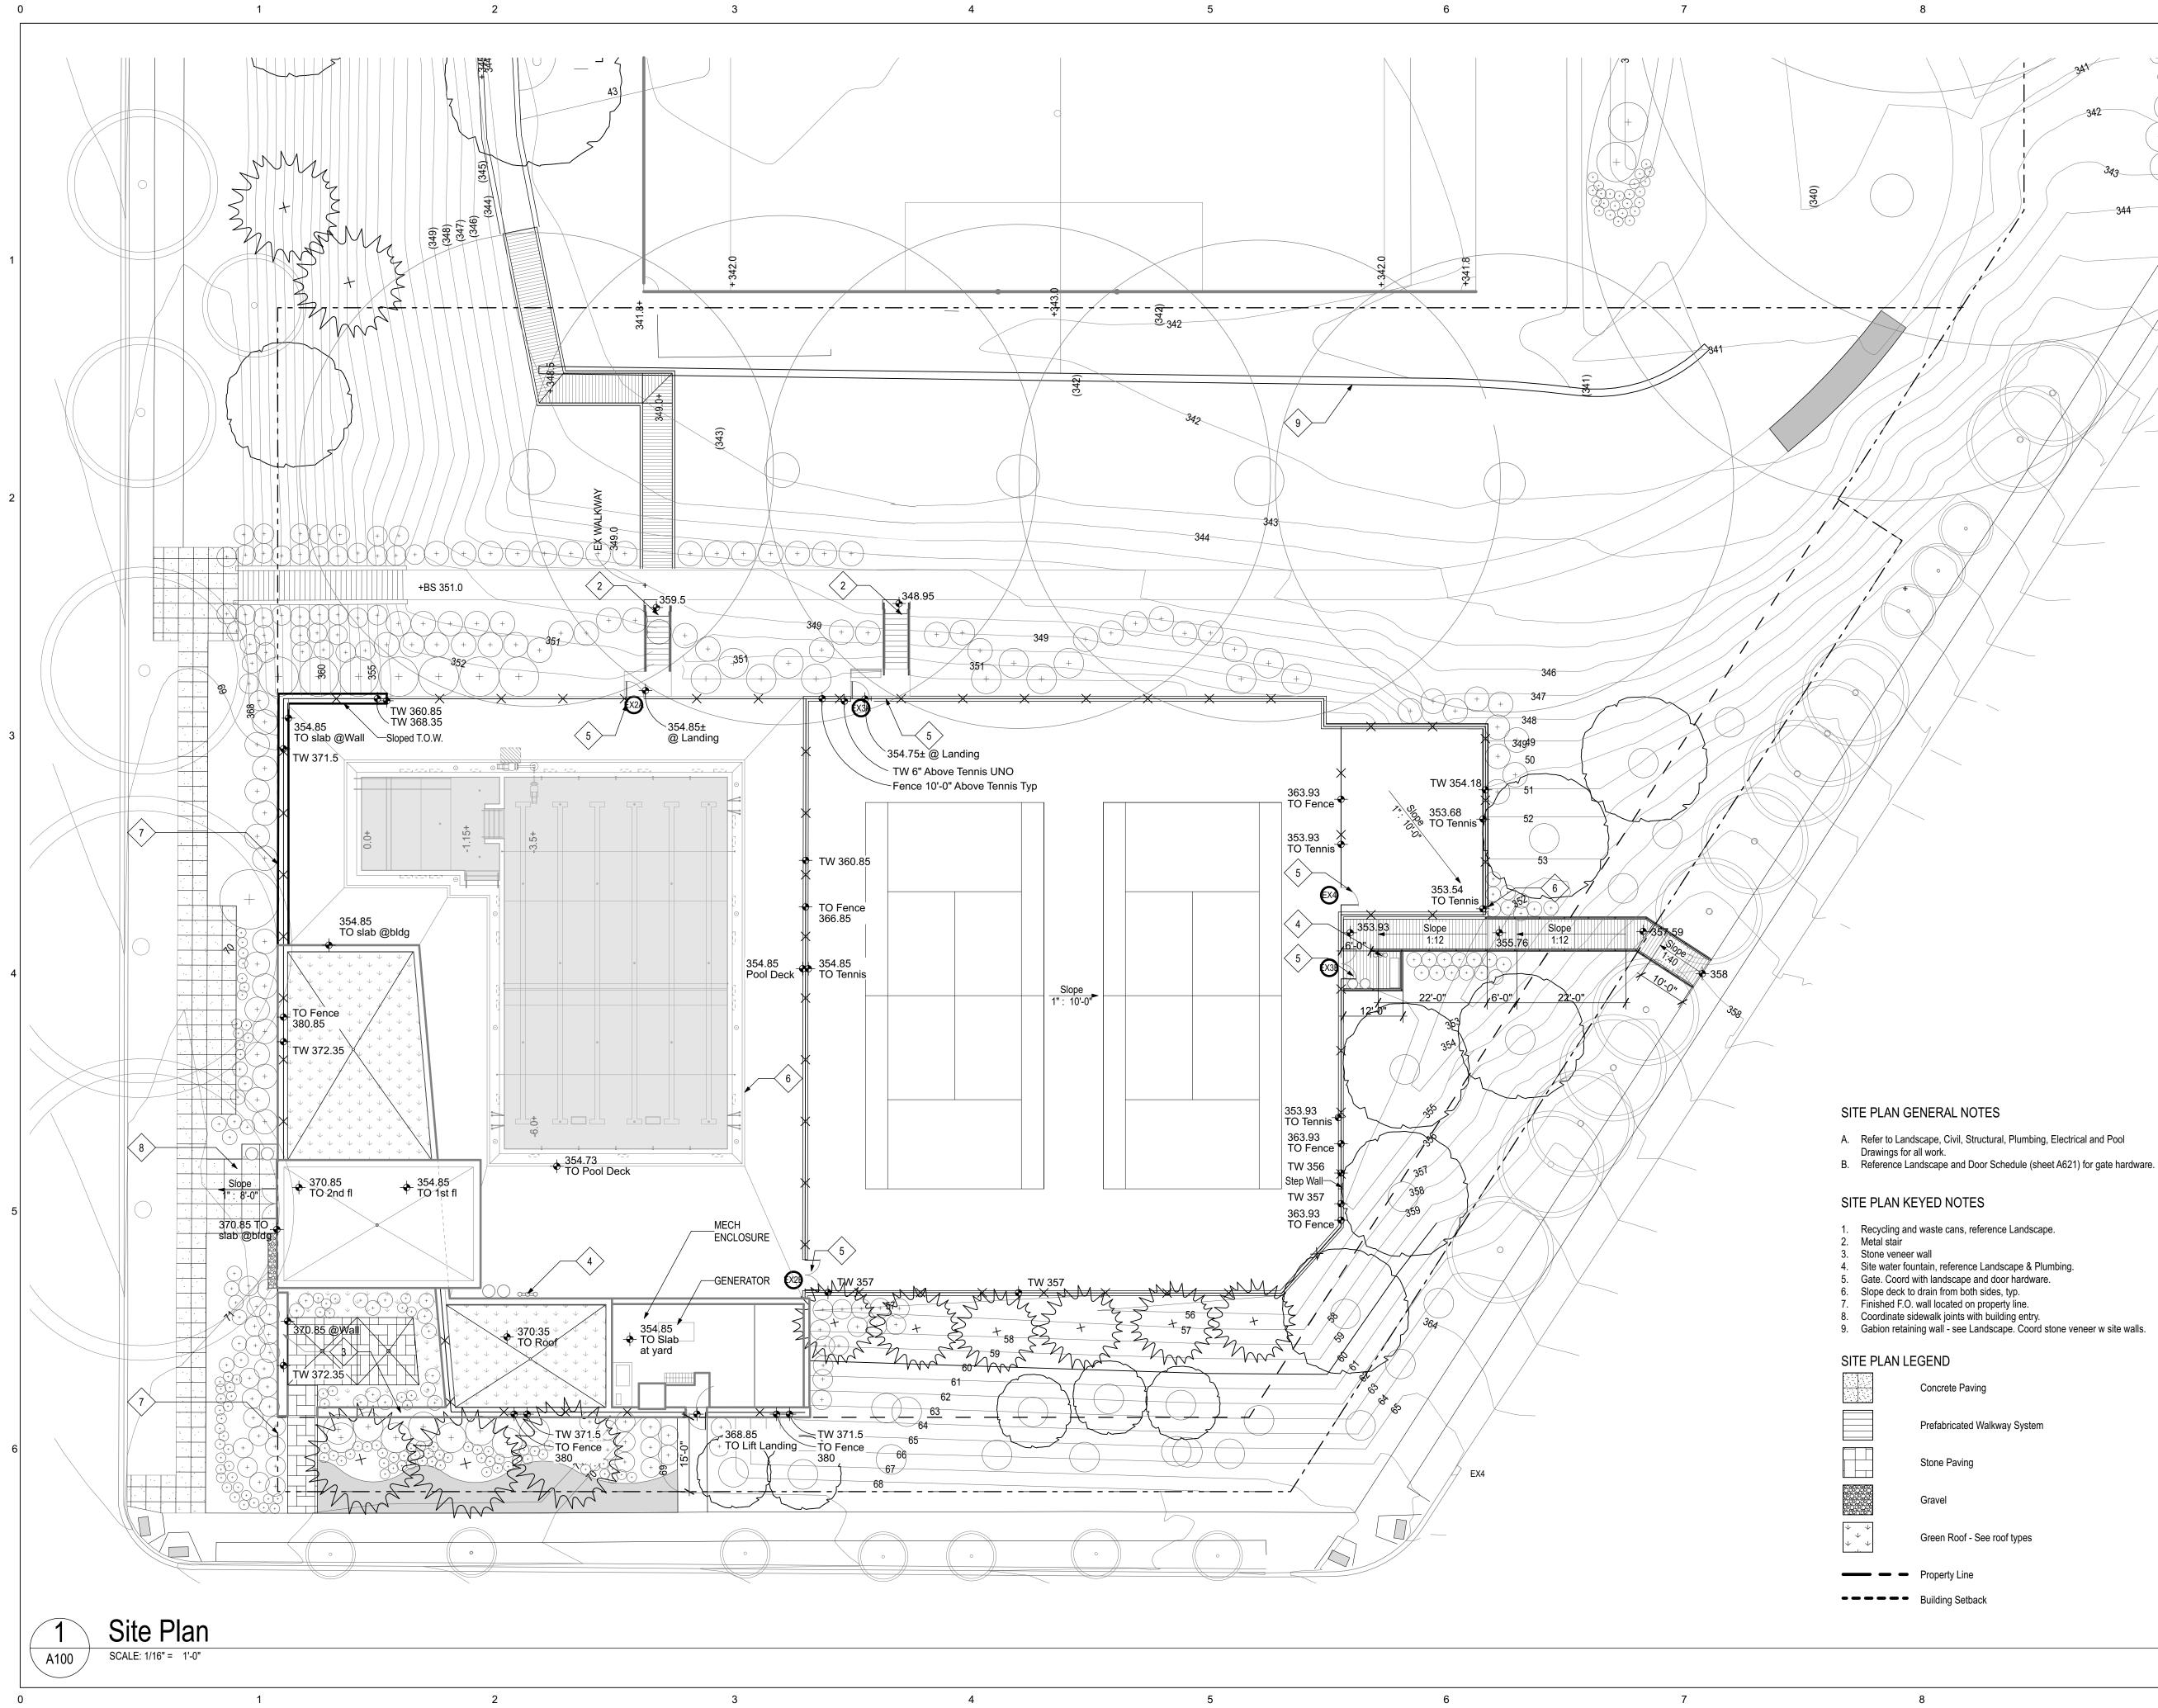



	Concrete Paving
	Prefabricated W
	Stone Paving
	Gravel
$\begin{array}{c} \downarrow  \downarrow \\ \downarrow  \downarrow \\ \downarrow  \downarrow \end{array}$	Green Roof - Se
	Property Line
	Building Setbac

#### PROJECT Hearst Park & Pool 3950 37th Street, NW Washington, DC 20008

Washington DC, 20009

#### OWNER'S REPRESENTATIVE Department of General Services 2000 14th Street NW, 8th Floor

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#### LANDSCAPE ARCHITECT

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#### POOL CONSULTANT Counsilman-Hunsaker

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#### AV/ IT/ ACOUSTICS CONSULTANT

Polysonics 405 Belle Air Lane Warrenton, VA 20186 T: 540.341.4988



Mark	Date	Description
01	6/11/18	Design Development Set
02	11/20/18	FTG Permit Submission
03	02/06/19	Permit Submission
04	02/20/19	<b>Pool Gutter Revision</b>

Drawing Title: ARCHITECTURAL SITE PLAN

#### Graphic Scale:


Project No:

1614

Date: 02/06/2019 Drawing No:

A100



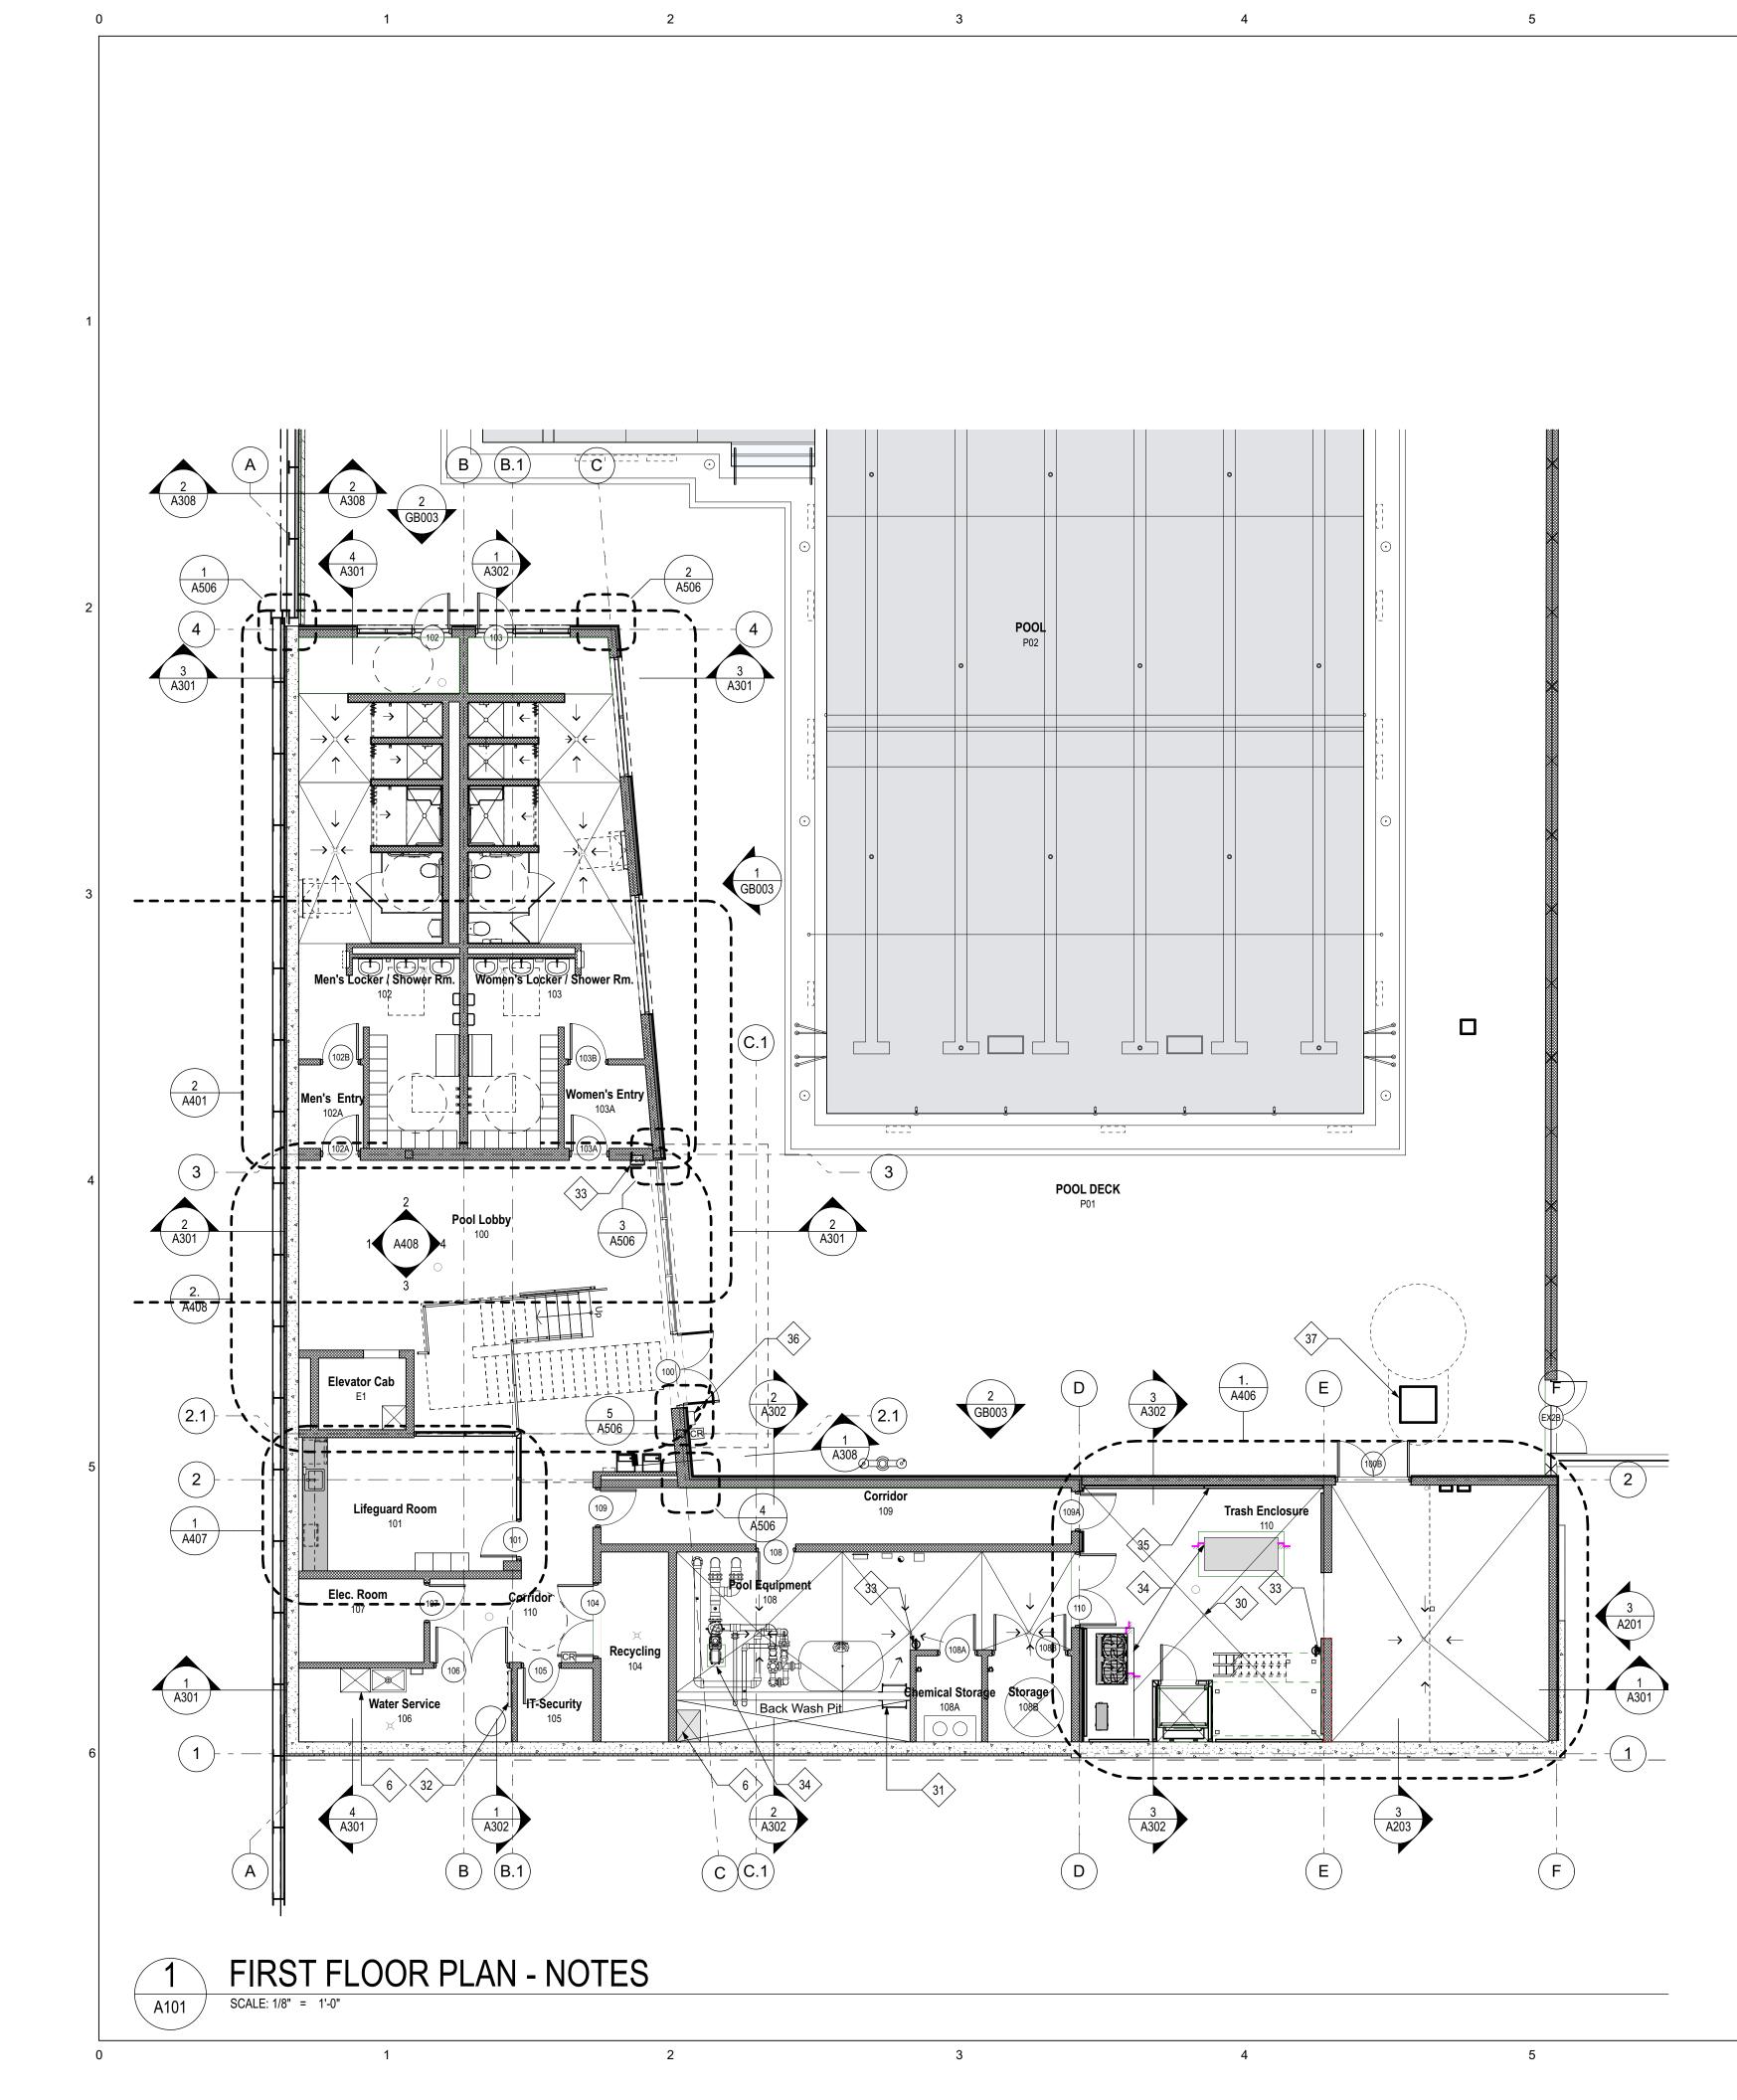

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# FLOOR PLAN LEGEND

	Keynote Tag
A1	Partition Type Symb
, ,	Align Symbol

#### FLOOR PLAN GENERAL NOTES

- A. SEE A601 FOR PARTITION TYPES.
- B. DIMENSIONS ARE AS FOLLOWS U.N.O. COORDINATE ALL W WALL SECTIONS
   • TO FINISHED FACE OF MASONRY WALL
- TO FACE OF SHEATHING
- INTERIOR TO FINISHED FACE OF WALL C. SEE 622 FOR WINDOW TYPES.
- D. PROVIDE FIRE STOPPING & DRAFT STOPPING AT ALL WALL,
- FLOOR, AND CEILING PENETRATIONS.E. ALL WOOD BLOCKING IS TO BE FIRE RETARDANT. PROVIDE WOOD BLOCKING FOR ALL WALL MOUNTED ITEMS IN GWB
- PARTITIONS. F. ALL HDPE TOILET PARTITIONS TO MEET NFPA AND ASTM 85
- MINIMUM REQUIREMENTS FOR FIRE AND SMOKE SPREAD.

#### FLOOR PLAN / ROOF KEYED NOTES

#### 1. PLAM BASE AND WALL CABINETS.

- 2. LINE OF OVERHANG ABOVE.
- 3. SHEETING AND SHORING, REFER STRUCTURAL DRAWINGS.
- EXTERIOR RATED LIFT W/ ENCLOSURE BY LIFT MFR.
   ALTERNATING TREAD STAIR, GALV., PTD.
- ALTERNATING TREAD STAIR, GALV.,
   SUMP PUMP PIT SEE PLUBMING.
- STEEL PAN STAIR WITH 21 X 12 HSS STRINGERS, BAR STOCK RAILING W PERFORATED METAL PANELS.
- 8. GRAVEL BORDER.
- 9. BENCHES.
- 10. PROPERTY LINE.
- RECESSED WALK OFF GRILLE
   WALK OFF MAT.
- 12. WALK OFF MAT.
   13. EXTENSIVE GREEN ROOF.
- EXTENSIVE GREEN ROOF.
   INTENSIVE GREEN ROOF; LAWN AND PLANTINGS, REF: LANDSCAPE.
- METAL COPING.
   ST-1 CAP AND ST-1 VENEER AT SITE OR PARAPET WALL. SEE WALL SECTIONS.
- 17. FENCING, REFER LANDSCAPE.
- 18. GREENWALL, REFER LANDSCAPE.
- SCUPPER.
   PLAM RECEPTION DESK WITH SOLID SURFACE COUNTER AND TRANSACTION LEDGE.
- 21. CONCRETE WALKWAY, REFER LANDSCAPE. 22. BIKE RACKS, REFERENCE LANDSCAPE.
- 22. BIKE RACKS, REFERENCE LANDSCAPE.
   23. SHEETING AND SHORING FOR RETAINING WALL WITH METAL
- PANEL FACING AND PRECAST CONCRETE CAP. 24. ROOF DRAIN.
- 25. WHITE PVC ROOFING.
- 26. SUNSHADE.
- 27. 1/2" ALUMINUM LETTERING ON SUPPORTS.
- 28. GRAVEL BORDER.
   29. CANOPY.
- 30. DRAIN.
- 31. FRP LADDER
- 32. MOP RACK SEE BATH ACCESSORIES & TYP MOUNTING HTS
- 33. FEC OR WALL MTD FIRE EXTINGUISHER. SEE PLANS
- 34. HOUSEKEEPING PAD SEE MEP & STRUCT DWGS35. WALL MTD METAL ACOUSTIC PANELS SEE ELEV FOR MTG HT
- 36. DOOR ACTUATOR.
- 37. ACCESS HATCH FOR EJECTOR PUMP SEE PLUMB & POOL
- BOLLARD W ACTUATOR & CARD READER MTD.
   PREFINISHED CORRUGATED ALUMN ROOF.
- 40. PAVER STONES SET FLUSH W GREEN ROOF. SEE LANDSCAPE & ROOF TYPES.

#### PROJECT Hearst Park & Pool 3950 37th Street, NW Washington, DC 20008

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Mark	Date	Description
01	6/11/18	Design Development Set
02	11/20/18	FTG Permit Submission
03	02/06/19	Permit Submission
04	02/20/19	Pool Gutter Revision

Drawing Title: FIRST FLOOR PLAN

Graphic Scale: 1/8" = 1'-0"

0 4' 8'


Project No:

1614

Date: 02/06/2019 Drawing No:

A101



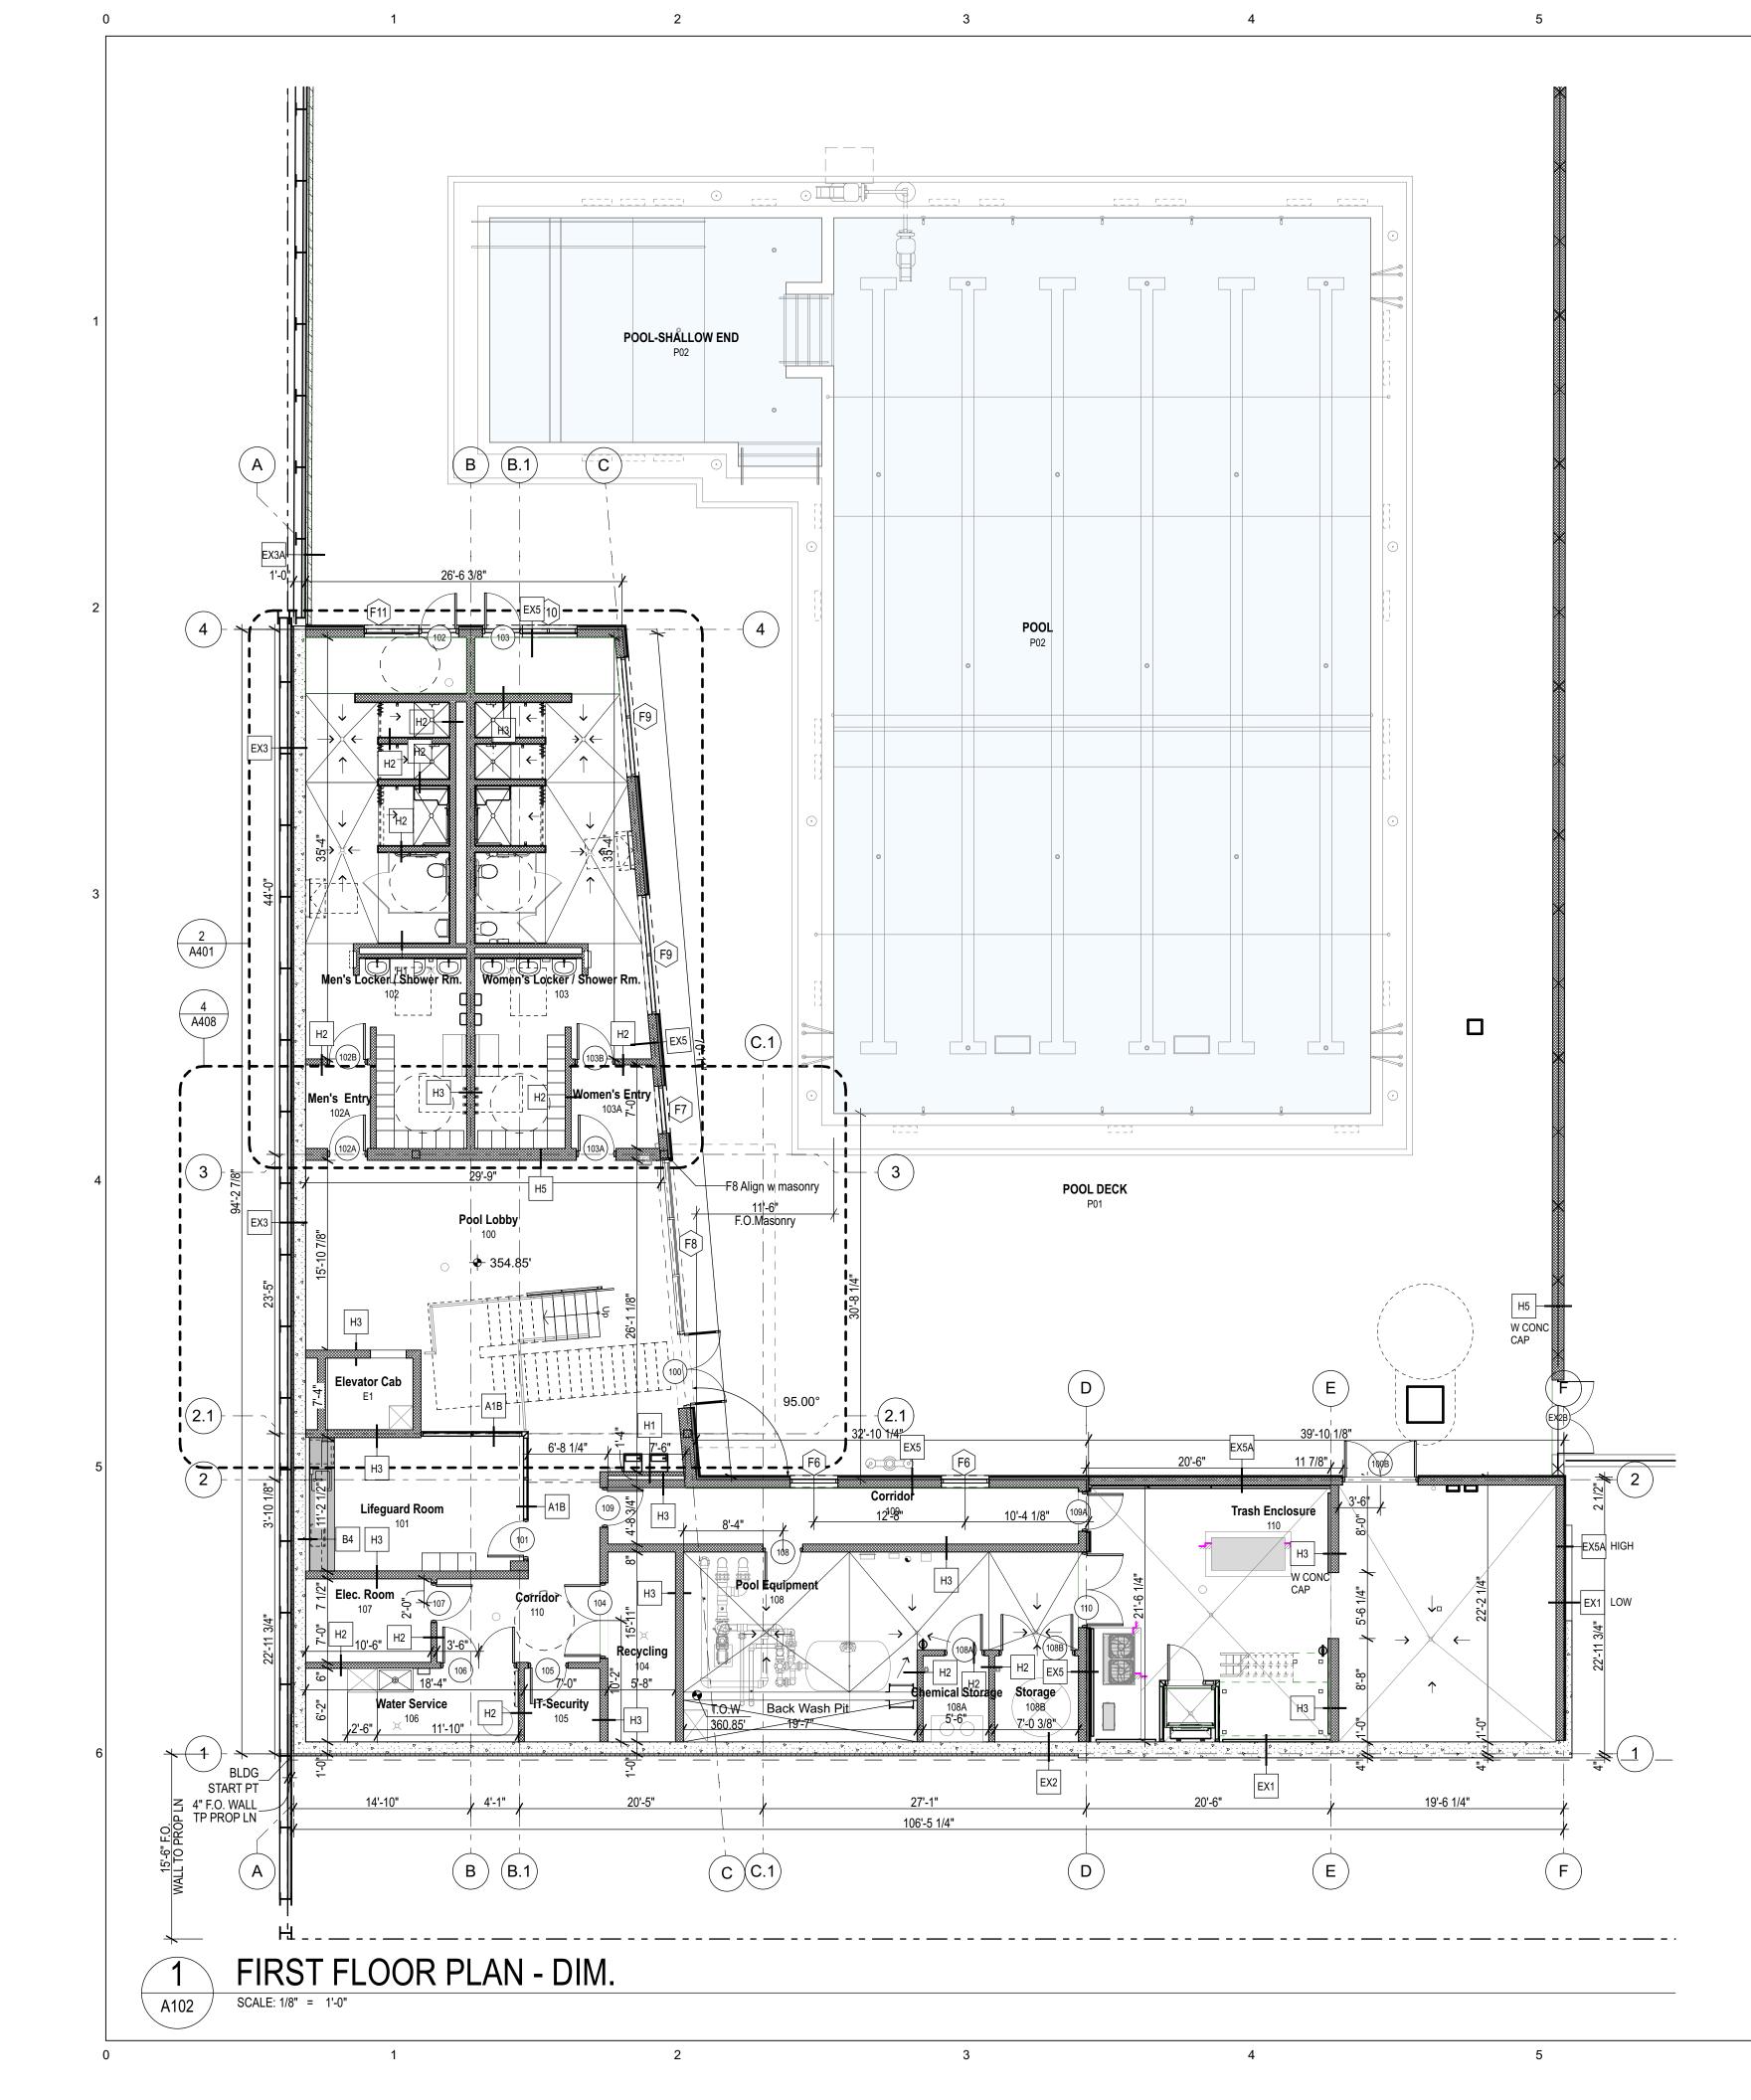

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# FLOOR PLAN LEGEND

	Keynote Tag
A1	Partition Type Symbo
ţ,	Align Symbol

#### FLOOR PLAN GENERAL NOTES

- A. SEE A601 FOR PARTITION TYPES.
- B. DIMENSIONS ARE AS FOLLOWS U.N.O. COORDINATE ALL W WALL SECTIONS
   • TO FINISHED FACE OF MASONRY WALL
- TO FACE OF SHEATHING • INTERIOR TO FINISHED FACE OF WALL
- INTERIOR TO FINISHED FACE OF V C. SEE 622 FOR WINDOW TYPES.
- D. PROVIDE FIRE STOPPING & DRAFT STOPPING AT ALL WALL,
- FLOOR, AND CEILING PENETRATIONS.E. ALL WOOD BLOCKING IS TO BE FIRE RETARDANT. PROVIDE WOOD BLOCKING FOR ALL WALL MOUNTED ITEMS IN GWB
- PARTITIONS. F. ALL HDPE TOILET PARTITIONS TO MEET NFPA AND ASTM 85
- MINIMUM REQUIREMENTS FOR FIRE AND SMOKE SPREAD.

PROJECT Hearst Park & Pool 3950 37th Street, NW Washington, DC 20008

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Mark	Date	Description
01	6/11/18	Design Development Set
02	11/20/18	FTG Permit Submission
03	02/06/19	Permit Submission
04	02/20/19	<b>Pool Gutter Revision</b>

Drawing Title: FIRST FLOOR DIMENSION PLAN

Graphic Scale: 1/8" = 1'-0"

Project No:

1614


Date: 02/06/2019 Drawing No:

A102



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# FLOOR PLAN LEGEND

	Keynote Tag
A1	Partition Type Symb
, ,	Align Symbol
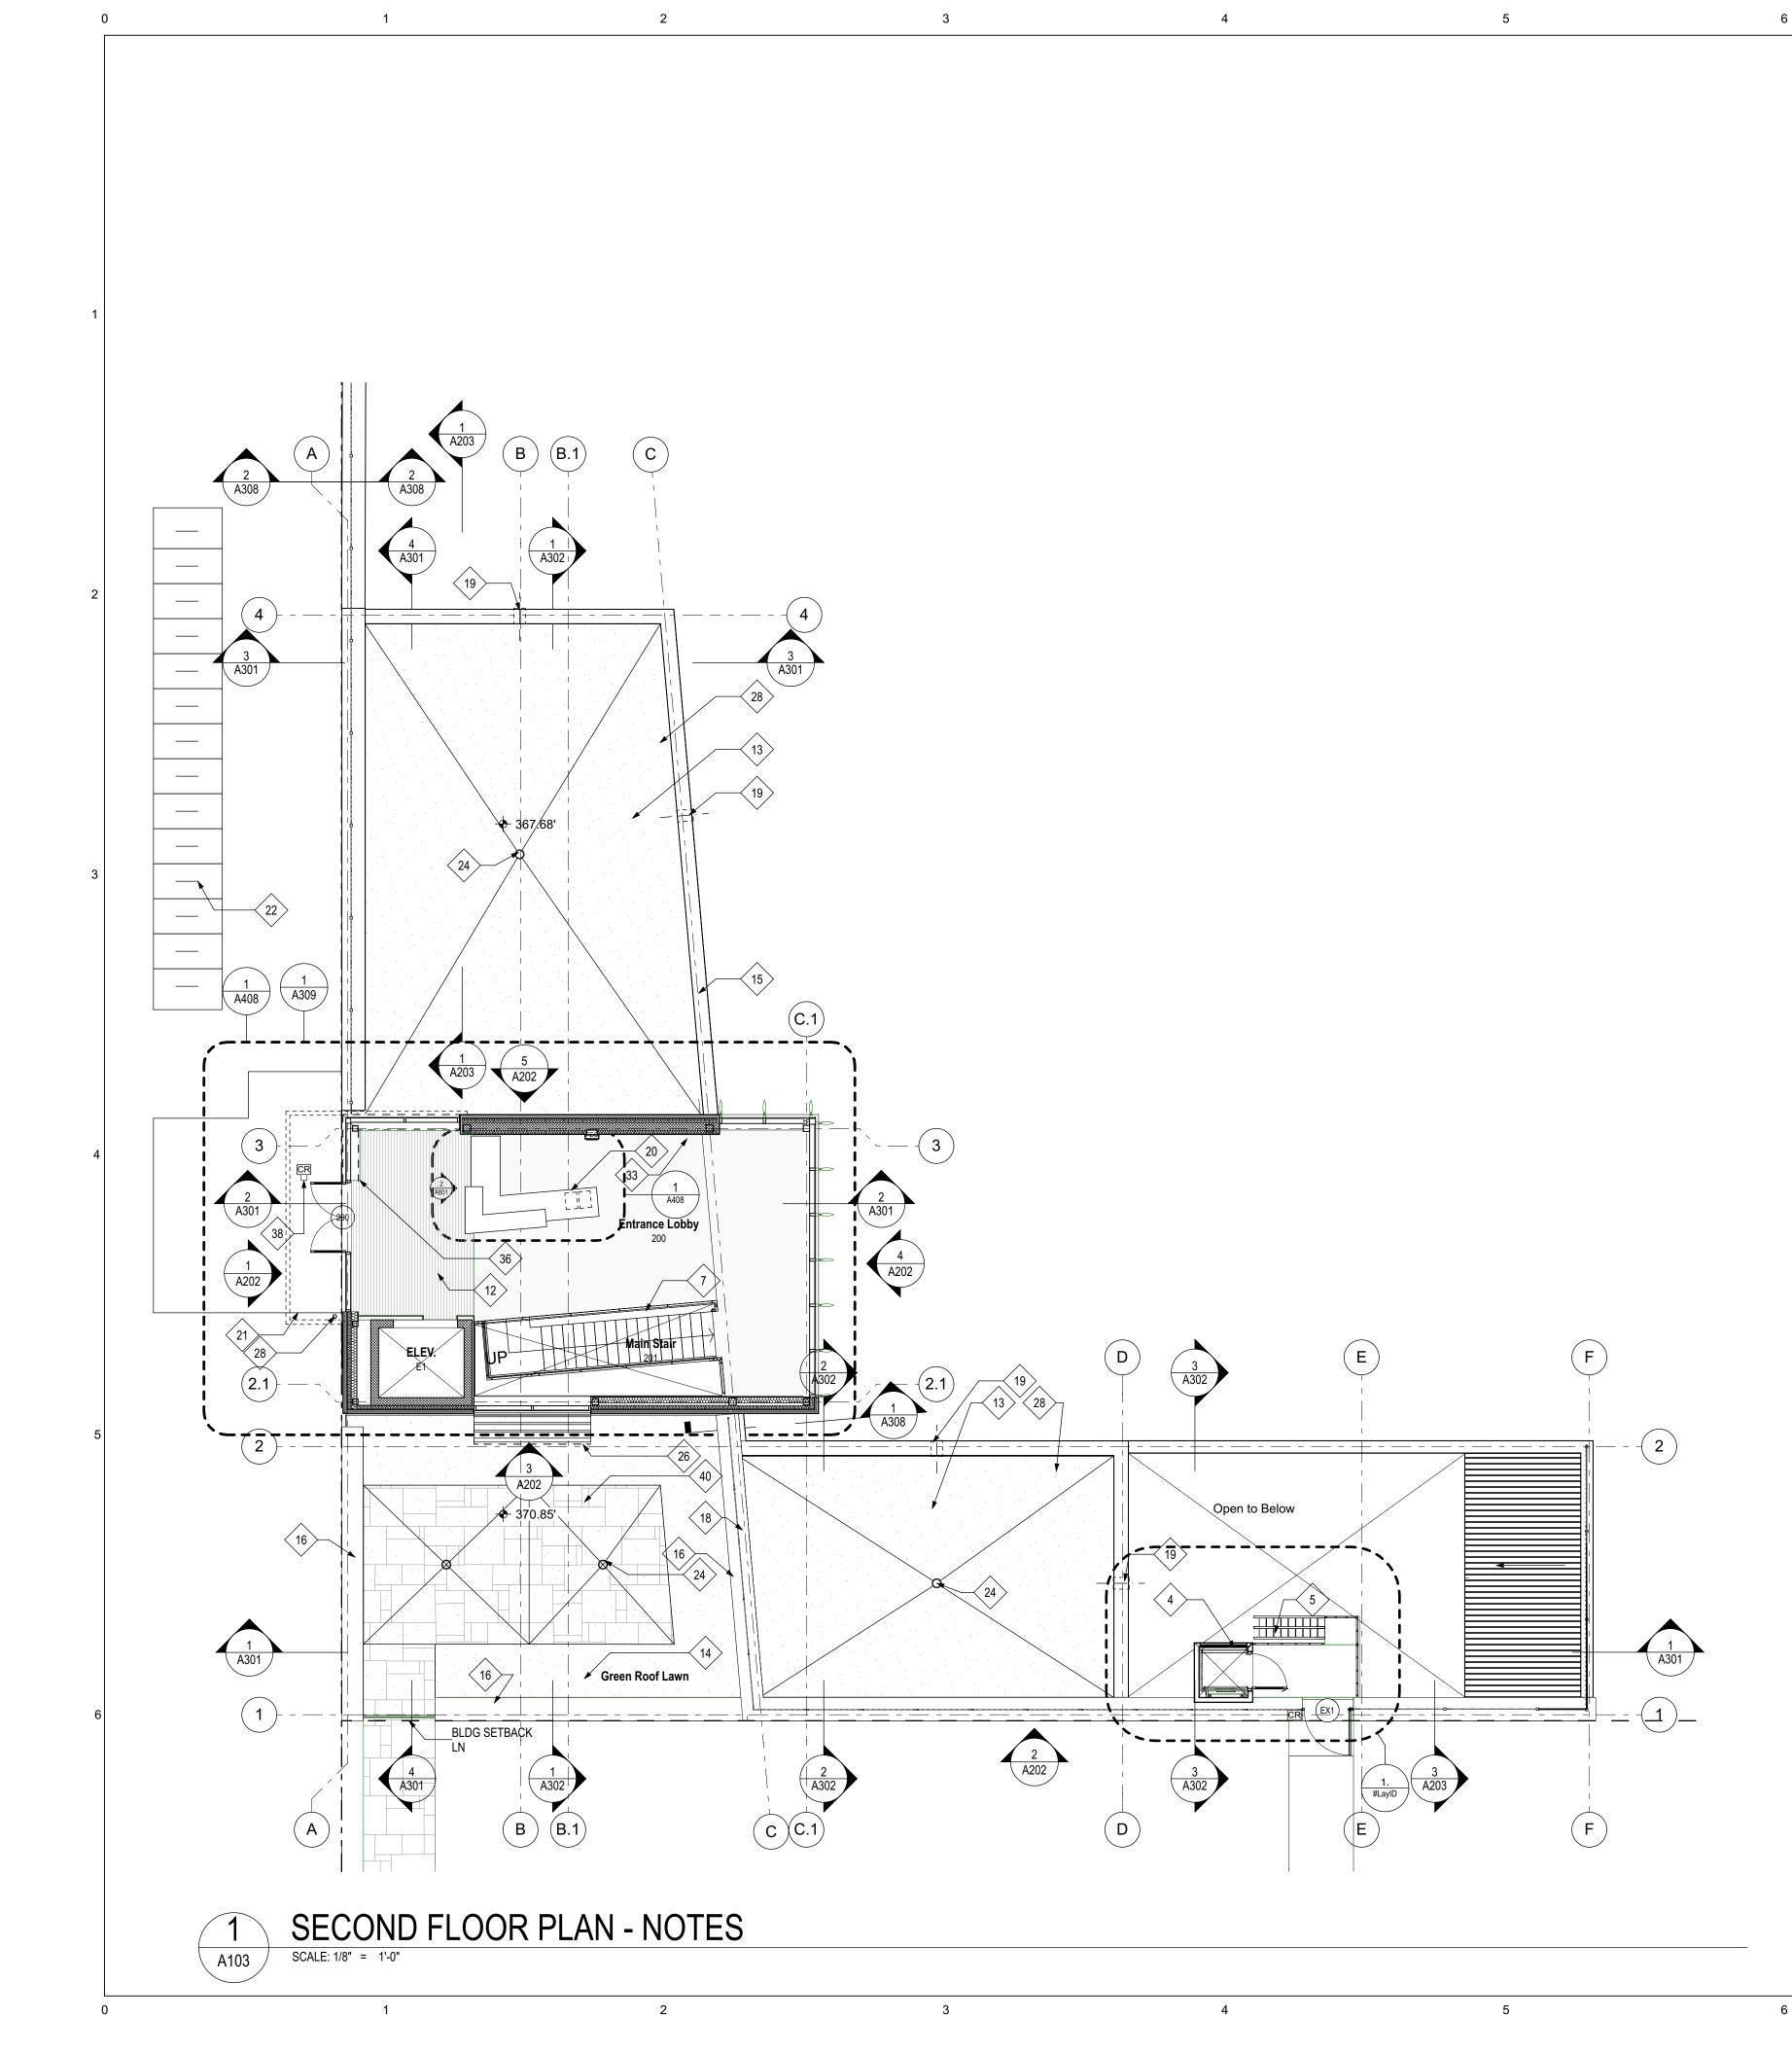
#### FLOOR PLAN GENERAL NOTES

- A. SEE A601 FOR PARTITION TYPES.
- B. DIMENSIONS ARE AS FOLLOWS U.N.O. COORDINATE ALL W WALL SECTIONS
   • TO FINISHED FACE OF MASONRY WALL
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#### FLOOR PLAN / ROOF KEYED NOTES

#### 1. PLAM BASE AND WALL CABINETS.

- 2. LINE OF OVERHANG ABOVE.
- 3. SHEETING AND SHORING, REFER STRUCTURAL DRAWINGS.
- 4. EXTERIOR RATED LIFT W/ ENCLOSURE BY LIFT MFR.
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   SUMP PUMP PIT SEE PLUBMING.
- SOME FOME FOLSE FLOOMING.
   STEEL PAN STAIR WITH 21 X 12 HSS STRINGERS, BAR STOCK RAILING W PERFORATED METAL PANELS.
- 8. GRAVEL BORDER.
- 9. BENCHES.
- 10. PROPERTY LINE.
- 11. RECESSED WALK OFF GRILLE
- WALK OFF MAT.
   EXTENSIVE GREEN ROOF.
- 14. INTENSIVE GREEN ROOF; LAWN AND PLANTINGS, REF: LANDSCAPE.
- 15. METAL COPING.
- 16. ST-1 CAP AND ST-1 VENEER AT SITE OR PARAPET WALL. SEE WALL SECTIONS.
- FENCING, REFER LANDSCAPE.
   GREENWALL, REFER LANDSCAPE.
- 18. GREENWAL 19. SCUPPER.
- PLAM RECEPTION DESK WITH SOLID SURFACE COUNTER AND TRANSACTION LEDGE.
- 21. CONCRETE WALKWAY, REFER LANDSCAPE.
- 22. BIKE RACKS, REFERENCE LANDSCAPE.
- SHEETING AND SHORING FOR RETAINING WALL WITH METAL PANEL FACING AND PRECAST CONCRETE CAP.
   ROOF DRAIN.
- 25. WHITE PVC ROOFING.
- 26. SUNSHADE.
- 27. 1/2" ALUMINUM LETTERING ON SUPPORTS.
- 28. GRAVEL BORDER.
   29. CANOPY.
- 29. CANOPY 30. DRAIN.
- 31. FRP LADDER
- 32. MOP RACK SEE BATH ACCESSORIES & TYP MOUNTING HTS
- 33. FEC OR WALL MTD FIRE EXTINGUISHER. SEE PLANS34. HOUSEKEEPING PAD SEE MEP & STRUCT DWGS
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   WALL MTD METAL ACOUSTIC PANELS SEE ELEV FOR MTG HT
   DOOR ACTUATOR.
- 37. ACCESS HATCH FOR EJECTOR PUMP SEE PLUMB & POOL
- 38. BOLLARD W ACTUATOR & CARD READER MTD.
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- 40. PAVER STONES SET FLUSH W GREEN ROOF. SEE LANDSCAPE & ROOF TYPES.

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Polysonics 405 Belle Air Lane Warrenton, VA 20186 T: 540.341.4988



Mark	Date	Description
01	6/11/18	Design Development Set
02	11/20/18	FTG Permit Submission
03	02/06/19	Permit Submission
04	02/20/19	Pool Gutter Revision

Drawing Title: SECOND FLOOR PLAN

Graphic Scale: 1/8" = 1'-0"

0 4' 8'


Project No:

1614

02/06/2019 Drawing No: **A103** 

Date:



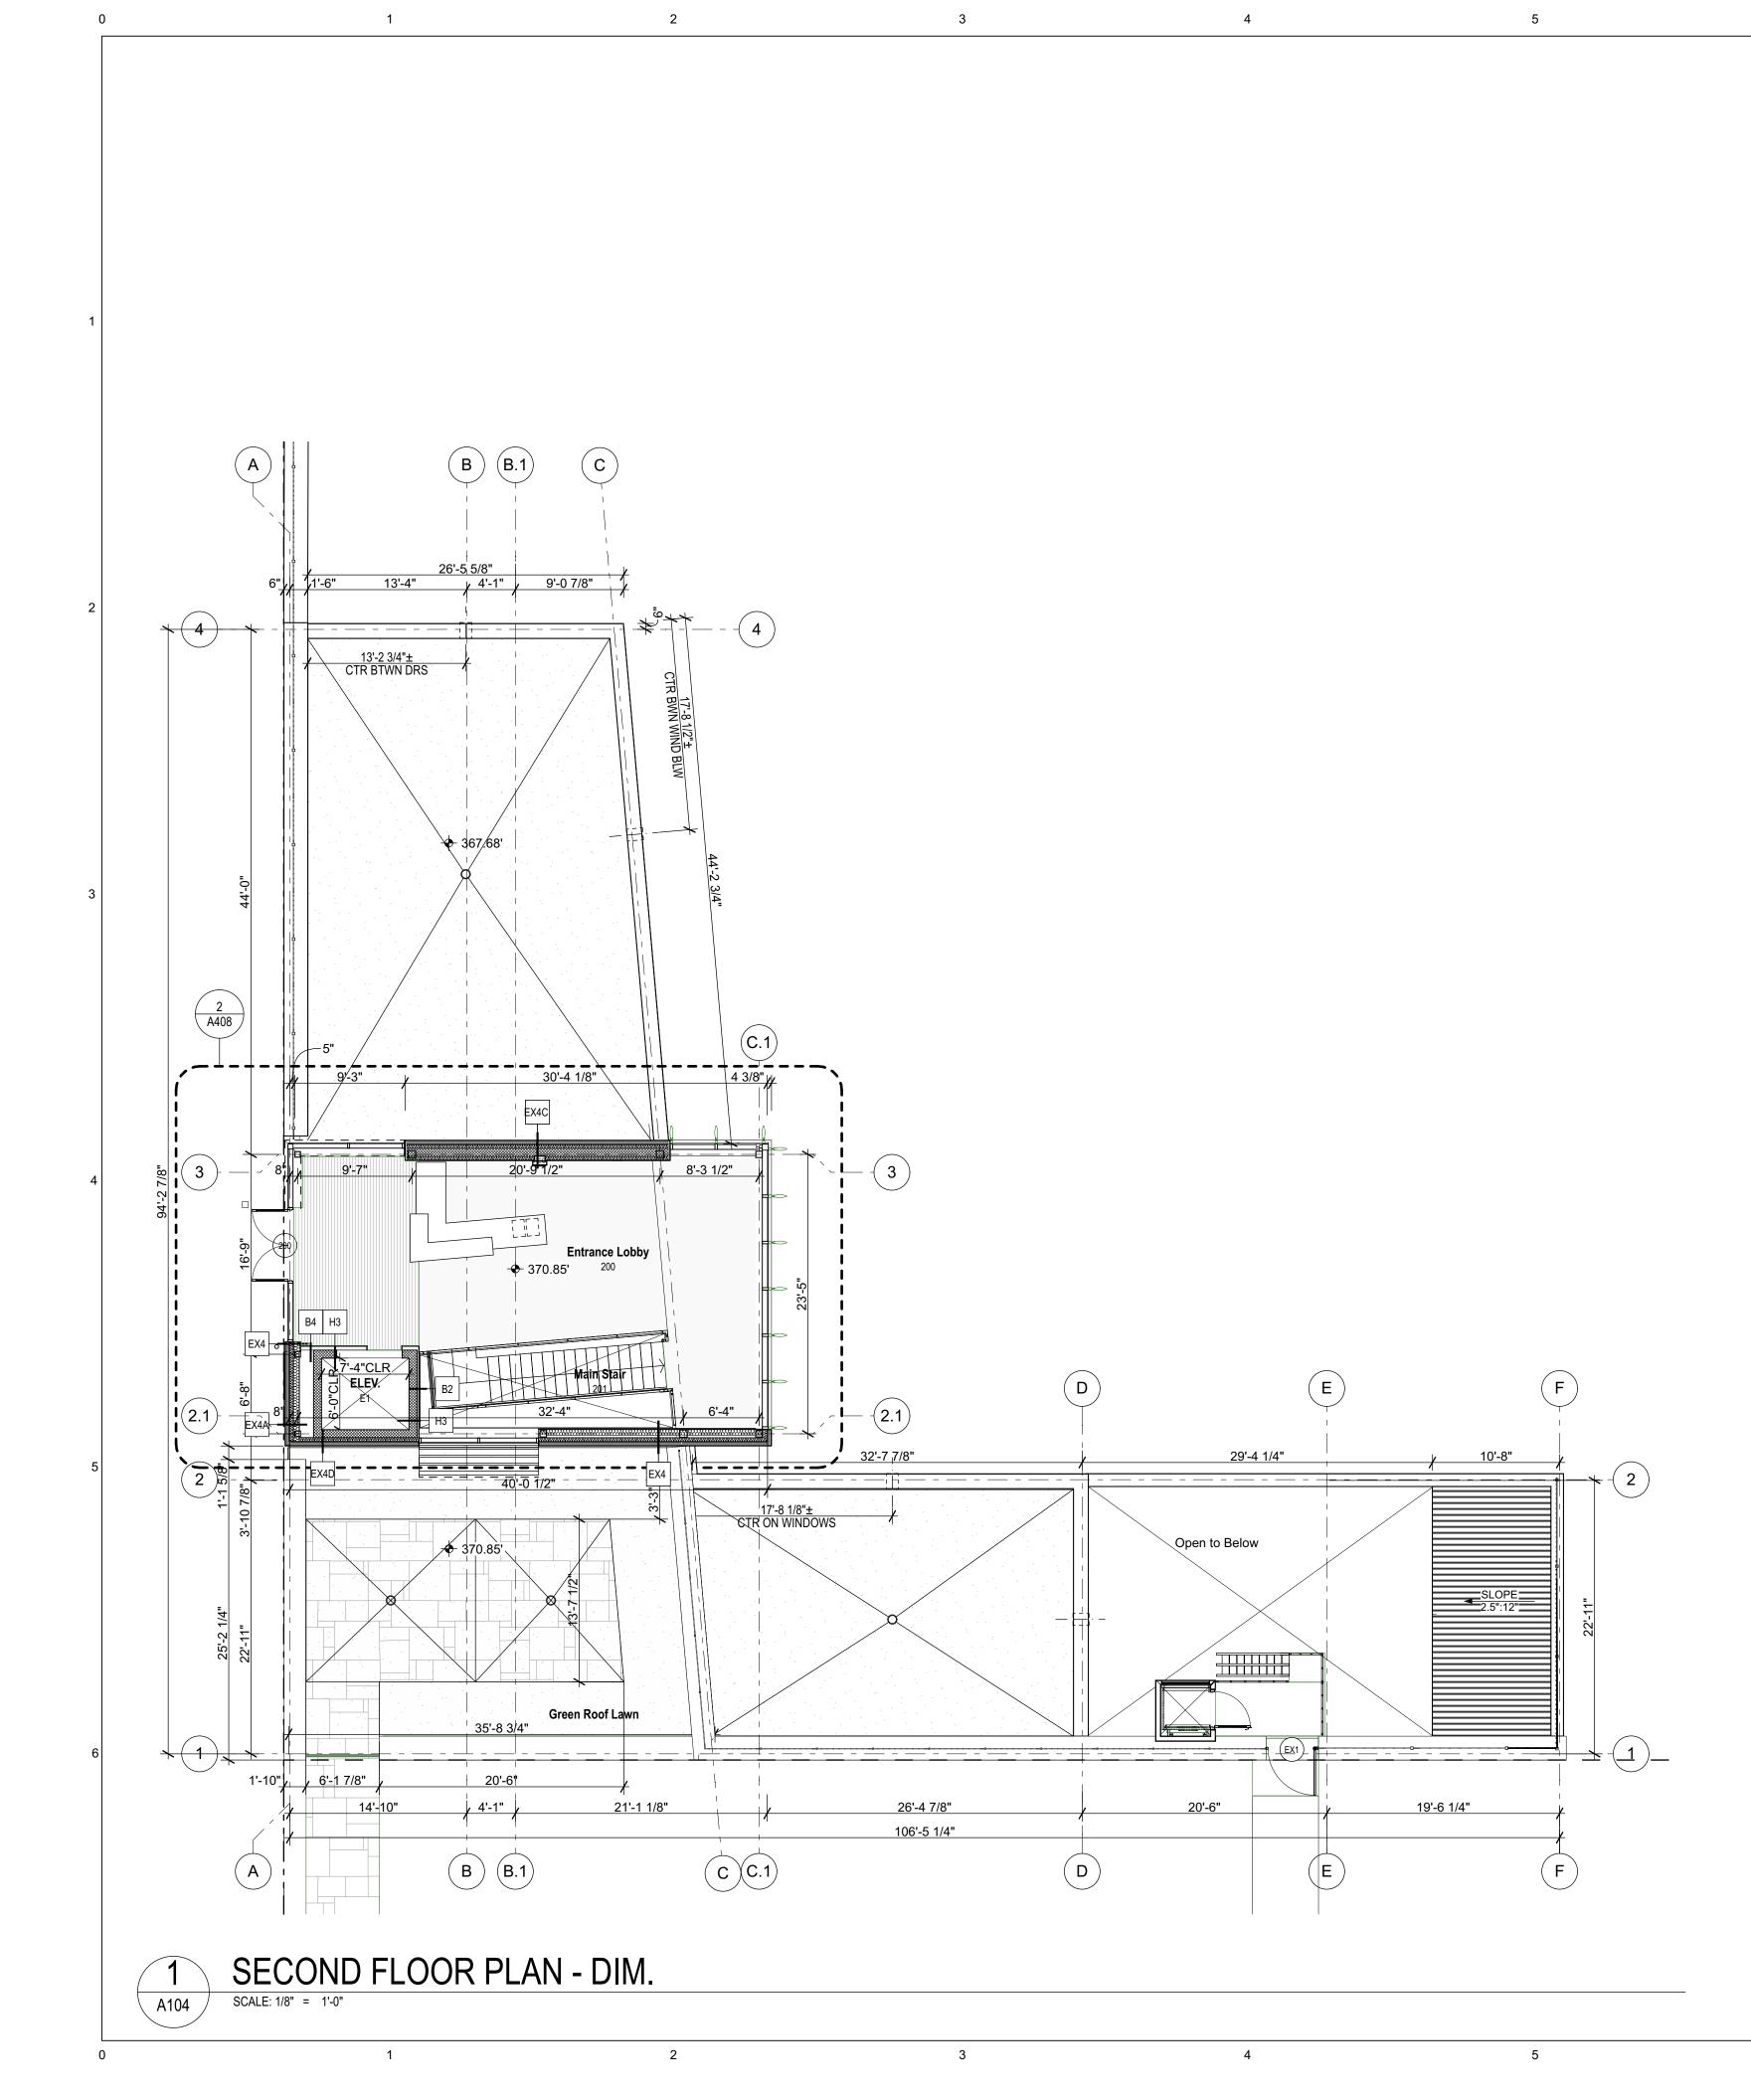

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# FLOOR PLAN LEGEND

	Keynote Tag
A1	Partition Type Symbol
•	Align Symbol

#### FLOOR PLAN GENERAL NOTES

- A. SEE A601 FOR PARTITION TYPES.
- B. DIMENSIONS ARE AS FOLLOWS U.N.O. COORDINATE ALL W WALL SECTIONS
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03	02/06/19	Permit Submission
04	02/20/19	<b>Pool Gutter Revision</b>

Drawing Title: SECOND FLOOR DIMENSION PLAN

Graphic Scale: 1/8" = 1'-0"


Project No:

1614

Date: 02/06/2019 Drawing No:

A104



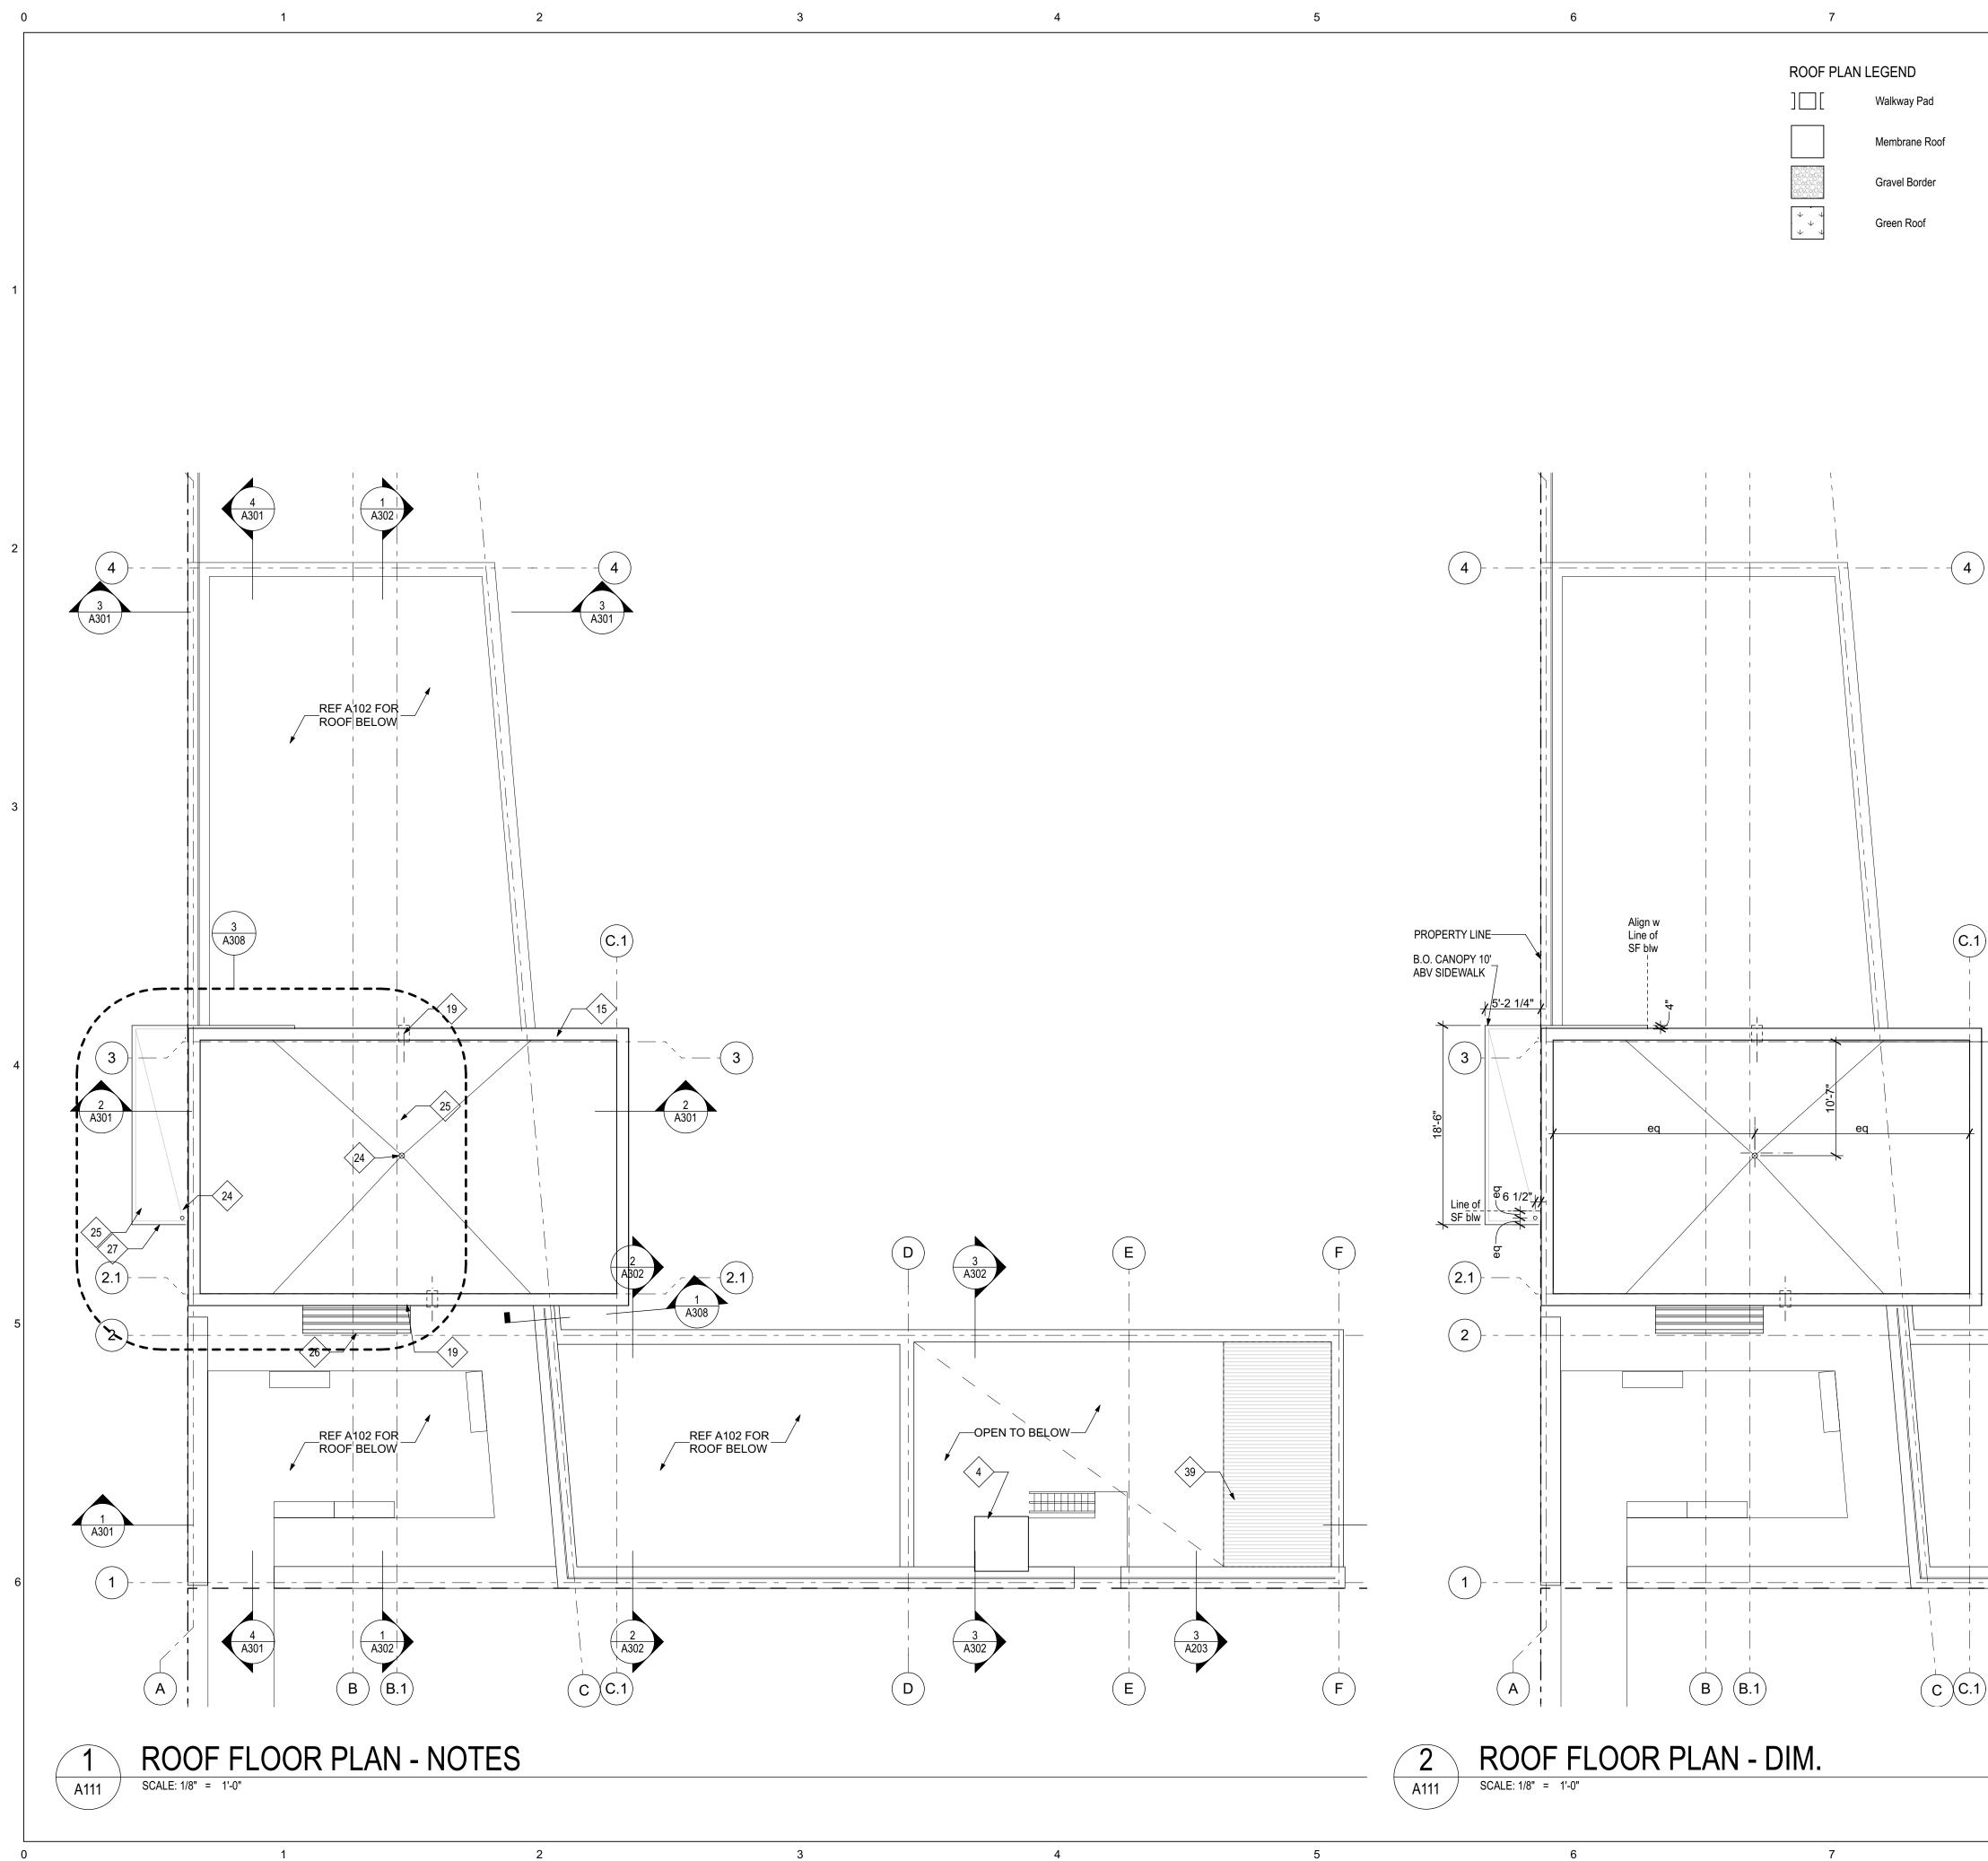




#### FLOOR PLAN GENERAL NOTES

- A. SEE A601 FOR PARTITION TYPES.
- B. DIMENSIONS ARE AS FOLLOWS U.N.O. COORDINATE ALL W WALL SECTIONS • TO FINISHED FACE OF MASONRY WALL
- TO FACE OF SHEATHING INTERIOR TO FINISHED FACE OF WALL
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#### FLOOR PLAN / ROOF KEYED NOTES

- 1. PLAM BASE AND WALL CABINETS.
- 2. LINE OF OVERHANG ABOVE.
- 3. SHEETING AND SHORING, REFER STRUCTURAL DRAWINGS. 4. EXTERIOR RATED LIFT W/ ENCLOSURE BY LIFT MFR.
- 5. ALTERNATING TREAD STAIR, GALV., PTD.
- 6. SUMP PUMP PIT SEE PLUBMING.
- 7. STEEL PAN STAIR WITH 21 X 12 HSS STRINGERS, BAR STOCK RAILING W PERFORATED METAL PANELS. 8. GRAVEL BORDER.
- 9. BENCHES.
- 10. PROPERTY LINE.
- 11. RECESSED WALK OFF GRILLE
- 12. WALK OFF MAT.
- 13. EXTENSIVE GREEN ROOF. 14. INTENSIVE GREEN ROOF; LAWN AND PLANTINGS, REF: LANDSCAPE.
- 15. METAL COPING.
- 16. ST-1 CAP AND ST-1 VENEER AT SITE OR PARAPET WALL. SEE WALL SECTIONS.
- 17. FENCING, REFER LANDSCAPE. 18. GREENWALL, REFER LANDSCAPE.
- 19. SCUPPER. 20. PLAM RECEPTION DESK WITH SOLID SURFACE COUNTER AND
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- 22. BIKE RACKS, REFERENCE LANDSCAPE.
- 23. SHEETING AND SHORING FOR RETAINING WALL WITH METAL PANEL FACING AND PRECAST CONCRETE CAP. 24. ROOF DRAIN.
- 25. WHITE PVC ROOFING.
- 26. SUNSHADE.
- 27. 1/2" ALUMINUM LETTERING ON SUPPORTS.
- 28. GRAVEL BORDER.
- 29. CANOPY. 30. DRAIN.
- 31. FRP LADDER
- 32. MOP RACK SEE BATH ACCESSORIES & TYP MOUNTING HTS
- 33. FEC OR WALL MTD FIRE EXTINGUISHER. SEE PLANS
- 34. HOUSEKEEPING PAD SEE MEP & STRUCT DWGS
- 35. WALL MTD METAL ACOUSTIC PANELS SEE ELEV FOR MTG HT 36. DOOR ACTUATOR.
- 37. ACCESS HATCH FOR EJECTOR PUMP SEE PLUMB & POOL 38. BOLLARD W ACTUATOR & CARD READER MTD.
- 39. PREFINISHED CORRUGATED ALUMN ROOF.
- 40. PAVER STONES SET FLUSH W GREEN ROOF. SEE LANDSCAPE & ROOF TYPES.

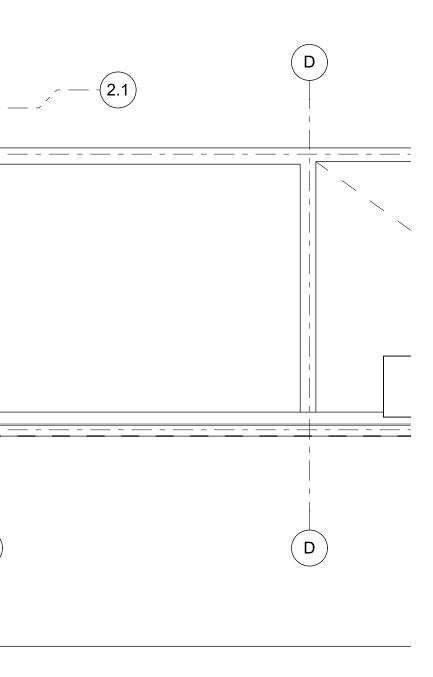

PROJECT Hearst Park & Pool 3950 37th Street, NW Washington, DC 20008

# **OWNER'S REPRESENTATIVE**

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#### LANDSCAPE ARCHITECT

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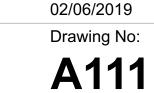
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#### Drawing Title: ROOF PLANS


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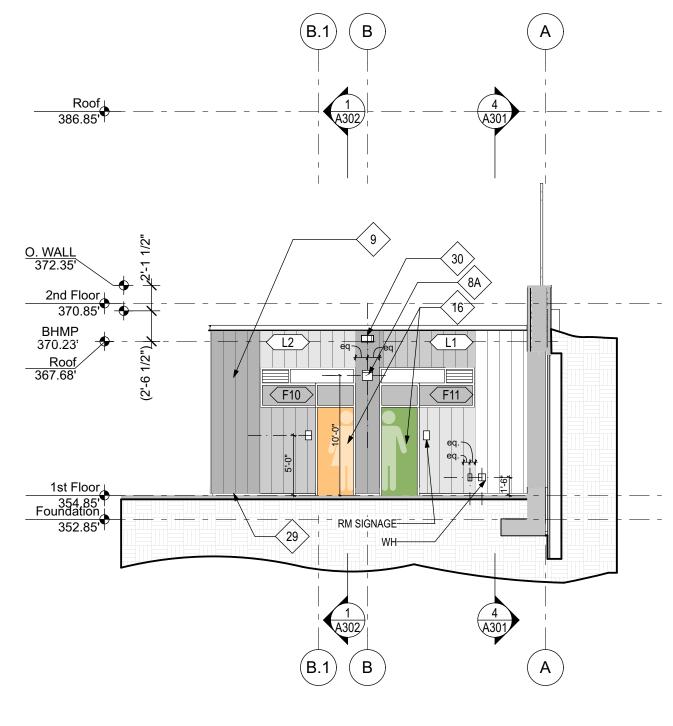
Project No:

1614



Date:



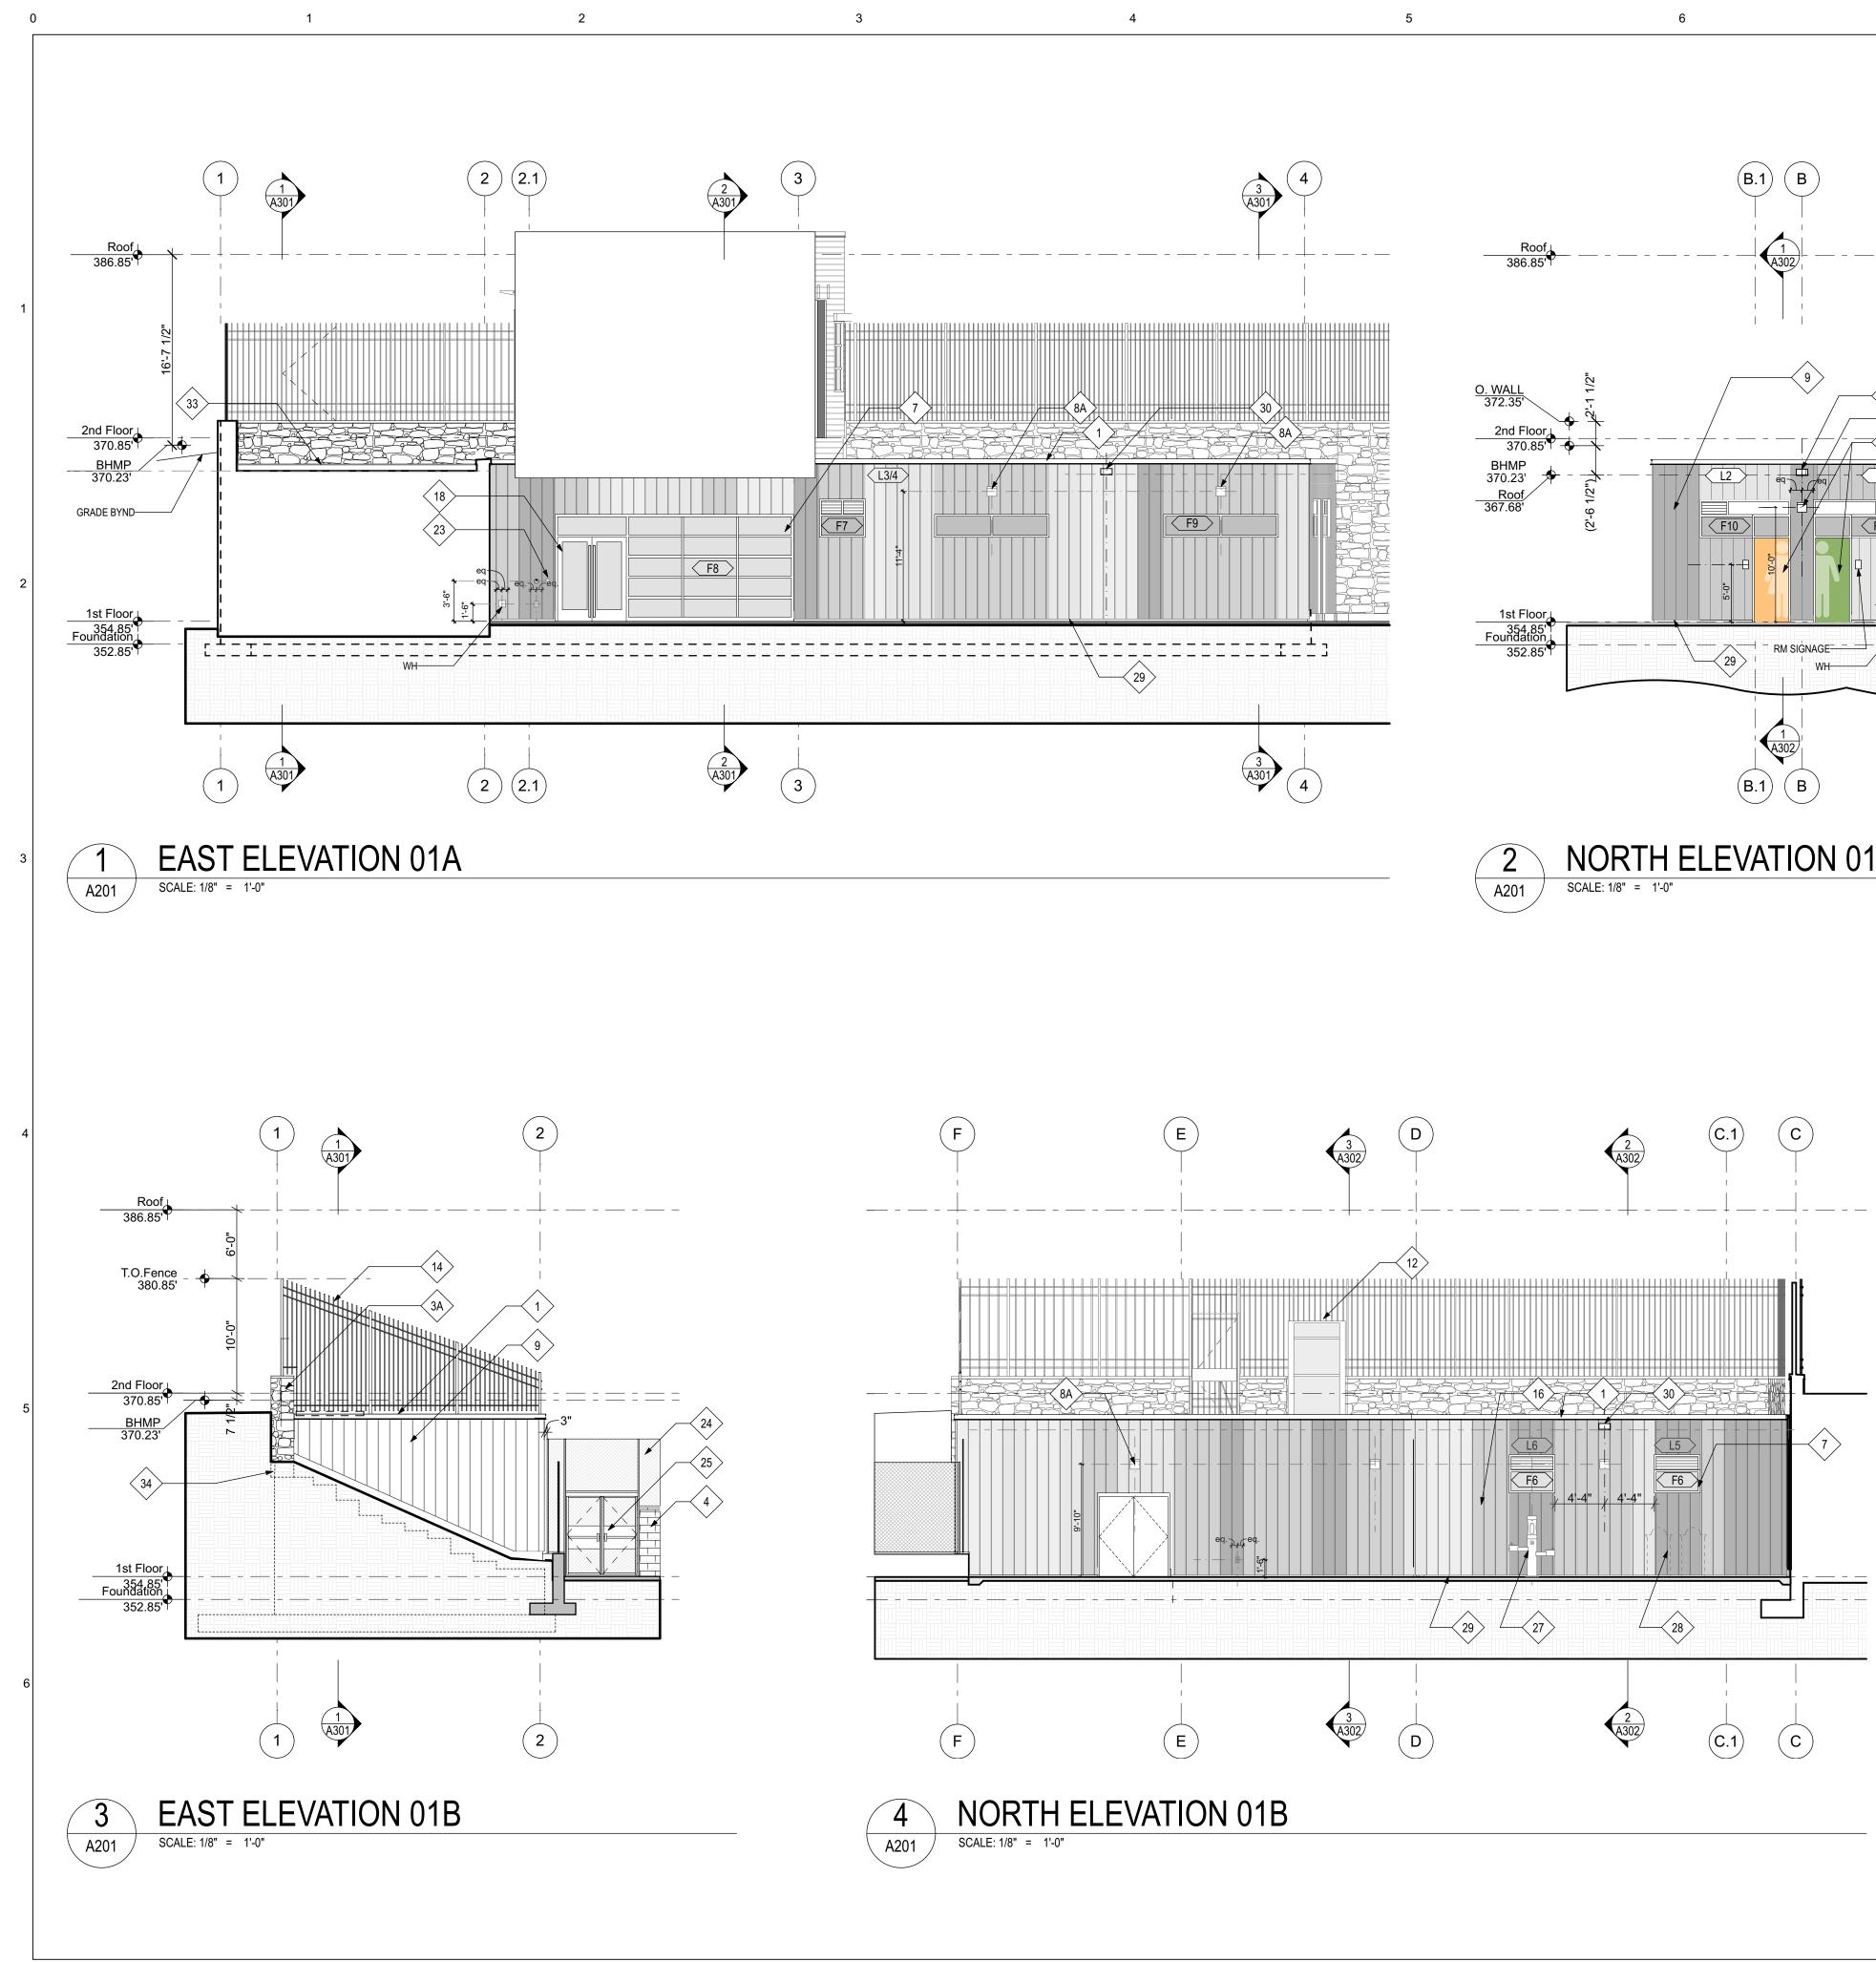



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## **ELEVATION / BUILDING SECTION GENERAL NOTES**

A. REVIEW ALL DEVICE LOCATIONS WITH MTL PANEL LAYOUT. B. METAL PANEL PATTERN IS NOT FINAL, BUT REPRESENTATIVE OF APPROXIMATE DISTRIBUTION AND PATTERN COMPLEXITY. FINAL DESIGN AND COLOR SELECTION TO BE REVIEWED. ALLOW FOR (4) COLORS TOTAL.

### ELEVATION KEYED NOTES

- 1. METAL COPING.
- 2. LONGBOARD HORIZONTAL METAL CLADDING.
- 3A. CONCRETE WALL W ST-2 VENEER AND ST-1 CAP. 3B. PERMANENT SHEETING & SHORING W PRECAST LAGGING. ST-2 VENEER CLADDING ST-1 CAP. SEE STRUCT.
- 4. CMU WALL W CONC WALL CAP. BLOCK FILLER & HIGH PERFORMANCE COATING.
- 5. CURTAINWALL WITH SOLARBAN 70 IGU.
- 6. CANOPY BEYOND.
- 7. STOREFRONT WITH SOLARBAN 70 IGU ( LAMINATED GLASS 1/4" +
- PVB + 1/8" @ OUTER PANE). 8A. EXTERIOR LIGHTING SEE ÉLECT. CENTER ON DR OR WINDOW.
- 8B. EXTERIOR LIGHTING SEE ELECT. MTD TO FENCE POST.
- 9. METAL PANEL SIDING.
- 10. CANOPY WITH 'C' CHANNELS AT PERIMETER AND METAL PANEL CLADDING WITH MITERED CORNERS AND EDGES.
- 11. VERTICAL SUNSHADES.
- 12. STEEL FRAMED ENCLOSURE W STL AND ACRYLIC PANELS BY LIFT MFR. 13. SLOPING GRADE BEYOND.
- 14. MTL PICKET FENCING, SEE LANDSCAPE DRAWINGS.
- 15. GREEN WALL, REFER LANDSCAPE DRAWINGS.
- 16. GALVANIZED DOOR AND FRAME, PTD.
- 17. INSULATED BRAKE METAL INFILL PANEL. SET FLUSH W ADJACENT WINDOW FRAME. 18. MEDIUM STILE ALUMINUM DOORS WITH DOOR PULLS.
- 19. SUNSHADE.
- 20. HOT DIPPED GALVANIZED RAILING.
- 21. BIKE RACK.
- 22. BUILDING SIGNAGE 23. CARD READER
- 24. CHAINLINK FENCING, SEE LANDSCAPE DRAWINGS.
- 25. CHAINLINK GATE W PANIC HDWR & ALARM 26. PRE-ENGINEERED GALVANIZED & POWDER COATED STL STAIR
- WITH HANDRAIL & PLATFORM 27. EXTERIOR WATER FOUNTAIN / BOTTLE FILLING STATION
- 28. APPRPX LOCATION OF TRASH & RECYCLING. SEE LANDSCAPE.
- 29. SS BREAK MTL BASE TRIM
- 30. SCUPPER. SEE EXTERIOR DETAILS. COORD FINISH W COPING & SIDING FOR LOCATION. 31. PHOTOCELL FOR EXTERIOR LIGHTING - SEE ELECT. BLACK FINISH.
- GC TO CONFIRM ONO OBSTRUCTIONS. 32. ALUMINUM EDGE TERMINATION TRIM BY SIDING MFR.
- 33. FLASHING SEE WALL SECT.
- 34. APPROX EXTENT OF STONE BLW GRADE.

#### ELEVATION FINISH LEGEND

MP-1 Vertical Mtl Panel Color 1

MP-2

Vertical Mtl Panel Color 2

MP-3 Vertical Mtl Panel Color 3

MP-4

Vertical Mtl Panel Color 4

- Horizontal Aluminum Siding Flooring

ST-1 Caderock Stone Veneer

#### PROJECT Hearst Park & Pool 3950 37th Street, NW Washington, DC 20008

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Setty & Associates International, PLLC Adress: 5185 MacArthur Blvd., Suite 220 Washington, DC 20016 T: 202.393.1523

#### LANDSCAPE ARCHITECT


CGLA 1025 Connecticut Avenue NW., Suite 1000 Washington, DC 20036 T: 202.857.9720

#### POOL CONSULTANT Counsilman-Hunsaker

10733 Sunset Office Dr., Suite 400 St. Louis, MO 63127 T: 314.894.1245

#### AV/ IT/ ACOUSTICS CONSULTANT

Polysonics 405 Belle Air Lane Warrenton, VA 20186 T: 540.341.4988

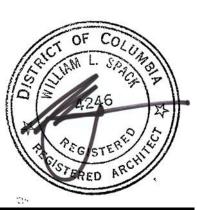

Mark	Date	Description
01	6/11/18	Design Development Set
02	11/20/18	FTG Permit Submission
03	02/06/19	Permit Submission
04	02/20/19	Pool Gutter Revision

Drawing Title: **BUILDING EXTERIOR ELEVATIONS** 

Graphic Scale:

Project No: 1614


Date: 02/06/2019 Drawing No:

A201



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#### **ELEVATION / BUILDING SECTION GENERAL NOTES**

A. REVIEW ALL DEVICE LOCATIONS WITH MTL PANEL LAYOUT. B. METAL PANEL PATTERN IS NOT FINAL, BUT REPRESENTATIVE OF APPROXIMATE DISTRIBUTION AND PATTERN COMPLEXITY. FINAL DESIGN AND COLOR SELECTION TO BE REVIEWED. ALLOW FOR (4) COLORS TOTAL.
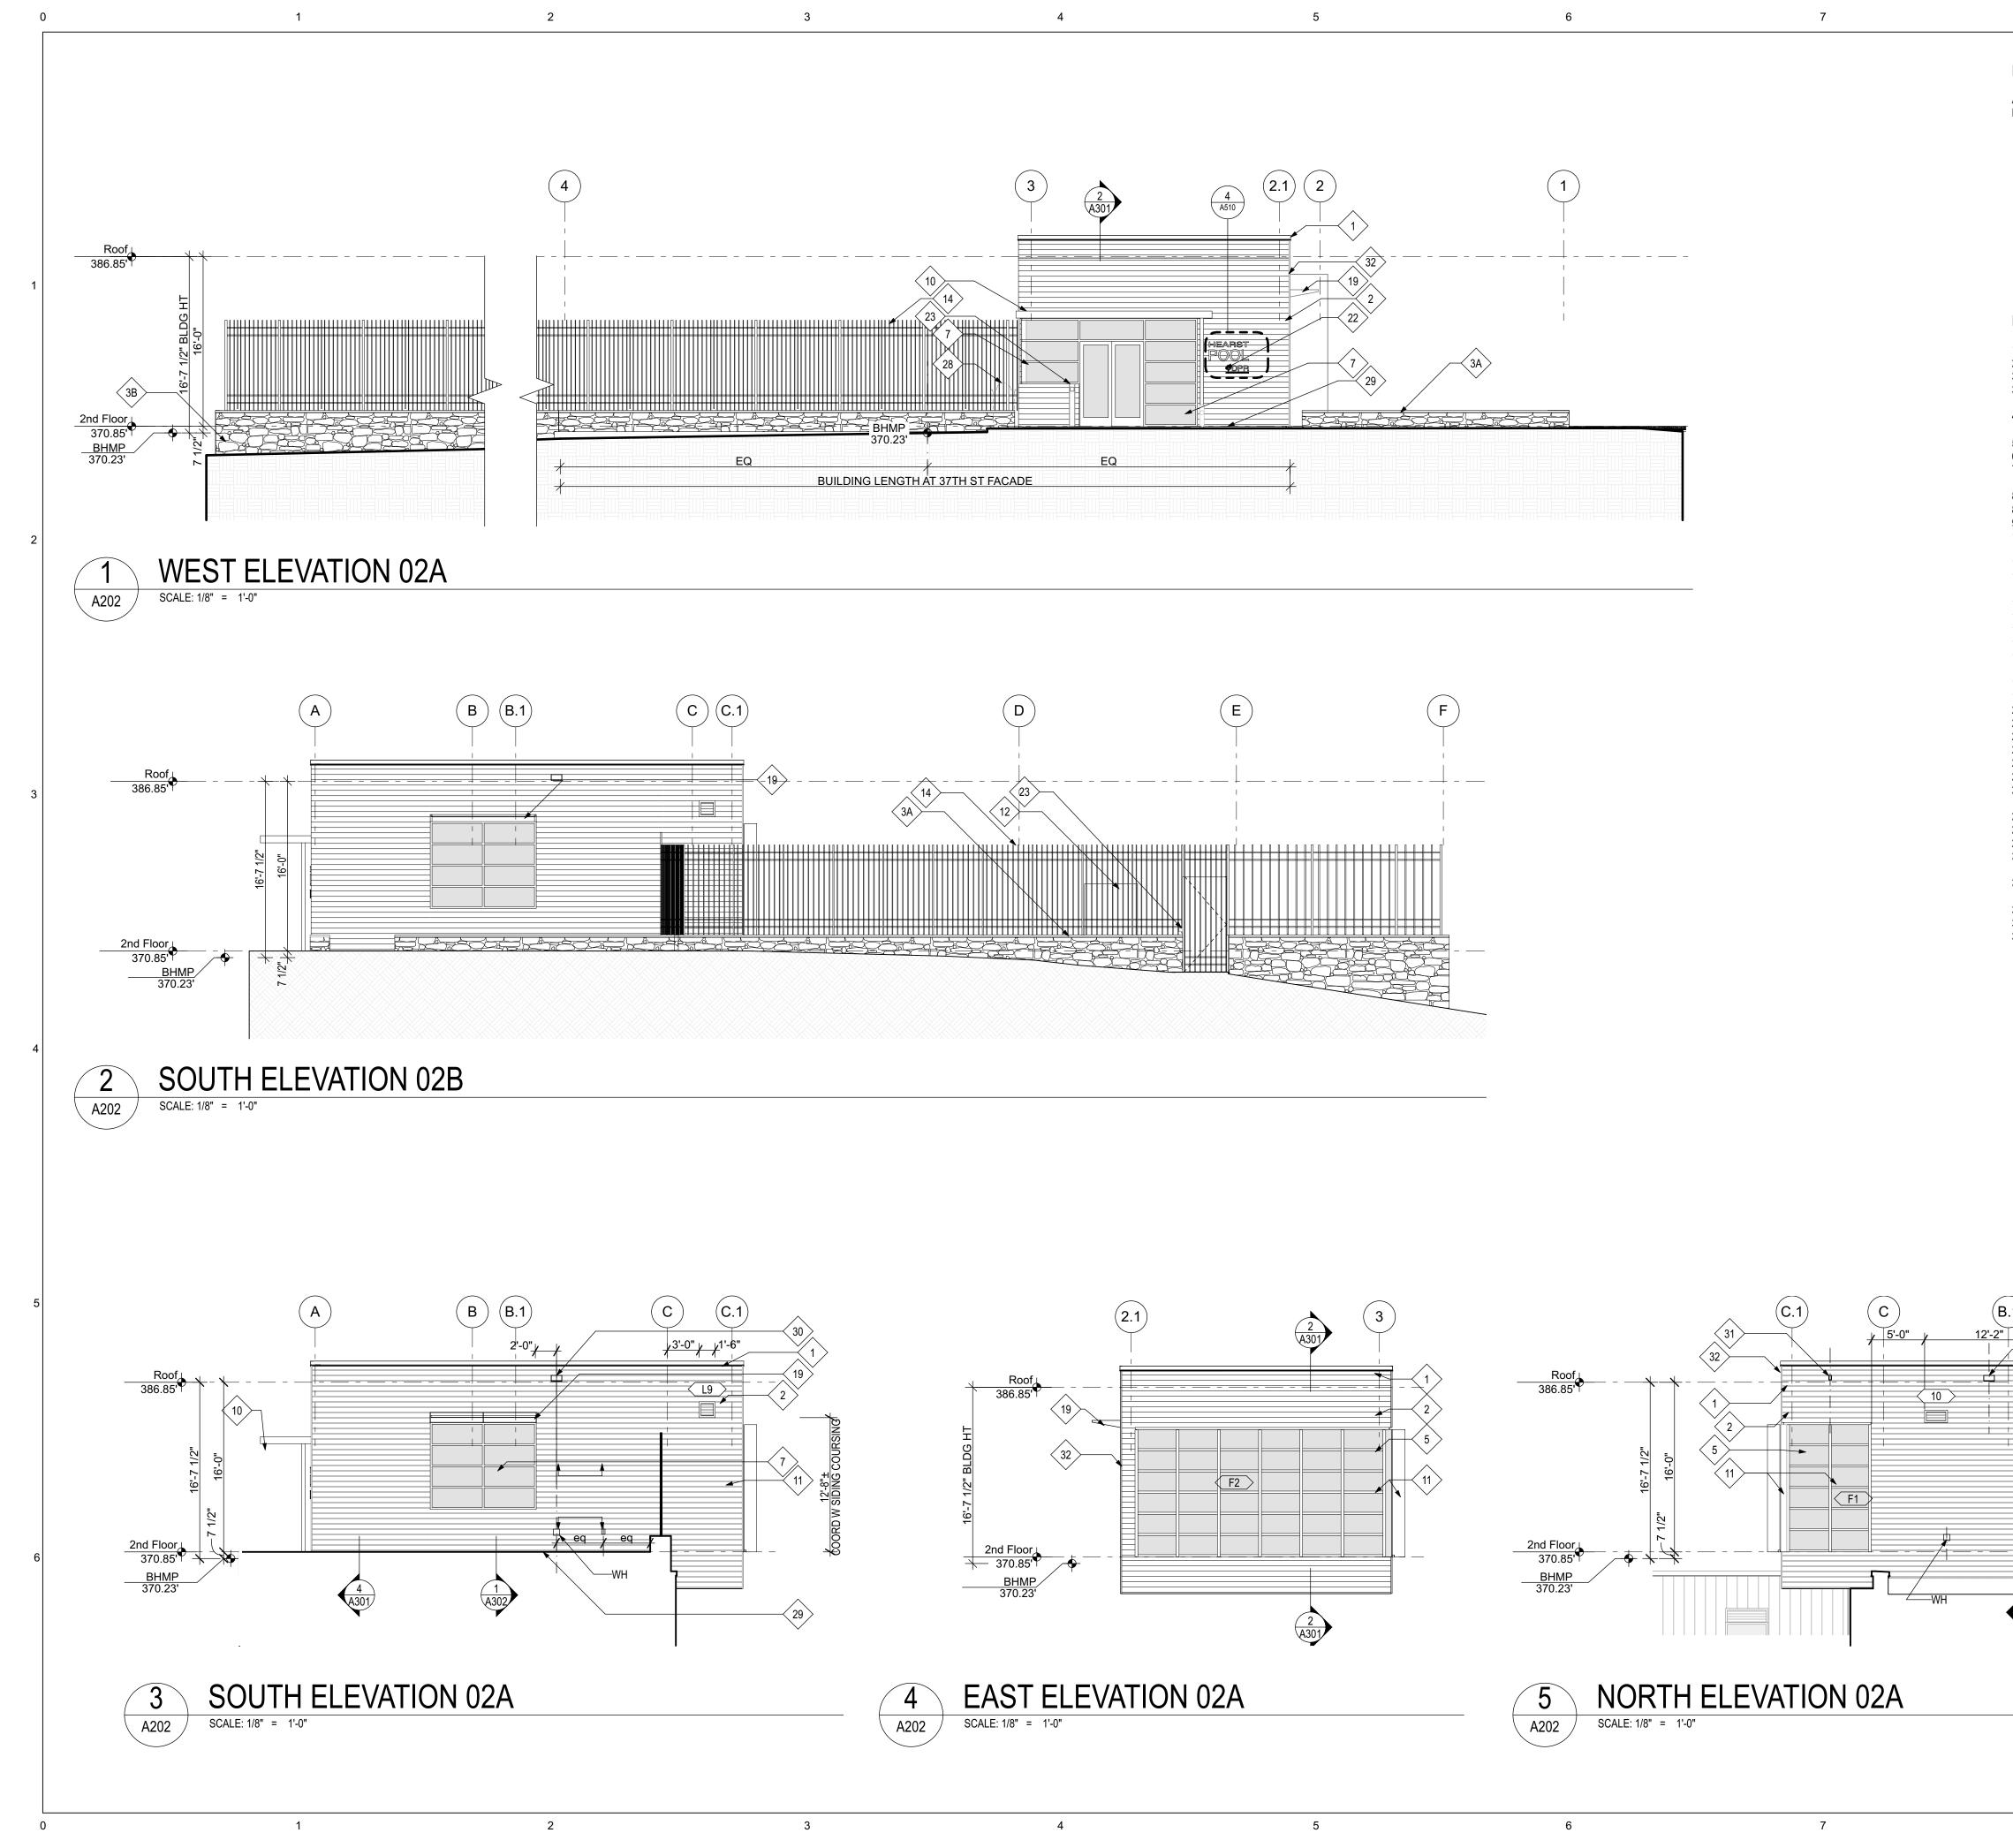
#### ELEVATION KEYED NOTES

- 1. METAL COPING.
- 2. LONGBOARD HORIZONTAL METAL CLADDING.
- 3A. CONCRETE WALL W ST-2 VENEER AND ST-1 CAP. 3B. PERMANENT SHEETING & SHORING W PRECAST LAGGING. ST-2 VENEER CLADDING ST-1 CAP. SEE STRUCT.
- 4. CMU WALL W CONC WALL CAP. BLOCK FILLER & HIGH PERFORMANCE COATING.
- 5. CURTAINWALL WITH SOLARBAN 70 IGU.
- 6. CANOPY BEYOND.
- 7. STOREFRONT WITH SOLARBAN 70 IGU ( LAMINATED GLASS 1/4" +
- PVB + 1/8" @ OUTER PANE). 8A. EXTERIOR LIGHTING SEE ELECT. CENTER ON DR OR WINDOW.
- 8B. EXTERIOR LIGHTING SEE ELECT. MTD TO FENCE POST.
- 9. METAL PANEL SIDING.
- 10. CANOPY WITH 'C' CHANNELS AT PERIMETER AND METAL PANEL CLADDING WITH MITERED CORNERS AND EDGES.
- 11. VERTICAL SUNSHADES.
- 12. STEEL FRAMED ENCLOSURE W STL AND ACRYLIC PANELS BY LIFT MFR. 13. SLOPING GRADE BEYOND.
- 14. MTL PICKET FENCING, SEE LANDSCAPE DRAWINGS.
- 15. GREEN WALL, REFER LANDSCAPE DRAWINGS.
- 16. GALVANIZED DOOR AND FRAME, PTD.
- 17. INSULATED BRAKE METAL INFILL PANEL. SET FLUSH W ADJACENT WINDOW FRAME. 18. MEDIUM STILE ALUMINUM DOORS WITH DOOR PULLS.
- 19. SUNSHADE.
- 20. HOT DIPPED GALVANIZED RAILING.
- 21. BIKE RACK.
- 22. BUILDING SIGNAGE 23. CARD READER
- 24. CHAINLINK FENCING, SEE LANDSCAPE DRAWINGS.
- 25. CHAINLINK GATE W PANIC HDWR & ALARM
- 26. PRE-ENGINEERED GALVANIZED & POWDER COATED STL STAIR WITH HANDRAIL & PLATFORM
- 27. EXTERIOR WATER FOUNTAIN / BOTTLE FILLING STATION 28. APPRPX LOCATION OF TRASH & RECYCLING. SEE LANDSCAPE.
- 29. SS BREAK MTL BASE TRIM
- 30. SCUPPER. SEE EXTERIOR DETAILS. COORD FINISH W COPING & SIDING FOR LOCATION. 31. PHOTOCELL FOR EXTERIOR LIGHTING - SEE ELECT. BLACK FINISH.
- GC TO CONFIRM ONO OBSTRUCTIONS. 32. ALUMINUM EDGE TERMINATION TRIM BY SIDING MFR.
- 33. FLASHING SEE WALL SECT.
- 34. APPROX EXTENT OF STONE BLW GRADE.

# (B.1) (в) Α 5'-0" 4 **F4**

#### PROJECT Hearst Park & Pool 3950 37th Street, NW Washington, DC 20008

# OWNER'S REPRESENTATIVE

**Department of General Services** 2000 14th Street NW, 8th Floor Washington DC, 20009

#### ARCHITECT

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#### **CIVIL ENGINEER**

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#### MPE ENGINEER

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01	6/11/18	Design Development Set
02	11/20/18	FTG Permit Submission
03	02/06/19	Permit Submission
04	02/20/19	<b>Pool Gutter Revision</b>

Drawing Title: **BUILDING EXTERIOR ELEVATIONS** 

Graphic Scale: 1/8" = 1'-0"


Project No:

1614

02/06/2019 Drawing No: A202

Date:



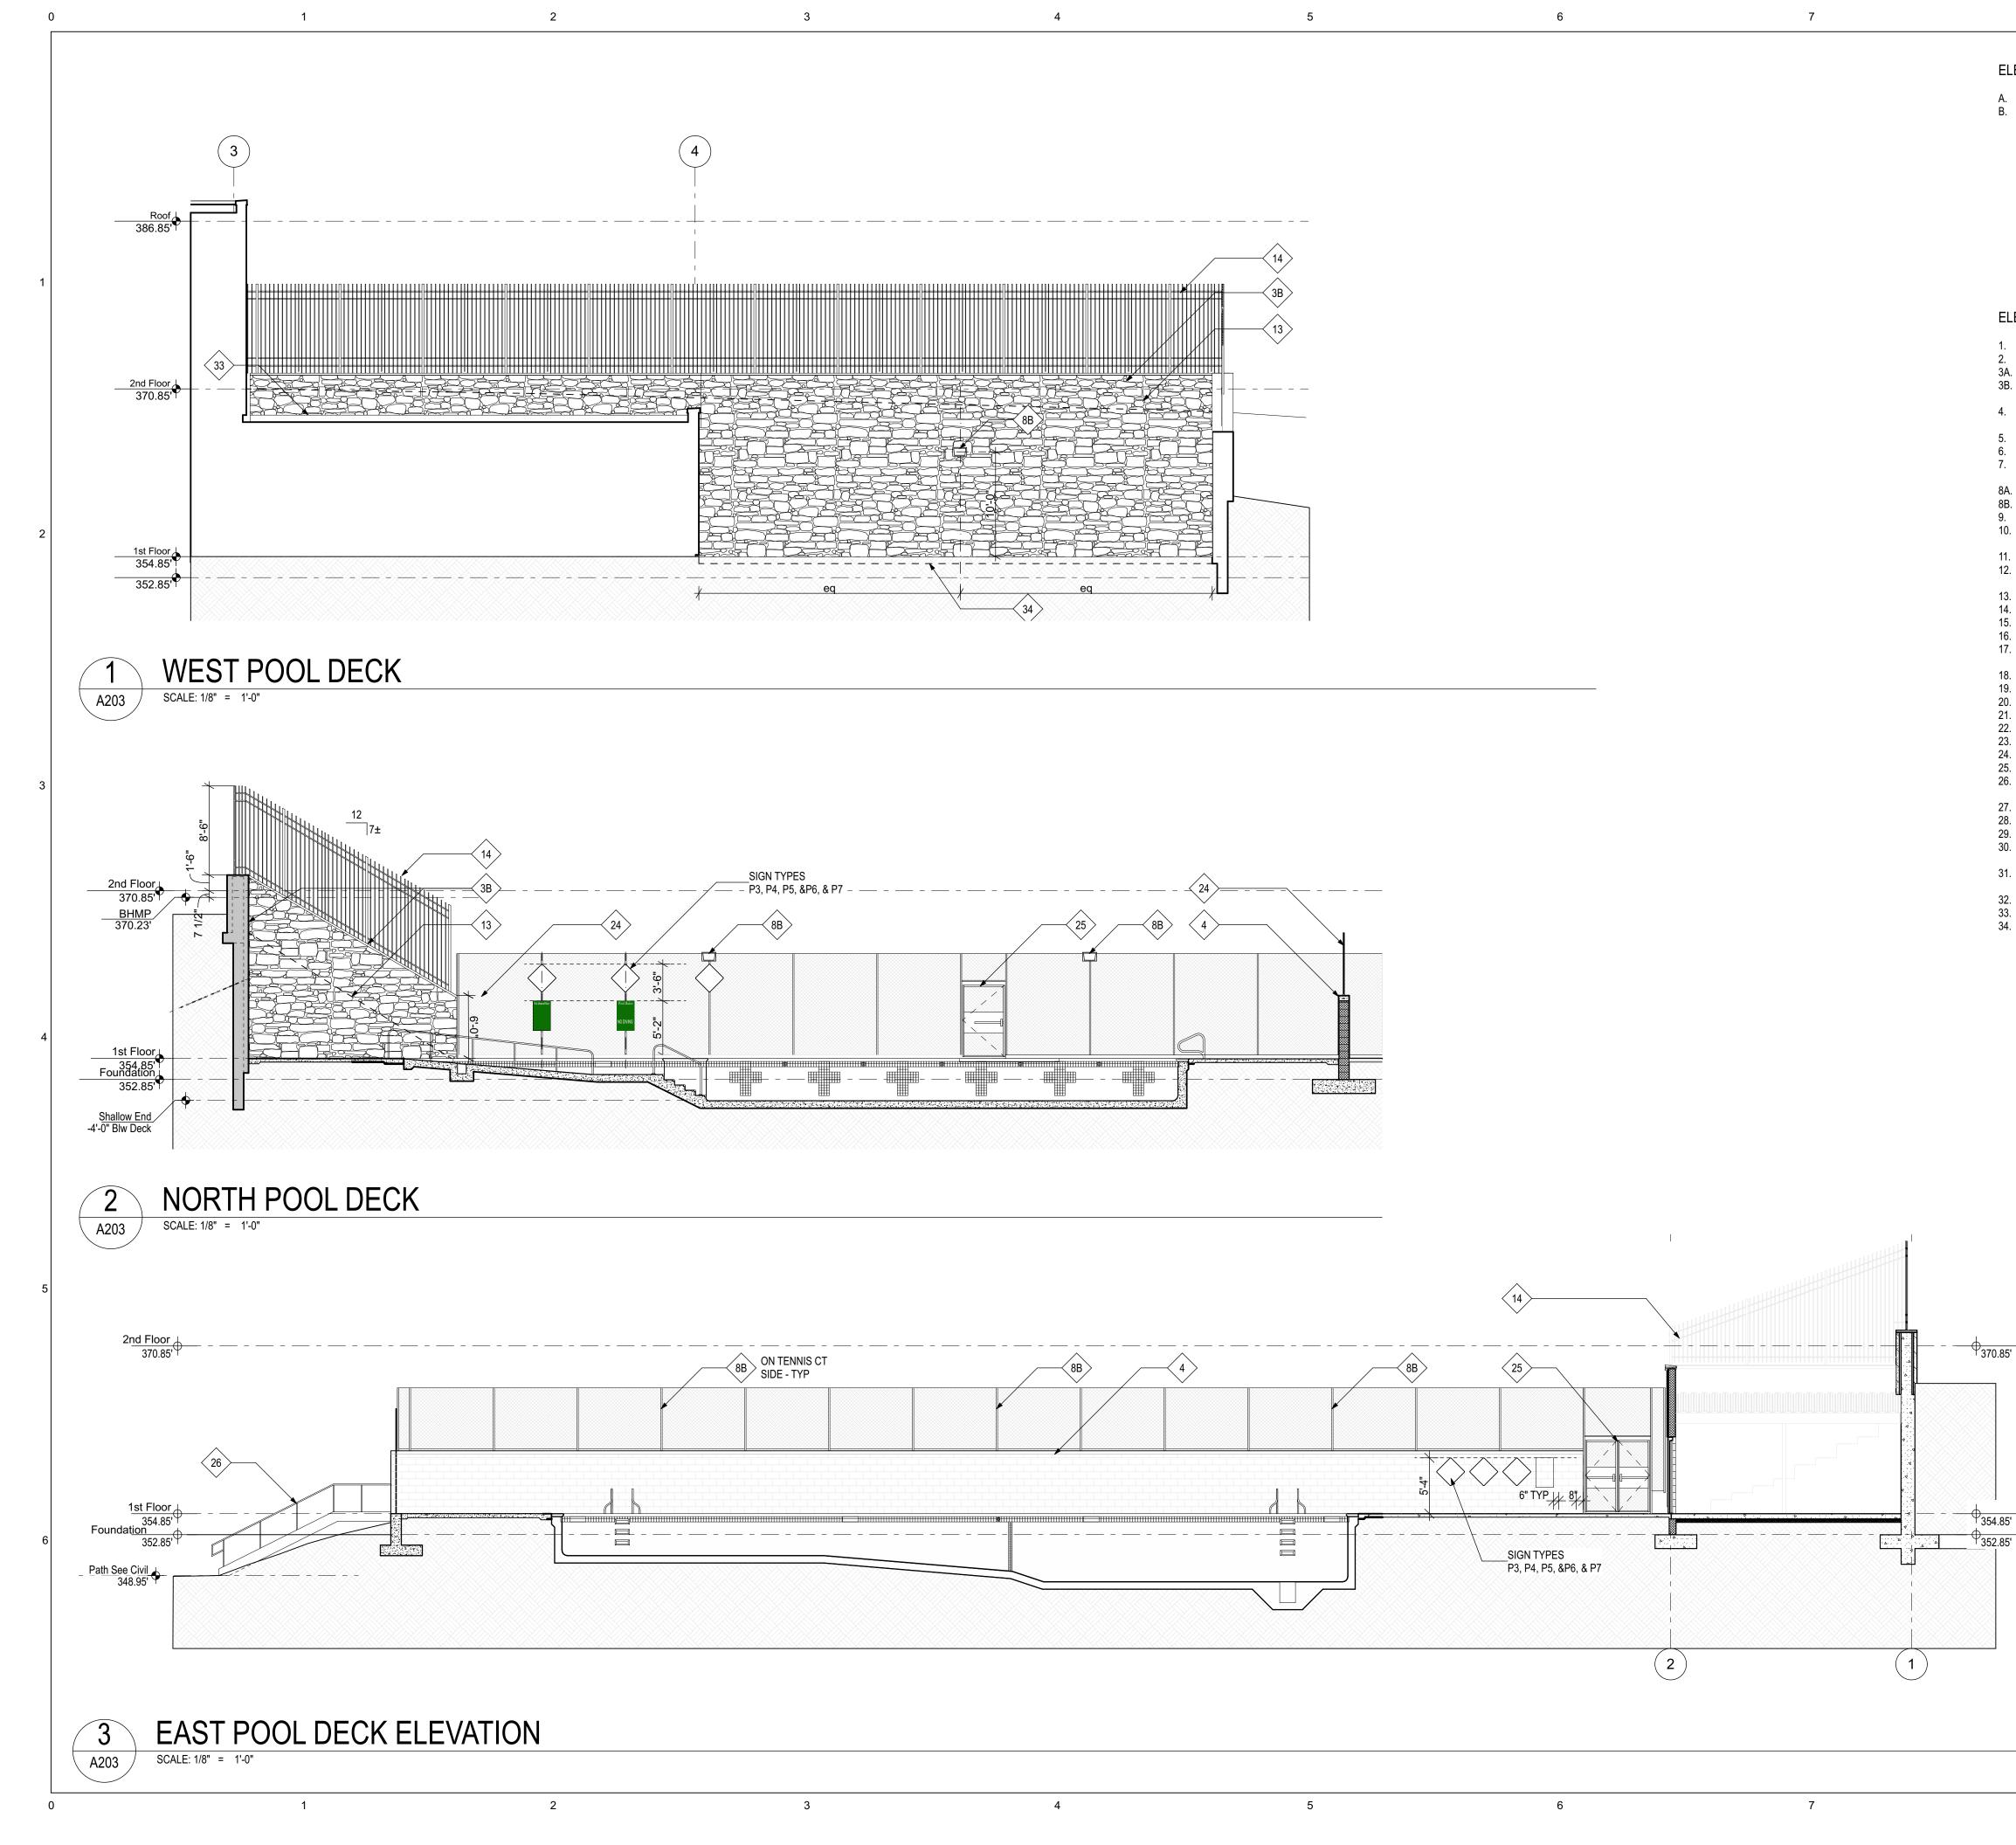

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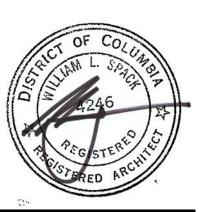
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Drawing Title: BUILDING SITE ELEVATIONS

Graphic Scale:

Project No: **1614** 

Date: 02/06/2019 Drawing No:

A203

