

BUNCH RESIDENCE

ROOF DECK ADDITION


906 Westminster St NW Washington, DC 20001

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CERTIFICATION



License # : PE901193

Jurisdiction : DISTRICT OF COLUMBIA

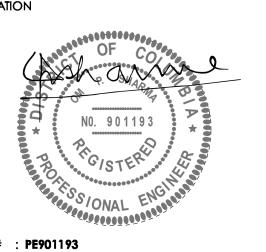Expiration : 08/31/2024

#	Release	Date
	Permit Set	15 JAN 2024
	Permit Comments	2 JUL 2024
	Permit Comments 2	6 AUG 2024
	Permit Comments 3	26 AUG 2024
	Permit Comments 4	27 OCT 2024

COVER

SHEET NUMBER

G000

GENERAL NOTES

1. Work performed shall comply with these general notes and construction documents. 2. Construction shall be performed in accordance with all current building, health, and life safety codes and regulations within the project's jurisdiction, including any other applicable state or national codes and requirements. See building code summary. 3. In areas where the drawings do not address methodology, the contractor shall be bound to perform in strict compliance with manufacturer's specifications and/or recommendations.

4. On-site verification of all dimensions and conditions shall be responsibility of the general contractor and his subcontractors. Drawings are dimensionally correct.

5. The general notes and typical details apply throughout the job unless otherwise noted or shown. There are no representations as to quantities whatsoever. The contractor shall be responsible for a thorough knowledge of the drawings and specifications and for his

own quantity estimations 6. Discrepancies: the contractor shall compare and coordinate all drawings; when in the opinion of the contractor, a discrepancy exists he shall promptly report it for proper adjustment before proceeding with the work.

7. Omissions: in the event certain features of the construction are not fully shown on the drawings, their construction shall be of the same character as for similar conditions that

8. The designer will not be responsible for/and will not have control over construction means, methods, techniques, sequences or procedures, or for safety precautions and programs in connection with the work, and will not be responsible for the failure of the client or his contractors, subcontractors, or anyone performing any of the work, to carry out the work in accordance with the approved contract documents.

9. Use temporary bracing as required to stabilize basement walls and superstructure until permanent construction is in place. The basic stability of the structure is dependent upon the diaphragm action of the floors, walls and roof acting together. Contractor to provide all guys, braces, struts, etc. As required to accommodate all live, dead and wind loads until all final connections between these elements are made

10. Unless otherwise specifically noted, the contractor shall provide and pay for all labor, materials, equipment, tools, construction equipment and machinery, water, heat, utilities, transportation, and other facilities and services necessary for the proper execution and

11. The contractor shall at all times enforce strict discipline and good order among his employees and shall not employ on the job any unfit person or anyone not skilled in the task assigned to him.

12. Contractor shall pay all sales, consumer, use and other similar taxes required by law. Unless otherwise provided, contractor shell secure and pay for all permits, fees and licenses necessary for the proper execution and completion of the work.

13. The contractor shall give all notices and comply with all laws, ordinances, rules, regulations, and order of any public authority bearing on the performance of the work. If the contractor observes that any of the contract documents are in variance there with in any respect, he shall promptly notify the designer/architect in writing, and any necessary changes shall be adjusted by appropriate modification. If contractor performs any work knowing it to be contrary to such lows, ordinances, rules and regulations, and without such notice to the designer/architect, he shall assume full responsibility therefore and

shall bear all cost attributable thereto. 14. Contractor shall confine operations at the site to areas permitted by law, ordinances, permits; and the contract documents and shall not unreasonably encumber the site with any materials or equipment.

15. The contractor shall be responsible for lines, elevations, measurements of building and other work executed under this contract.

16. Refer discrepancies between drawing and specifications to designer/architect for adjustment before work affected is performed. Failure to make such notification shall place the responsibility upon contractor to carry out work in a satisfactory and workmanlike manner.

17. The general contractor shall submit, with reasonable promptness and in such sequence as to cause no delay in the work of any separate contractor, all shop drawings, product data, and samples required by the construction specifications. Contractor shall discuss and submit samples of paint, carpet, wall covering, wood finish, etc. To owner prior to any fabrication and installation.

18. By submitting shop drawings, product data, and samples, the general contractor represents that he has determined and verified all materials, field measurements, and field construction criteria related thereto, or will do so, and that he has checked and coordinated the information contained within such submittals with the requirements of the work and of the construction specifications.

19. No portion of the work requiring submission of a shop drawing, product data, or sample shall be commenced until the submittal has been approved by the owner and designer/architect. All such portions of the work shall be in accordance with approved

20. The general contractor shall at all times keep the premises free from accumulation of waste materials or rubbish caused by his operations. At the completion of the work he shall remove all his waste materials and rubbish from and about the project as well as all his tools, construction equipment, machinery. And surplus materials.

21. If the general contractor fails to clean up daily and at the completion of the work. The owner may do so and the cost thereof shall be charged to the general contractor. 22. Any damage to of theft of new or existing construction caused by the contractor's negligence or inadequate protective or security measures during construction are to be corrected at the contractor's expense.

SYMBOLS

ABBREVIATIONS

CMU

CTR

COL

CONT

DIM

DWG

ELEC

EQUIP

EQ

EXIST

CENTER

COLD WATER

DEGREES

DIAMETER

DIMENSION

DRAWING(S)

ELEVATION

ELECTRICAI

EQUIPMENT

DETAIL

DOWN

EACH

EQUAL

EXISTING

EXPOSED

EXTERIOR

FOOT / FEET

FIELD VERIFY

GALVANIZED

HEADER

HDWD HARDWOOD

HDWR HARDWARE

HORZ HORIZONTAL

HOLLOW CORE

HOLLOW METAL

FLOOR

FINISHED FLOOR

GENERAL CONTRACTOR

GYPSUM WALL BOARD

ACC ACCESSIBLE HOUR ACOUSTICAL CEILING TILE HVAC HEATING, VENTILATING, AND AIR ADJACENT CONDITIONING ABOVE FINISHED FLOOR HOT WATER ALUMINUM **INSUL** INSULATION APPROX APPROXIMATE INFO INFORMATION BLKG BLOCKING MAX MAXIMUM **BOTTOM OF BEAM** MECH MECHANICAL BUILDING MECHANICAL, ELECTRICAL, AND CABINET PLUMBING CEILING

MANUFACTURER CLEAR / CLEARANCE MIN MINIMUM CONCRETE MASONRY UNIT MTL METAL NATURAL COLUMN NOT IN CONTRACT CONC CONCRETE NTS NOT TO SCALE CONTINUOUS OVERALL CONST CONSTRUCTION

OA OC ON CENTER OPNG OPENING PLYWD PLYWOOD PROJECT MANAGER PAINT **RADIUS**

REFERENCE REQD REQUIRED REVISED / REVISION REV SC SHT SOLID CORE SHEET SIM SIMILAR

SPEC SPECIFICATION(S) SQ SQUARE **SQUARE FEET** STAINLESS STEEL STEEL STL STOR STORAGE SUSPENDED SUSP TELEPHONE TEL

TEMPORARY TOW TOP OF WALL TYP TYPICAL UNO UNLESS NOTED OTHERWISE **VERT** VERTICAL VIF **VERIFY IN FIELD** WATER HEATER WD

0 HOUR RATED

WOOD

FIRE RATING DATA

IN ACCORDANCE TO TABLE R302.1(2) OF THE 2017 IRC

EXTERIOR WALLS FIRE-RESISTANCE RATED: 1 HOUR EXTERIOR WALLS NOT FIRE-RESISTANCE RATED: 0 HOUR

1 HOUR ON THE UNDERSIDE EXTERIOR PROJECTIONS FIRE-RESISTANCE RATED: EXTERIOR PROJECTIONS NOT FIRE-RESISTANCE RATED: 0 HOUR

OPENINGS IN WALLS NOT ALLOWED: OPENINGS IN WALLS UNLIMITED:

PENETRATIONS: COMPLY W/ R302.4 FROM IRC

PROJECT TEAM

STEPHEN D. BUNCH 906 Westminster Street NE Washington, DC 20001 (617) 821-9095 | sdbunc@gmail.com

ARCHITECTURAL DESIGNER RICARDO GUISSE 400 Galloway Street NE, 441S Washington, DC 20011 (202) 386-8734 | ricardo@studioguisse.com

STRUCTURAL ENGINEER OM SHARMA 3D STRUCUTRAL ENGINEERS 4903 Auburn Avenue, Suite 204 Bethesda, MD 20814 (301) 986-8458 | om@3dsengineers.com

BUILDING CODE SUMMARY

JURISDICTIONAL AUTHORITY

DISTRICT OF COLUMBIA

Washington, DC 20024

1100 4th Street SW

(202) 442-4400


Department of Buildings

APPLICABLE CODES

2015 INTERNATIONAL RESIDENTIAL CODE

2017 DISTRICT OF COLUMBIA BUILDING CODE THE DISTRICT OF COLUMBIA CONSTRUCTION CODES SUPPLEMENT OF 2017 ADOPTS AND AMENDS THE FOLLOWING CODES:

VICINITY MAP

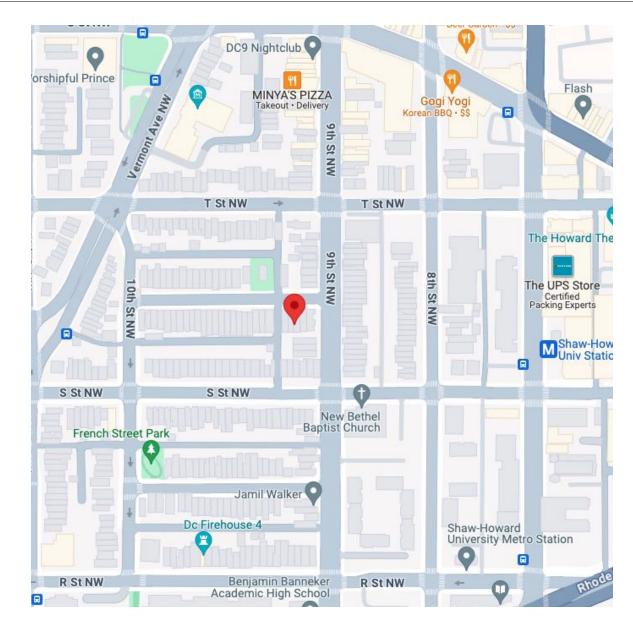

60% LOT OCCUPANCY (%) NO ALTERATION FRONT STEPS AREA (SQ. FT.) UNCOVERED STAIRS/LANDING AREA AT ROOF (SQ.FT.) UNCOVERED STAIRS/LANDING AREA AT ROOF OCC. (%) COMBINED LOT OCCUPANCY (%) N/A

PROJECT DATA

DCMR TITLE 11 - ZONING REGULATIONS

EXISTING HOUSE

928.3

SQUARE 0362, LOT 0276

SINGLE-FAMILY RESIDENCE

1416

35'0"

849.6

EXIST. FRONT

EXIST.

2 STORY BRICK

+ BSMT.

W/ NEW

ROOFDECK

LOT 276

1416 S.F.

EXIST. PATIO

PUBLIC ALLEY

LOT 275

REQUIRED

APPLICABLE CODE

PROPERTY ID

PROPOSED USE

LOT AREA (SQ. FT.)

BUILDING HEIGHT

STORIES ABOVE GRADE

BUILDING AREA (SQ. FT.)

SCOPE OF WORK

SITE PLAN

EXIST. HOUSE

(NO CHANGE).

UNCOVERED

2ND STORY TO **NEW ROOF**

STAIRS FROM

DECK.

New deck on existing roof

ARCHITECTURE + DESIGN

Ricardo Guisse | 202.386.8734

WESTMINSTER STREET NE

ROOF CANOPY

NEW ROOF DECK

AREA OF ROOF NEW DECK CONFINED WITHIN EXIST. ROOF

BOUNDARIES.

OUTLINE OF EXIST.

GROUND FLOOR.

LANDING AND

SETBACK.

PROPOSED ROOFDECK

NO CHANGE

NO CHANGE

48%

N/A

57.4

RESIDENC

BUNCH

PROJECT Project ID: 2311 Designer : **RG** Supervisor : OS

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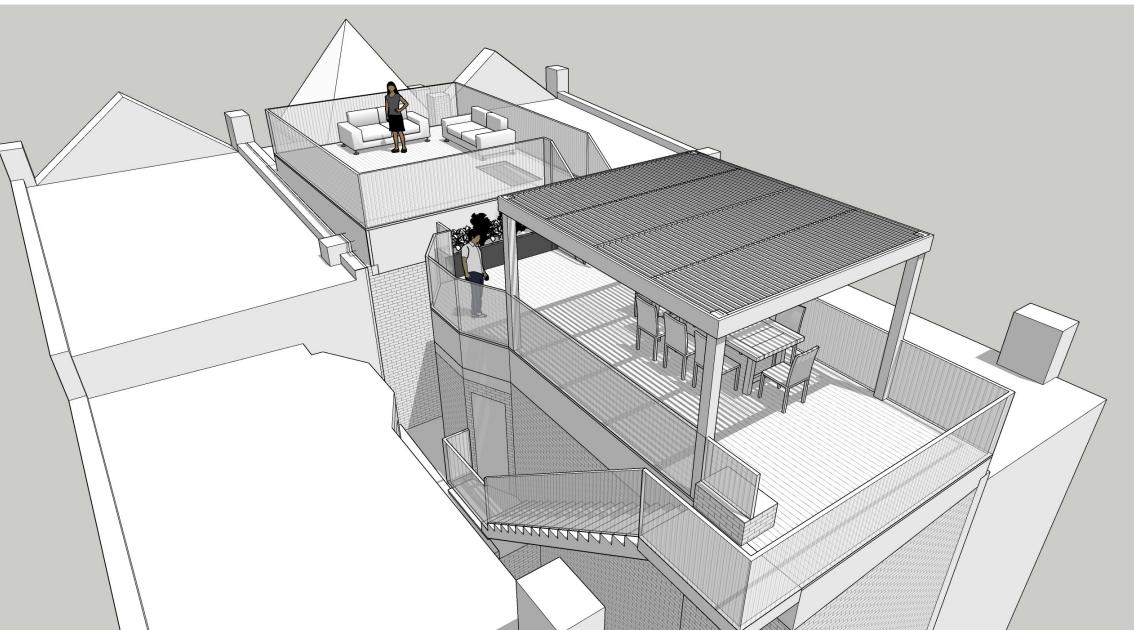
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SHEET TITLE

PROJECT SUMMARY

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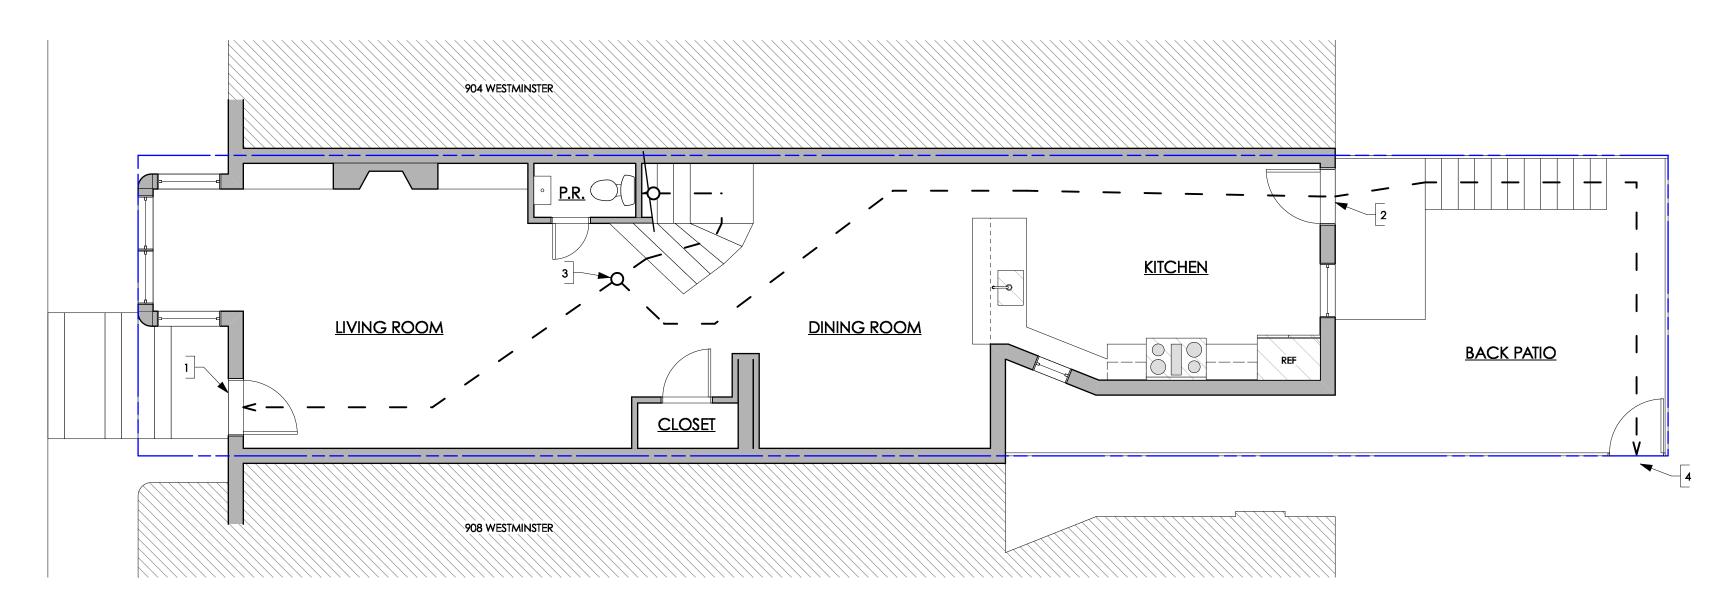
PERSPECTIVE (CONCEPTUAL)




DETAIL MARKER ELEVATION MARKER SECTION MARKER 100'-0" T.O.S. **ELEVATION DATUM NORTH ARROW** DOOR NUMBER $\langle w-x \rangle$ WINDOW NUMBER KEYNOTE

REVISION NUMBER






FIRST FLOOR PLAN - EGRESS
Scale: 1/4"=1'-0"

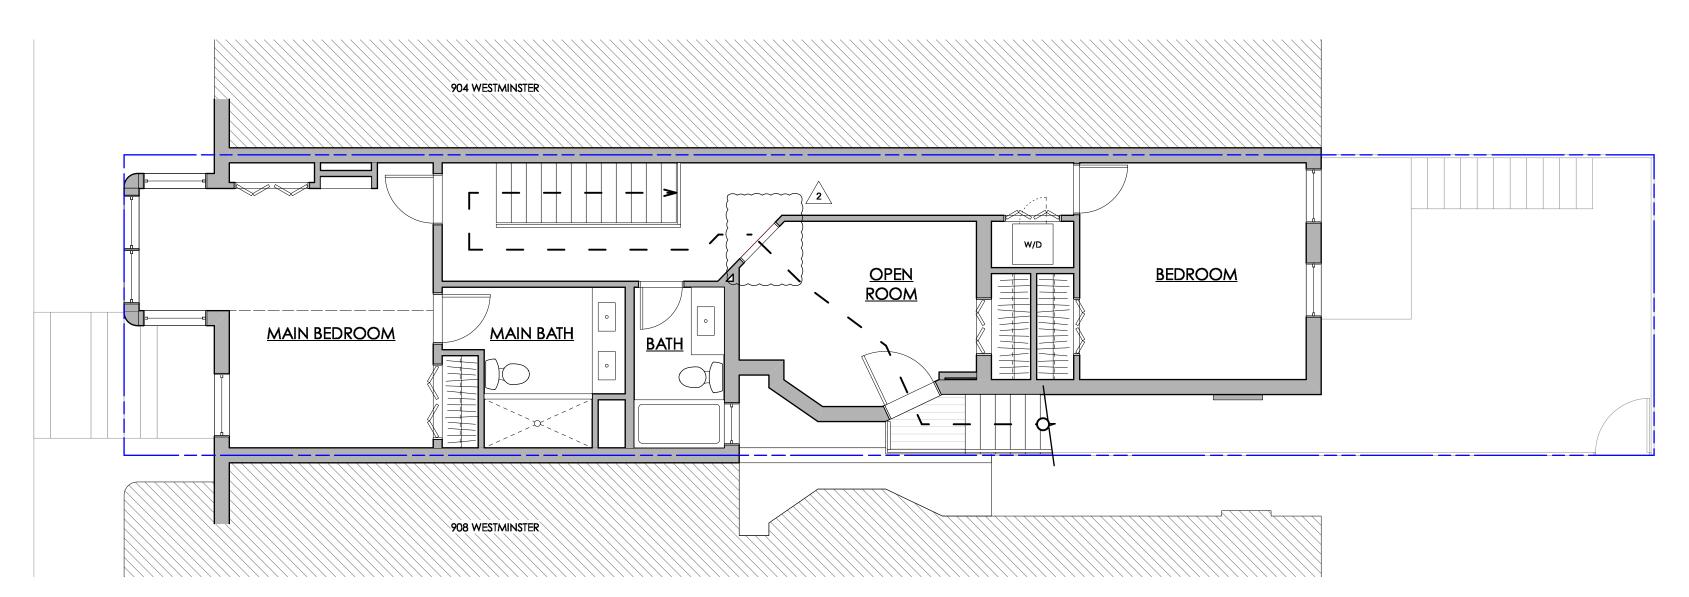

2 SECOND FLOOR PLAN - EGRESS
Scale: 1/4"=1'-0"

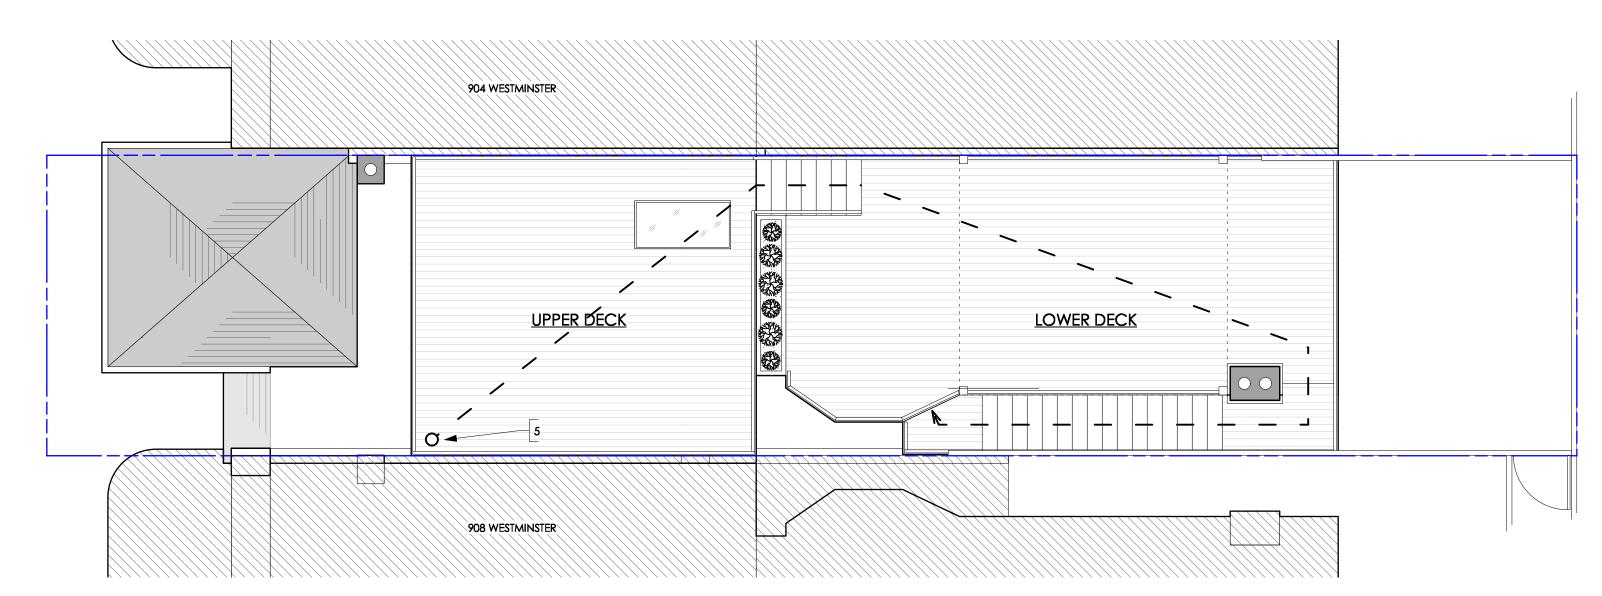

ROOF PLAN - EGRESS Scale: 1/4"=1'-0"

LEGEND

ADJ. PROPERTY EXISTING WALL — PATH OF EGRESS - REMOTE / DECISION POINT

— DIRECTION OF EGRESS

KEYNOTES


- EXISTING FRONT DOOR.
- 2. EXISTING REAR DOOR. 3. DECISION POINT AT BOTTOM OF MAIN STAIRS.
- EXIT TO ALLEYWAY.
- 5. MOST REMOTE POINT AT UPPER DECK.



BUNCH RESIDENCE 906 Westminster St NW

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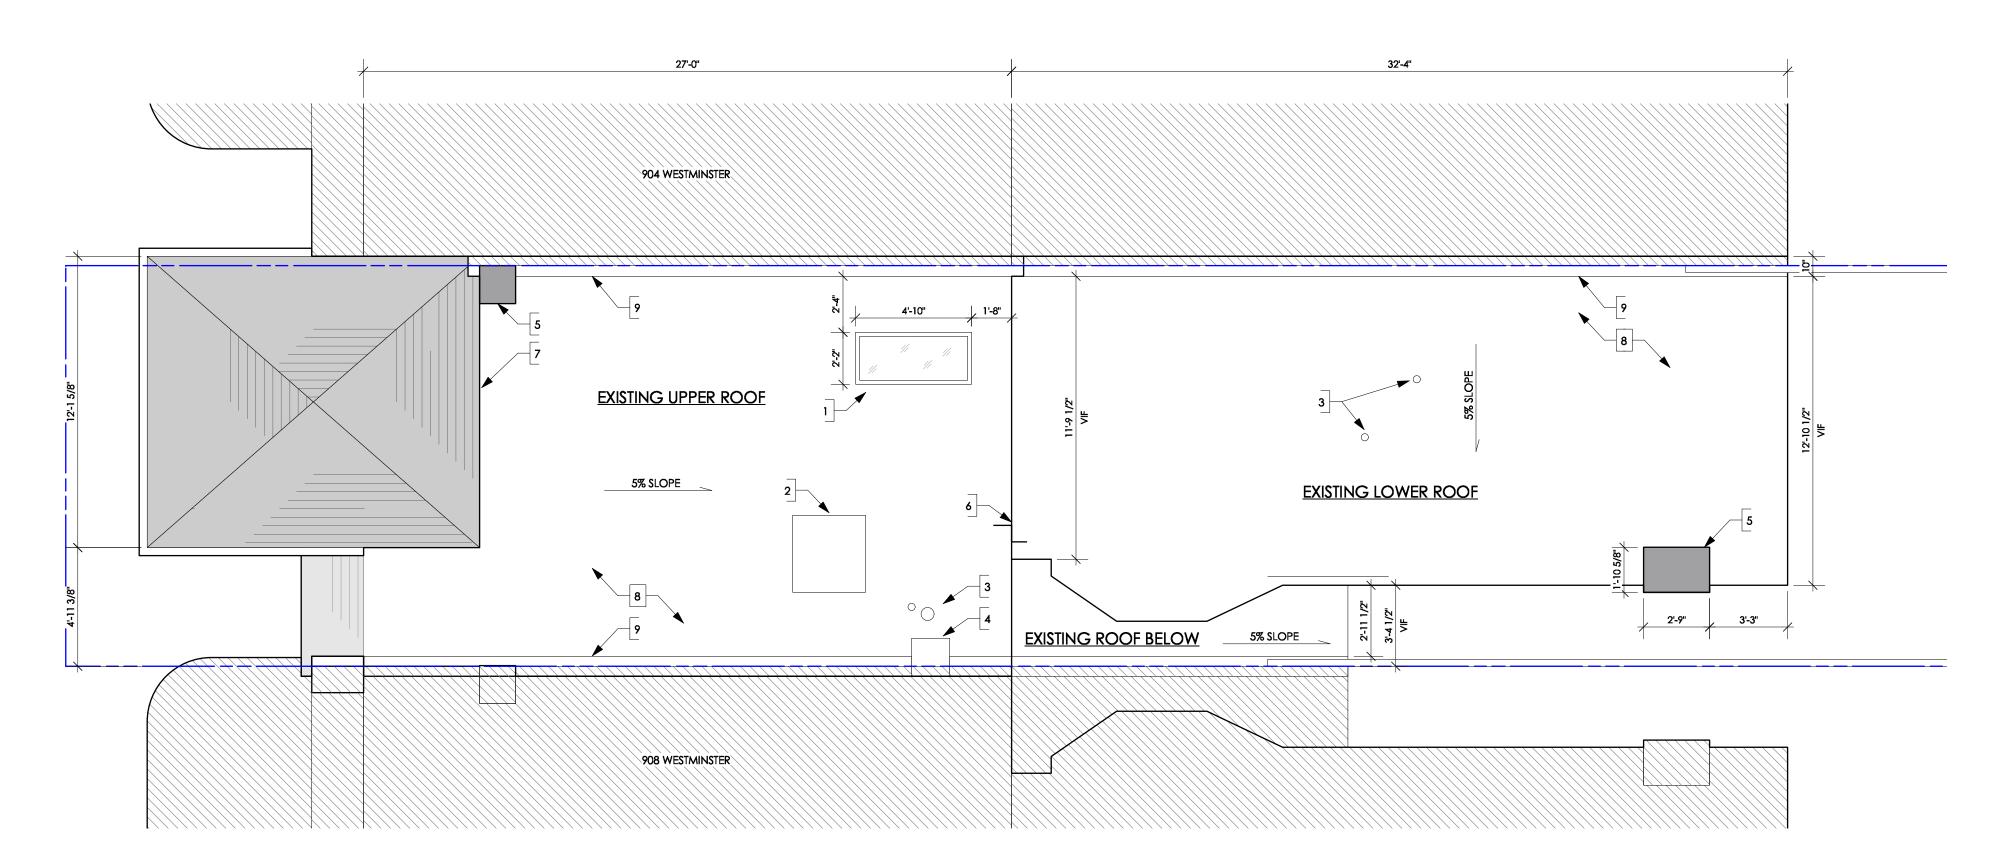
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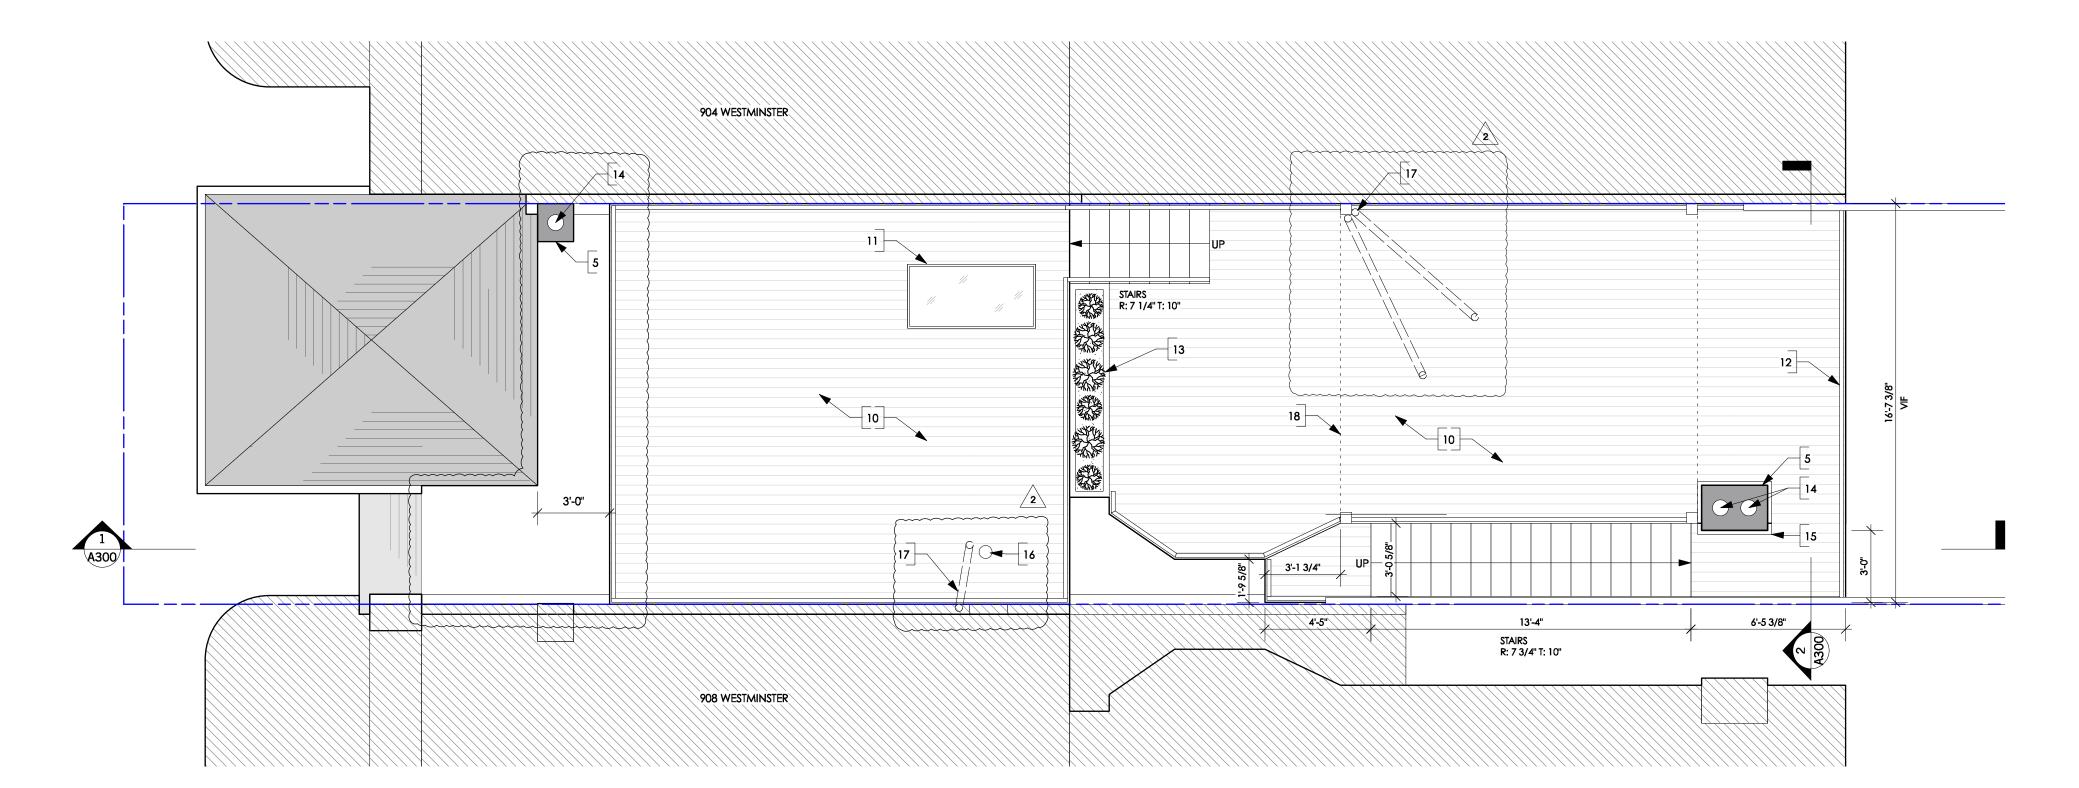
EGRESS PLANS

SHEET NUMBER

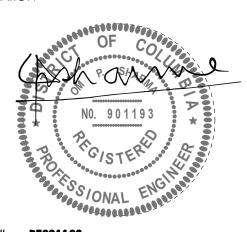







PROPOSED ROOF DECK PLAN

Scale: 1/4"=1'-0"

LEGEND

DEMO WALL

ADJ. PROPERTY

EXISTING WALL

NEW WALL

GENERAL FLOOR PLAN NOTES

- A. ALL NEW DIMENSIONS ARE FROM FINISH SURFACE TO FINISH SURFACE, UNLESS OTHERWISE NOTED. DIMENSIONS THAT REFERENCE EXISTING CONSTRUCTION ARE TO FACE OF EXISTING FINISH OR COLUMN CENTERLINE UNLESS NOTED OTHERWISE.
- B. ANY DAMAGE TO THE NEW OR EXISTING CONSTRUCTION CAUSED BY THE GENERAL CONTRACTOR'S NEGLIGENCE, INADEQUATE PROTECTION, OR INADEQUATE SECURITY MEASURES DURING CONSTRUCTION ARE TO BE CORRECTED AT THE GENERAL CONTRACTOR'S EXPENSE.
- C. DO NOT SCALE THE DRAWINGS. ANY DIMENSIONAL DISCREPANCIES SHALL BE BROUGHT TO THE ATTENTION OF THE DESIGNER/ARCHITECT FOR CLARIFICATION PRIOR TO COMMENCING WORK.
- D. GENERAL CONTRACTOR TO PATCH AND REPAIR ALL SURFACES TO MATCH ADJACENT SURFACES IN A MANNER SUITABLE TO RECEIVE FINISHES
- FINISHES.

 E. GENERAL CONTRACTOR TO PROVIDE PRICING TO PREP & PAINT ANY WALLS OR CEILING SPACES NOT SPECIFIED FOR NEW FINISHES; AND TO PROVIDE PRICING TO PREP SLAB AND INSTALL NEW TILE ON ANY
- FLOOR SPACES NOT SPECIFIED FOR NEW FINISHES.

 F. GENERAL CONTRACTOR TO VERIFY EXTENT OF EXISTING
 CONSTRUCTION IN FIELD, AND SHALL IMMEDIATELY NOTIFY THE
 DESIGNER/ARCHITECT OF ANY "AS-BUILT" CONDITIONS CONTRARY TO
 THOSE SHOWN OR INFERRED FROM THE CONSTRUCTION DOCUMENTS,
- PRIOR TO COMMENCEMENT OF WORK.

 G. PRIOR TO COMMENCEMENT OF CONSTRUCTION, THE GC SHALL PROVIDE "CHALK LINE" LAYOUT OF THE FOLLOWING ITEMS FOR THE ARCHITECT'S ON-SITE APPROVAL: PARTITION LAY-OUT, WITH DOOR AND DOOR SWING LOCATIONS; OUTLET AND TELEDATA LOCATIONS; SWITCH AND SWITCH BANK LOCATIONS; TRANSFORMER, PANEL, AND SUPPLEMENTAL MECHANICAL EQUIPMENT LOCATIONS; CEILING SOFFIT LOCATIONS; MOVABLE PARTITION TRACK LAYOUTS; VAV BOXES AND LIGHTING LAYOUTS.
- H. PROVIDE FIRE TREATED WOOD BLOCKING OR METAL BLOCKING IN WALLS AS REQUIRED FOR SECURE INSTALLATION OF ALL MILLWORK, DOORS, WINDOWS, AND ACCESSORIES. REFER TO MANUFACTURER'S INSTALLATION INSTRUCTIONS FOR SPECIFIC BLOCKING REQUIREMENTS.

KEYNOTES

- 1. EXISTING SKYLIGHT.
- EXISTING ROOF ACCESS.
 EXISTING STACK.
- 4. EXISTING SEALED, NON OPERATIONAL, FORMER CHIMNEY.
- 5. EXISTING CHIMNEY.6. ROOF ELEVATION CHANGE.
- ROOF ELEVATION CHANG
 EXISTING GABLE.
- 8. EXISTING WATERPROOFING TO REMAIN.
- 9. ADJ. PARAPET 10" (TYP.)
- 10. NEW DECK (LEVELED)
- 11. NEW TEMPERED GLASS. FLUSH W/ DECK.12. NEW RAILING SURROUNDING DECK. (36" H).
- 13. NEW PLANTER.
- 14. OPERATIONAL CHIMNEY FLUE TO BE EXTENDED A MIN. OF 2'-0"
- 15. ALLOW 2" AIRSPACE TO COMBUSTIBLE FRAMING MEMBER.
- 16. EXISTING HVAC VENT EXHAUST TERMINATION THROUGH ROOF PER M1804.2.1.
- 17. EXTEND AND REROUTE VENT STACK TO A MIN. OF 7' ABOVE DECK.

 18. NEW PERGOLA ON 6X6 POSTS, W/ 2X4 LOUVERS @ 4" O.C., ON 2X10



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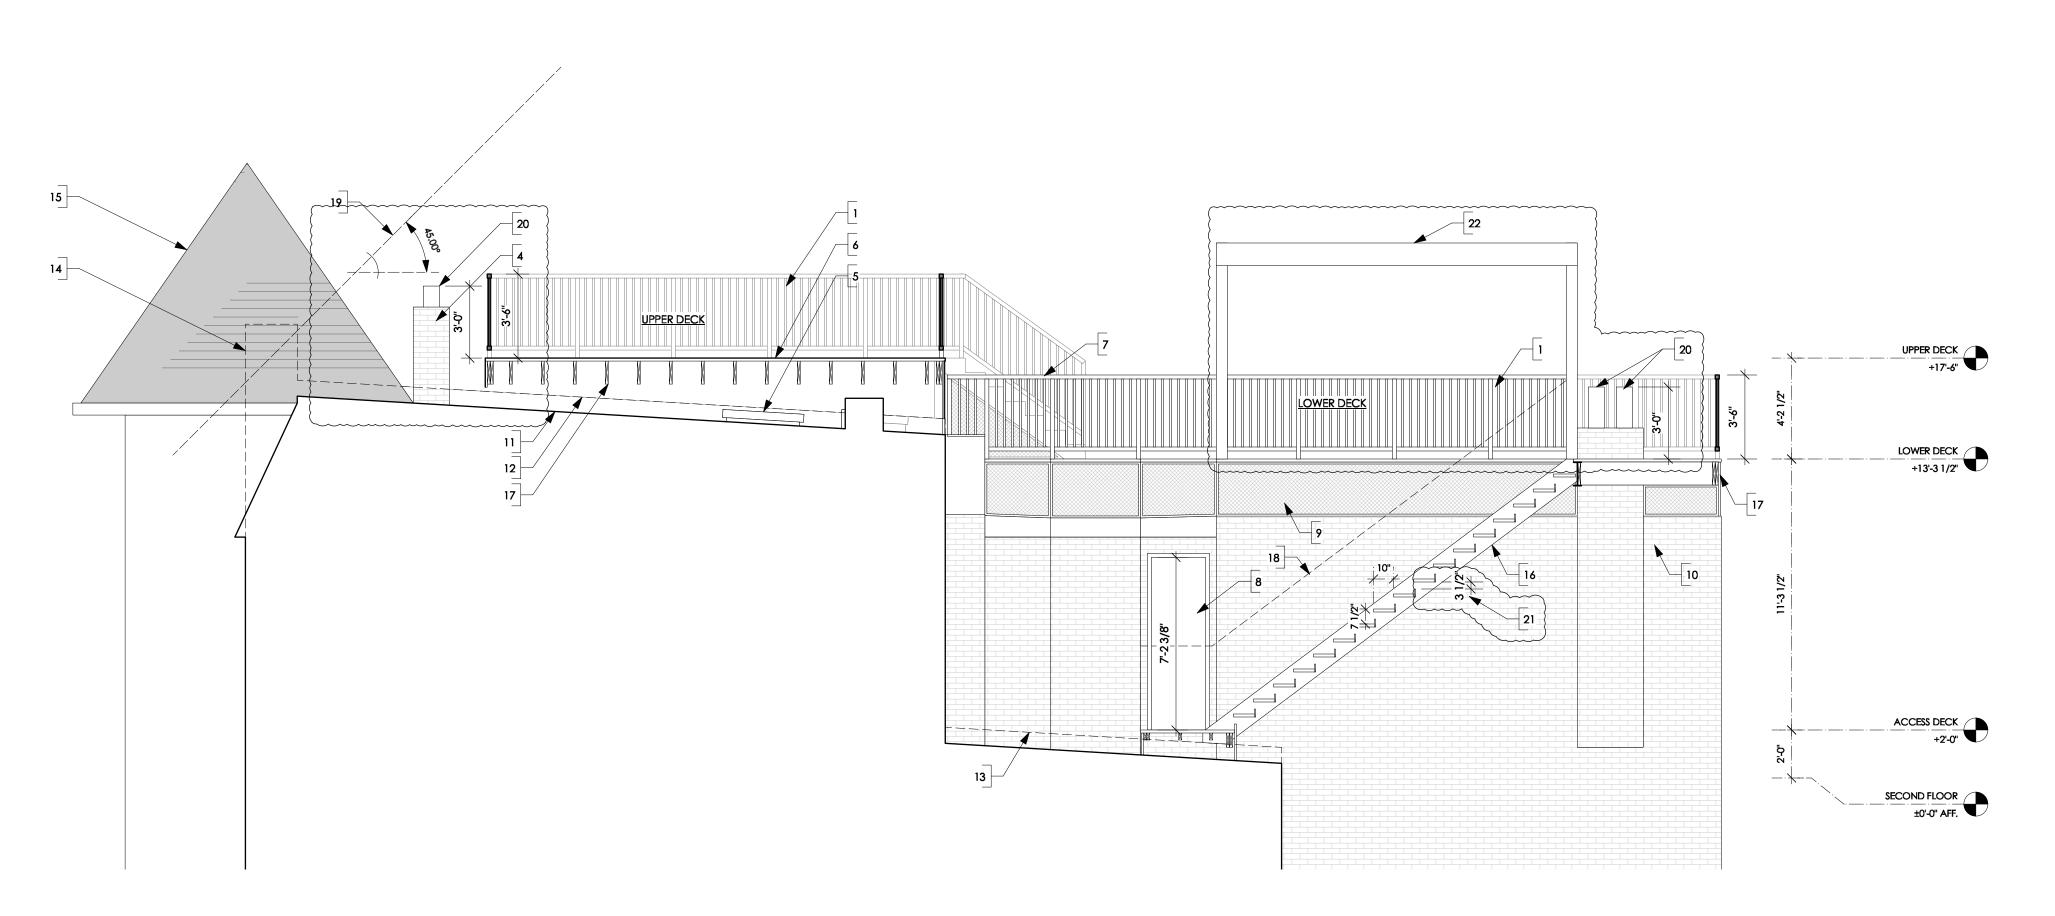
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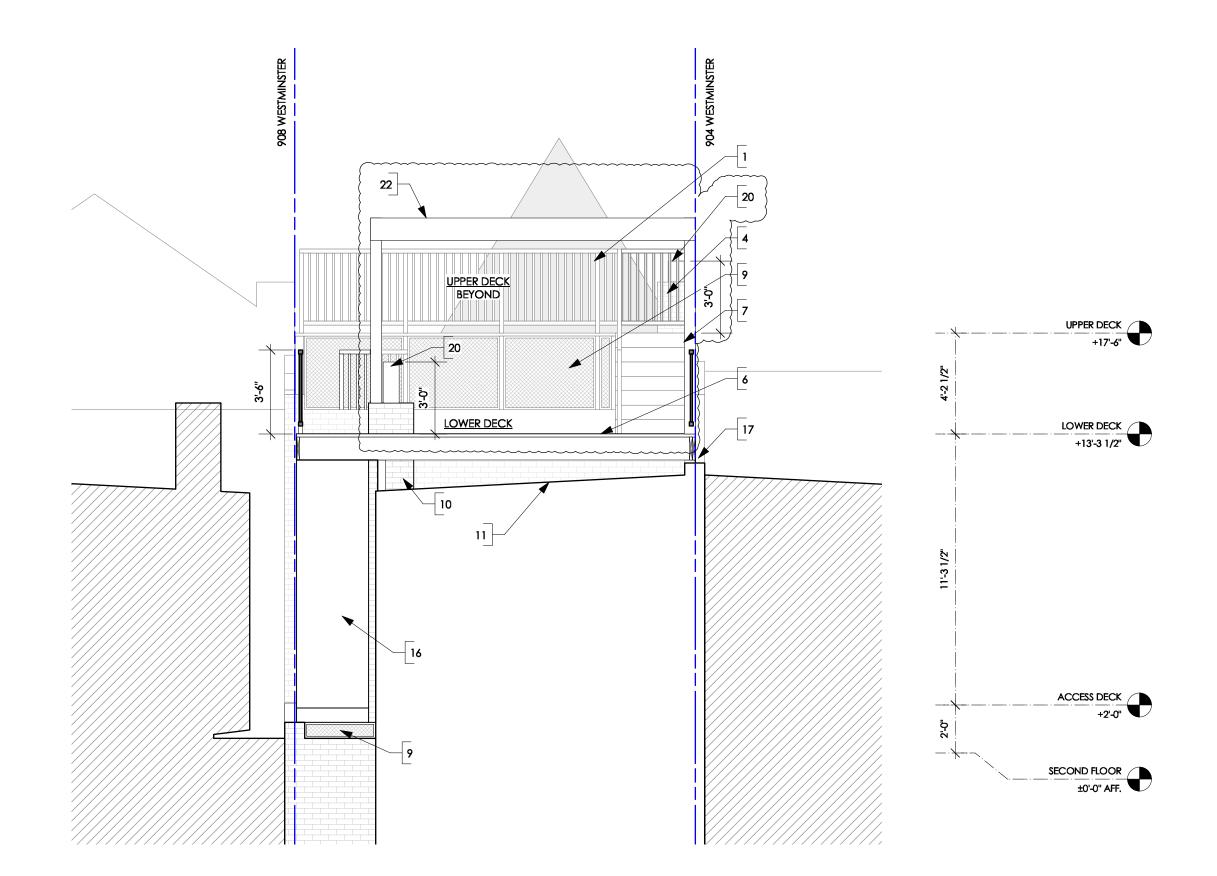
SHEET NUMBER

A100

PLANS



SECTION @ STAIRS
Scale: 1/4"=1'-0"



SECTION @ STAIRS
Scale: 1/4"=1'-0"

LEGEND

GRADE / SOIL SECTION PROFILE


GENERAL SECTION NOTES

- 1. ALL METAL ELEMENTS SHALL BE PAINTED W/ ANTI-RUST BASED PAINT.
- ALL EXTERIOR WOOD MATERIALS SHALL BE TREATED AND SEALED W/ PROPER COATING OF CLEAR MATTE SEALANT.
- 3. REFER TO STRUCUTRAL DRAWINGS FOR TRUSS FRAMING.

KEYNOTES

1. NEW RAILING SURROUNDING DECK. (36" H).


- (2. N/A) (3. N/A)
- 4. EXISTING CHIMNEY BEYOND.
- 5. EXISTING ROOF ACCESS.
- 6. NEW DECK (LEVELED). SEE STRUCTURAL DWGS. STAIRS BEYOND.
- 8. NEW DOOR ACCESS USING EXIST, WINDOW CASING.
- 9. DECORATIVE LATICE TO COVER DECK STRUCTURE.
- 10. EXISTING CHIMNEY.
- 11. EXISTING SLOPPED ROOF (5%). WATERPROOFING TO REMAIN.
- 12. EXISTING PARAPET BEYOND.
- 13. PARAPET UP FRONT. 14. ADJ. CHIMNEY UP FRONT.
- 15. EXISTING GABLE TO REMAIN.
- 16. NEW STAIR, STRUCTURE TO BE BRACED AT CANTILEVERED BEAM. 17. DECK STRUCTURE TO SPAN OVER EXIST. PARAPET.
- 18. OUTLINE OF RAILING UP FRONT.
- 19. VISUAL DEFINITION FROM STREET. 20. OPERATIONAL CHIMNEY FLUE TO BE EXTENDED A MIN. OF 2'-0"
- 21. SPACE BETWEEN TREADS AS SHOWN (NOT TO EXCEED 4").
- 22. NEW PERGOLA ON 6X6 POSTS, W/ 2X4 LOUVERS @ 4" O.C., ON 2X10 RAFTERS.

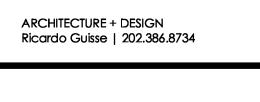

BUNCH RESIDENCE

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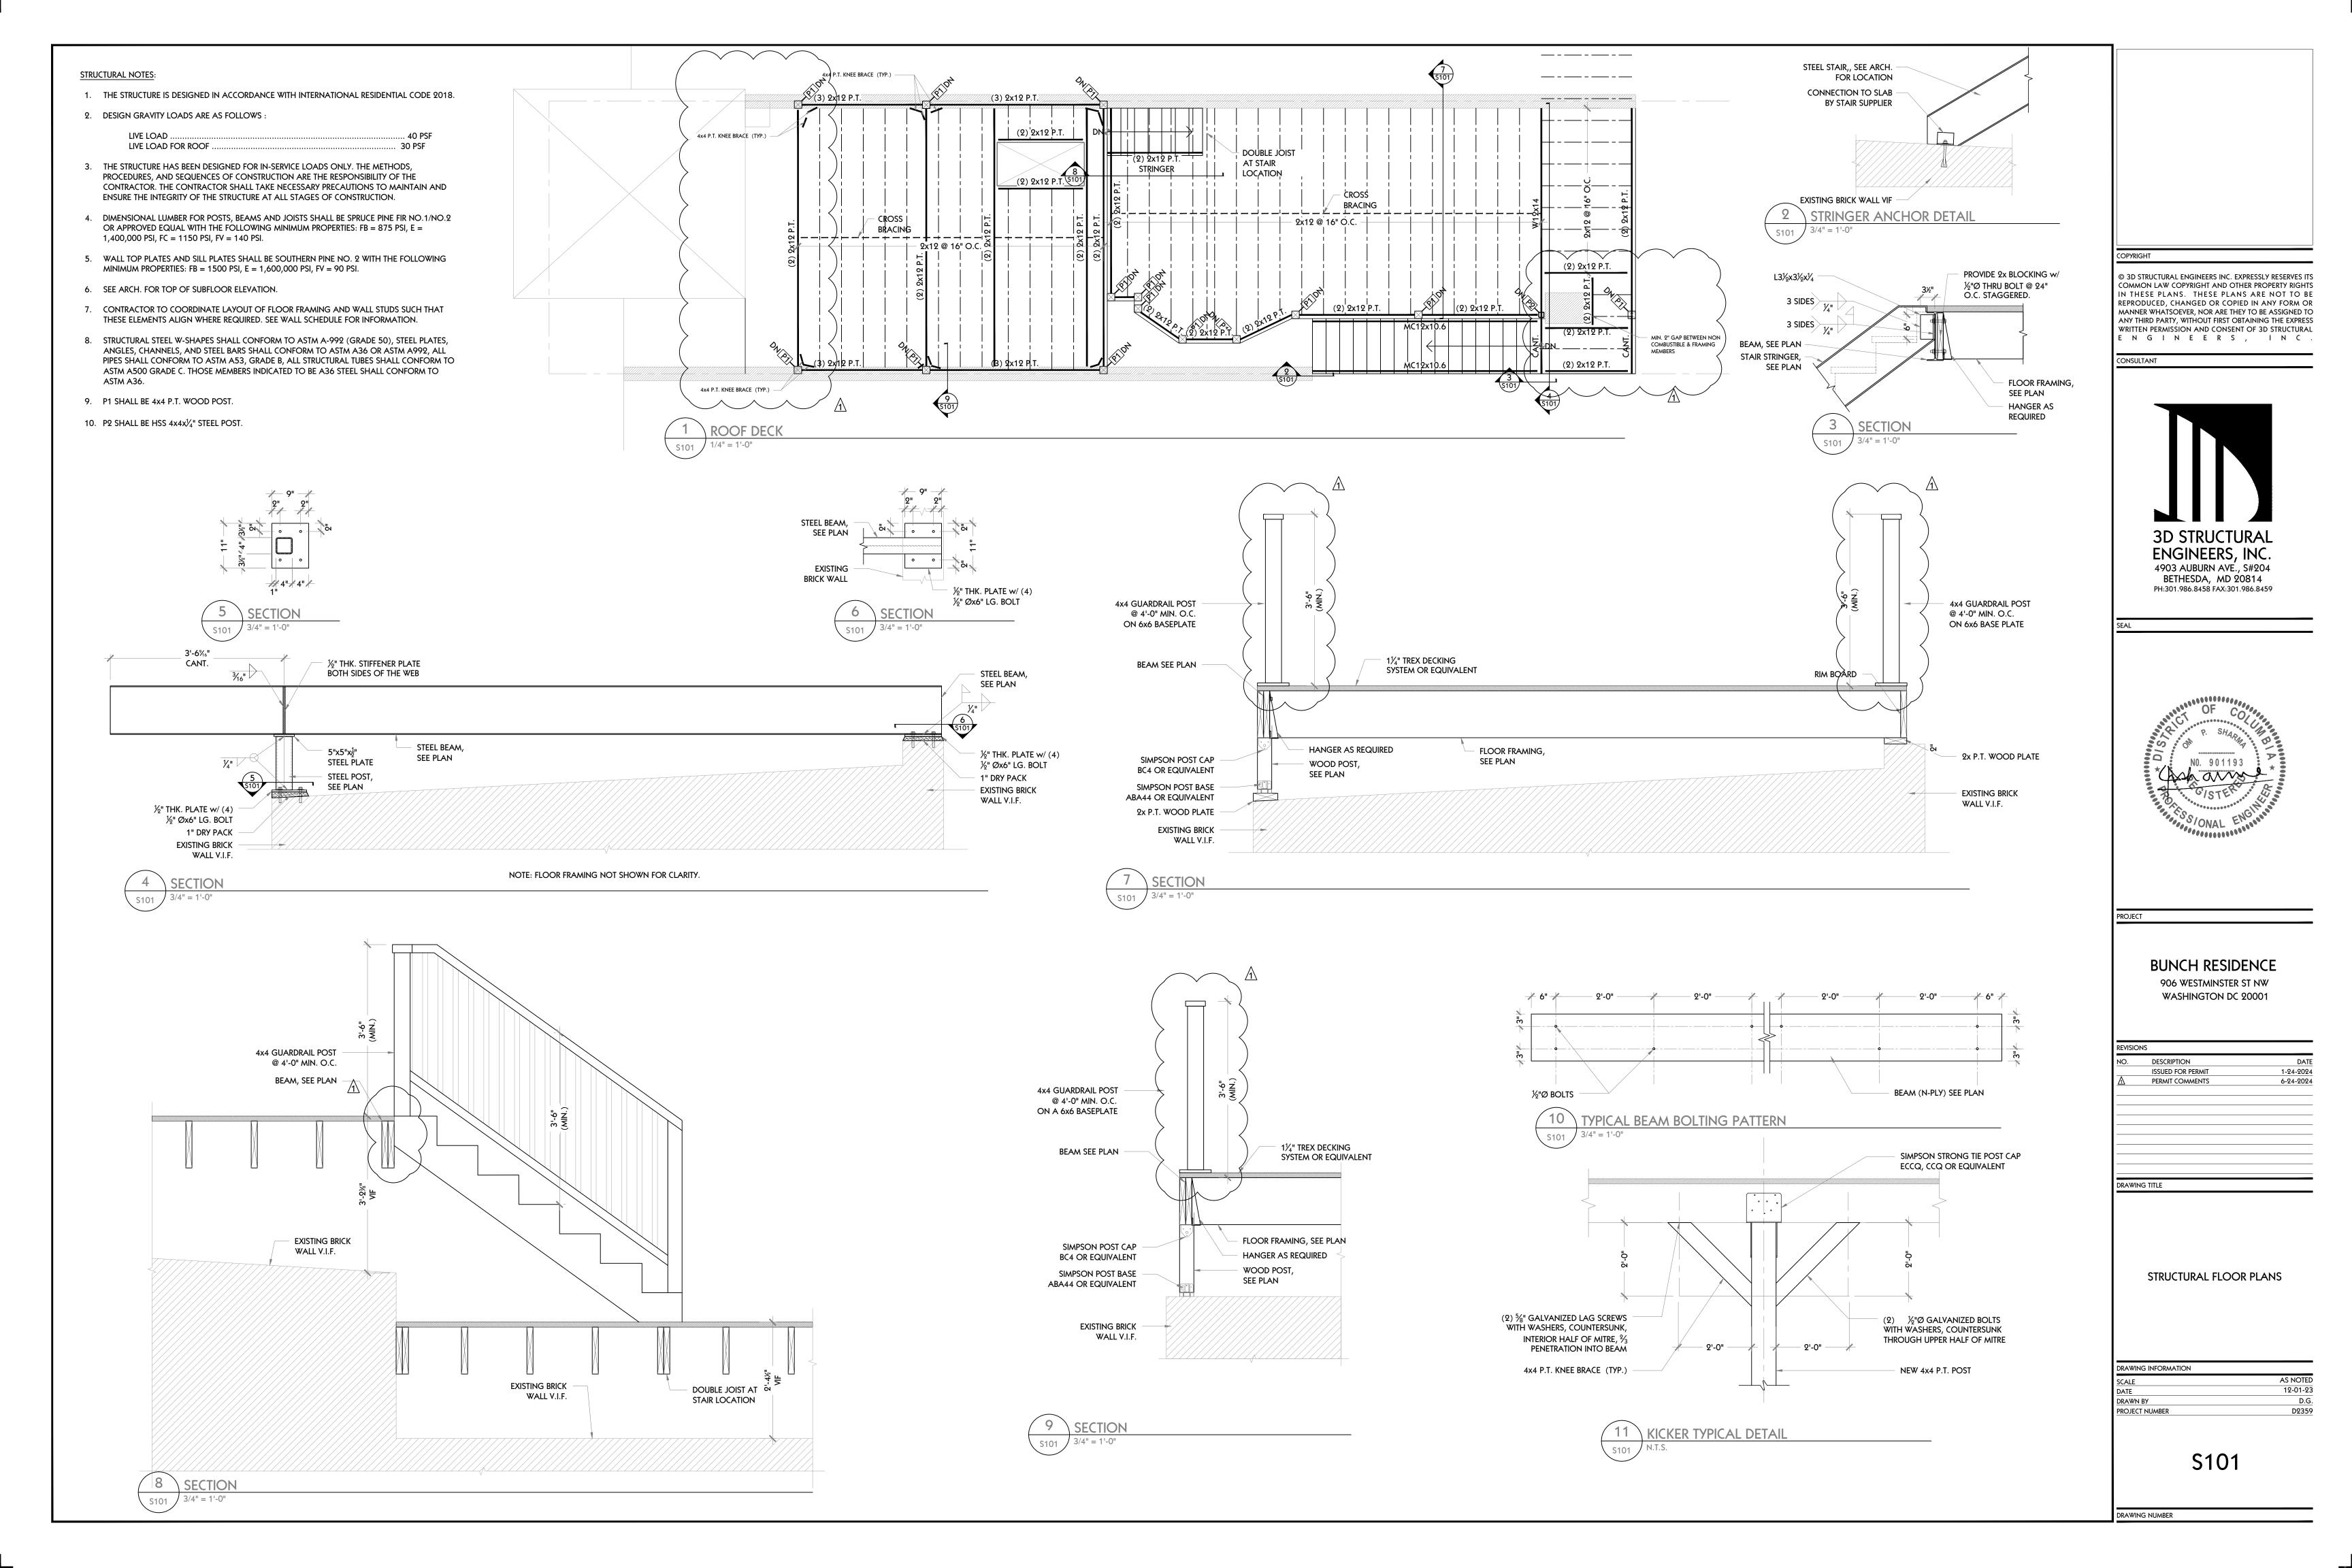
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SHEET TITLE

SECTION

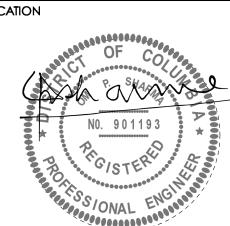SHEET NUMBER



Special Inspection Policy Manual

SCHEDULE OF SPECIAL INSPECTIONS

Address:

MATERIAL/ACTIVITY TYPE OF INSPECTION				APPLICABLE TO THIS PROJECT	4	
MAIERIAL/ACTIVITY	ITPE OF INSPECTION	Y/ N	C/I	P EXTENT/REFERENCE	AGENT	COMPLETED
GENERAL		to de e				<u> </u>
Pre-construction conference	Meeting with parties listed in Section 6 of DOB SIPM to discuss Special Inspection procedures	Υ	Р	Scheduled by Stevenson Consulting Inc. "special Inspection Agency Record" on behalf of DCRA Prior Commencement of work	SIER	TBD
EARTHWORK						
Site preparation (building)	Field testing and inspection	N	Р	Field Review; IBC 1705.6		
Fill material (building)	Review submittals, field testing and inspection	N	Р	Field Review; IBC 1705.6		
Fill compaction (building)	In-place density tests, lift thickness	N	С	Field Review; IBC 1705.6		
Excavation	Field inspection and verification of proper depth	N	Р	Field Review; IBC 1705.6		
Foundation sub-grade	Field inspection of foundation subgrade prior to placement of concrete	N	Р	Field Review; IBC 1705.6		
Sheeting and shoring	H piles and lagging, tie backs,	N	С	IBC 1705.2,1705.7, 1705.8 T1705.7		
DEEP FOUNDATION ELEMENTS						
Materials	Review product, sizes, and lengths	N	С	Submittal and Field Review; IBC 1705.7, 1705.8, 1705.9		
Test piles	Monitor driving of test piles	N	С	Field Review; IBC 1705.8, .9 or .10		
Installation	Monitor drilling, placement, plumb, driving of piles, including recording blows per foot, cut off, and tip elevation	N	С	Field Review; IBC 1705.2, 1705.3, 1705.7		
Load test	Monitor pile load test	N	С	Field Review; IBC 1705.8, .9 or .10		
Helical Piles	Continuous special inspections shall be performed during installation of helical pile foundations	N	С	IBC 1705.9, 1810.3.1, 1810.4.11		
CONCRETE						
Materials	Review product supplied versus certificates of compliance and mix design	N	Р	Submittal & Field Review; IBC 1705.3; ACI 318:Ch. 4 and 5; IBC 1904.2, 1910.2, 1903.3		
Installation of reinforcing steel, including Pre-stressed tendons and anchor bolts as well as welding	Field inspection of placement	N	Р	Submittal and Field Review; ACI 318:3.5, 3.5.2, 3.8.6 & Ch. 7 8.1.3 and 21.2.8; AWS D1.4; IBC 1705.3, 1908.5, 1909.1, 1910.4		
Formwork installation	Field inspection	N	Р	Field Review; ACI 318: 6.1.1; IBC 1705.3		
Concreting operations and placement	Field inspection of placement/sampling	N	С	Field Review; ACI 318: 5.6, 5.8, 5.9-10; ASTM C 172, C 31; IBC 1705.3, 1910.6, 1910.7, 1910.8, 1910.10		

Special Inspection Policy Manual

Concrete curing	Field inspection of curing process	N	Р	Field Review; ACI 318: 5.11-13; IBC 1705.3, 1910.9	
Concrete strength	Evaluation of concrete strength	N	Р	Laboratory Testing; ACI 318: 6.2; IBC 1705.3	
Inspect anchors post-installed in hardened concrete members	IBC TABLE 1705.3	N	С	ACI 318: 17.8.2.4	
PRECAST CONCRETE					
Verify fabrication/quality control procedures	In-plant inspection of fabrication/quality control procedures**	N	Р	Submittal or Field Review; IBC 1705.3	
Erection and installation	Review submittals and as-built assemblies; Field inspection of in-place precast	N	Р	Submittal and Field Review; ACI 318; Ch. 16; IBC Table 1705.3	
MASONRY (Level; Building Risk	k Category_) TYPICAL FOR LEVEL B AND I	RIS	CA	TEGORY I,II,III	
Materials	Review of products supplied versus certificate of compliance and material submitted	N	Р	Submittal & Field Review; ACI 530/ASCE 5; ACI 530.1/ASCE 6; IBC 1705.4, 1708	
Strength	Testing/review of strength	N	С	530.1/ASCE 6; IBC 1705.4, 2105.2.2, 2105.3	
Mortar and Grout	Inspection of proportioning and mixing. Placement of mortar only.	N	Р	Field Review; IBC 1705.4; ACI 530/ASCE 5; ACI 530.1/ASCE 6	
Grout placement, including pre-stressing grout	Verification to ensure compliance	N	С	Field Review; IBC 1705.4; ACI 530/ASCE 5; ACI 530.1/ASCE 6	
Grout space	Verification to ensure compliance	N	Р	Field Review; IBC 1705.4; ACI 530/ASCE 5; ACI 530.1/ASCE 6; TMS 602	
Mortar, grout, and prism specimens	Observe Preparation	N	С	Field Review; IBC 1704.5, ACI 530.1; ASCE 6	
Reinforcement, pre-stressing tendons, and connections	Inspect condition, size, location, and spacing	N	Р	Field Review; IBC 1704.5; ACI 530/ASCE 5; ACI 530.1/ASCE 6	
Welding of reinforcing bars	Inspection and testing of welds	N	С	Field Review; IBC 1705.4; ACI 530/ASCE 5; ACI530.1/ ASCE 6	
Pre-stressing force	Verify application and measurement	N	С	ACI530.1/ASCE 6	
Protection	Inspect procedures for protection during cold and hot weather	N	Р	Field Review; IBC 1705.4; ACI 530/ASCE 5;ACI 530.1/ASCE 6	
Anchorage	Inspection of anchorages	N	P	Field Review; ACI 530.1/ASCE 6, ASCE 6; IBC1705.4; ACI 530/ASCE 5	
Masonry installation	Inspection of placement of masonry and joints (Periodic after the first 5000 SF.)	N	С	Field Review; ACI 530/ASCE 5; ACI 530.1/ASCE6; IBC 1705.4	
Grouting of pre-stressed tendons	Field inspection	N	С	Field Review; ACI 318: 18.18.4; IBC 1705.3	
Application of forces for pre-stressed concrete	Field inspection	N	С	Field Review; ACI 318: 18.20; IBC 1705.3	
STRUCTURAL STEEL		Y/N	C/	P	
Verify fabrication/quality control procedures	In-plant inspection of fabrication/quality control procedures or submit Certificate of Compliance	N	Р	IBC 1704.2.5, IBC 1704.2.5.1, 1704.2.5.2, 1705.2	
Bolts, nuts, and washers – materials	Material identification markings. Review of Certificate of Compliance	N	Р	Submittal & Field Review; IBC 1705.2.1; IBC 1705.2.2; IBC 1706; ASTM; AISC 360, Section A3.3	

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Bolts, nuts, washers – installation	Inspection of in-place high-strength bolts,		С	Submittal & Field Review; IBC 1705.2.1,		
BOTTS, FIOTS, WASHETS – ITISTALIATION	snug- tight joints, pre-tensioned and bearing type, and slip critical connections	Y	C	1705.2.2, AISC 360 Section M2.5	SIER	
Structural steel – materials	Material identification markings and review of Certificate of Compliance	N	Р	Submittal & Field Review; IBC 705.2.1,1705.2.2, 1706; ASTM A6, A568		
Structural steel details – installation	Inspection of member locations, structural details for bracing, connections, stiffening	Y	Р	Submittal & Field Review; IBC 1705.2.1,1705.2.2, AISC 360	SIER	
Weld filler materials and welder certification	Review of identification markings, Certificate of Compliance, and welder certifications	N	Р	Submittal & Field Review; ASTM AISC 360 A3.5		
Welds	Inspection and testing of welds	Y	С	Field Review; IBC 1705.2.2.1; AWS D1.1, D1.3	SIER	
Cold-formed metal deck – materials	Review of identification marking manufacturer's certified test results	N	Р	Submittal and Field Review; IBC 1705.2.2; ASTM		
Cold-formed metal deck – installation	Review laps and welds	N	Р	Submittal and Field Review; IBC 1705.2.2, AWS D1.3		
Cold-formed light frame construction – welds	Review welding operation	N	Р	IBC 1705.11.2		
Cold form light frame construction wind resistance – screws	Review screw attachment bolting, anchoring hold downs, bracing, diaphragms, struts	N	Р	Field Review; IBC 1705.11.2		
Cold-formed steel trusses spanning 60' or greater	Inspection of temporary and permanent restraints/bracing	N	С	Field review IBC 1705.2.4		
WOOD						
Verify fabrication/quality control procedures	In-plant inspection of fabrication/quality control procedures** or submit Certificate of Compliance	N	Р	Submittal or Field Review; IBC 1704.2.5, 1705.5, 1705.5.2		
Metal plate connected wood/metal trusses spanning 60' or more	Review approved submittal and installation of restraint/bracing	N	Р	Field Review; IBC 1704.2.5, 1705.5, 1705.2		
Joist Hangers – Materials/Installation	Review manufacturer's material and test standards	N	Р	Field Review; IBC 1711, ASTM D 1761		
High-Load Diaphragms – Installation	Review submittal and as-built assemblies; inspection of sheathing, framing size, nail and staple diameter and length, number of fastener lines, and fastener spacing.	N	С	IBC 1705.5, 1705.5.1		
Wood Shear Walls-installation	Review nailing, bolting, anchoring, fastening, Diaphragms, struts, braces, and hold downs when fasteners are ≤ 4" on center.	N	Р	Field Review; IBC 1705.11.1		
MAIN WIND FORCE RESISTING SYST	EM	Y/N	C/F			
Wind requirements	Review of the system components and		Р	Submittal and Field Review; IBC 1609.1.2,		
	installation for wood construction, cold-formed steel light frame construction, components, and cladding	N		1704.5.2, 1705.111705, 1705.4, 1705.4.1, 1705.4.2, 1710		
SEISMIC FORCE RESISTING SYSTEMS	installation for wood construction, cold-formed steel light frame construction, components, and cladding	N				

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Special Inspection of smoke control	Leakage testing and recording of device		Р	Field Review; IBC ,1705.18 ,1705.18.1 1705.17.2		
systems	location. Pressure difference testing, flow measurement and detection, and control verification	N	'	1705.16.2		
SPRAYED FIRE RESISTIVE MATERIAL,	FIRE RESISTANT PENETRATIONS; JOINTS, MA	STIC	AN	ID INTUMESCENT FIRE RESISTANT COATING	;	
Structural member surface conditions	Field Review of surface conditions prior to application	N	Р	AWCI 12-B; IBC 1705.14 1705.14.2		
Application/thickness/density/bond strength	Field review of application operations, thickness, and density	N	Р	ASTM E605, AWCI 12-B; IBC 1705.14.3 1705.14.1, 1705.14.3, 1705.14.4IBC 1705.14.5 1705.14.6		
Mastic & Intumescent Fire Resistant Coating	Field review of application operations and thickness	N	Р	AWCI 12-B; IBC 1705.15		
Fire-resistant penetrations and joints. In nigh-rise buildings or in buildings assigned to Risk Category III or IV,	Field inspection per design	N	Р	IBC 1705.17.1, 1705.17.2, ASTM E2174.		
EXTERIOR INSULATION AND FINISH	SYSTEMS (EIFS)					
Application	Field Review of application/installation	N	Р	ASTM E2570, IBC 1705.16		
SPECIAL CASES						
Alternative Materials and Systems	As requested by Chief Building Official, review system and installation	N	C/ P	IBC 1705.1.1		
INSPECTION AGENTS	FIRM			ADDRESS	TELE	PHONE
Special Inspections Engineer of Record	Alsaddeeg Alzarough, P.E. Stevenson Consulting Ind	. 3	810	Concorde Parkway # 700	703-8	803-6411
Materials and Testing Laboratory	same as above		Char	ntilly VA 20151		
Special Inspections Engineer of Record Smoke Control System						
Additional Agents						

Note: The Qualifications of the Special Inspections Engineer of Record and Testing Laboratories are subject to the Approval of the Chief Building Official
The Schedule of Special Inspections includes certain Architectural, Mechanical, Electric components, Storage Racks and Isolation Systems specified in Section 1705.11 of
the Construction Code.

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CONSULTANT





PROJECT

906 WESTMINSTER ST NW WASHINGTON DC 20001

REVISIO	NS	
NO.	DESCRIPTION	D,
	ISSUED FOR PERMIT	1-24-20
$\overline{\mathbb{A}}$	PERMIT COMMENTS	6-24-20

ING TITLE

SPECIAL INSPECTIONS

DRAWING INFORMATION	
SCALE	AS NO
DATE	12-01
DRAWN BY	
PROJECT NUMBER	D23

\$102

DRAWING NUMBER