

3320 Brown St NW

### LIST OF ABBREVATIONS

Manufacturer('S)

Masonry Opening

Microwave Over

Not in Contract

Outside Diameter

Opposite Hand

Owner Furnished, Contractor Installed

Not to Scale

On Center

Opening

Opposite

Partition

Perforated

Plexiglass

Plywood

Painted

Quantity

Riser(s)

Radius

Quarry Tile

Receptacle

Refrigerator

Reinforcing

Required

Resilient

Revision

Rain Leader

Roof Top Unit

Solid Core

Section

Sheet

Similar

Schedule(d)

Square Feet

Specification

Standard

Storage

Surface

Suspend

Tread(s)

Telephone

Temperature

Top of (\_\_\_\_\_

Unfinished

Underside

Vapor Barrier

Ventilate(or)

Verify in Field

Water Closet

Wide Flange

Water Heater

Waterproofing

Welded Mire Mesh

Without

Vertical

Veneer

Vestibule

Typical

Tongue and Groove

Underwriters Laboratories, Inc.

Unless Noted Otherwise

Vinyl Composition Tile

To Be Determined

Structure

Stainless Steel

Surface Four Sides

Polyethylene

Plate/Property Line

Pound Per Square Foot

Pound Per Square Inch

Pressure Treated

Polyvinyl Chloride

Rough Opening

Reflected Ceiling Plan

Plastic Laminate

Miscellaneous

Minimum

Mounted

Mounting

North

Number

Overall

MIN MISC Number Centerline MO Diameter MTL MTD One-inch nominal thickness MTG 2X Two-inch nominal thickness ABV Air Conditioning ACOUS1 Acoustical ACT NO Acoustical Ceiling Tile ADJ NTS Adjacent, Adjustable AFF OA Above Finish Floor OD AHU Air Handler Unit Alternate OFCI ALUM Aluminum ANOD OFF Anodized APPRO2 Approximate OPNG BD Board (or Bead, if applicable) **BTWN** Between PART BLDG Building BLKG PERF Blocking BLT BM PLAM Beam BOT PLEX Bottom Bearing PLYWD BSMT CAB CER POLY Basement PR PSF Cabinet Ceramic PSI CH Ceiling Height Control Join CLG PTD CLAD CLO CLR PVC Cladding Closet QTY Clear CMU Concrete Masonry Unit COL CONC Concrete CONST RCP Construction CONT RECPT Continuous CORR REF Corrugated CPT REG REINF CS Cast Stone CSK CSMT REQD Countersink **RESIL** Casement CT REV Ceramic Tile CTR Center/Counter CTRD Centered RTU CW Cold Water DBL Double DEMO S4S Demolish, Demolition DET Drinking Fountair SCHED SECT Double Hung DIA SHT Diameter SIM DIM DN SQ Downspout SS STD DW Dishwashe DWG Drawing STL STOR Each **STRUCT** Expansion Joint SURF Elevation **ELEC** Electric(al) SUSP **ELEV** Elevator **EMER** T&G Emergency EQ TEL **EQUIP** Equipment **EWC** TEMP Electric Water Cooler **EXIST** Exhaust Expansion, Exposed TYP EXT FA Fire Alarm UL FBO Furnished by Owner UNFIN FD Floor Drain UNO U/S Foundation Fire Extinguisher Cabinet UTIL Finish Floor FGL VCT Fiberglass **VENT** FIN **VERT** FLASH Flashing **VEST** VIF **FLUOR** Fluorescent VNR FOM Face of Masonry Face of Structure (or Face FOS of Stud, where applicable) Fiberglass reinforced plastic FRT Fire Retardant Treated FRMG Framing FT FTG Footing **FURN** Furniture/Furnish **FURR** Furring FVC Fire Valve Cabinet GΑ GALV Galvanized GC General Contractor Ground Fault Interrupter **GWB** Gypsum Wall Board GYP Gypsum HB Hose Bib HC Hollow Core/Handicappd **HDWE** Hardware HM Hollow Metal HORIZ Horizontal HT Height **HVAC** Heating/Ventilation/Air-Conditioning HW Hot Water IG Isolated Ground **INCAN** Incandescent INCL Include(d) INSUL Insulation INT Interior JAN Janitor Joint LAV Lavatory LEV Level MAS Masonry MAX Maximum Medium Density Fiberboard MDO Medium Density Overlay MECH Mechanical MEZZ Mezzanine

### GENERAL NOTES

1. OMISSIONS OR CONFLICTS IN THE DRAWINGS AND ANY RESTRICTIONS RELATED TO THE EXECUTION OF THE WORK. IN THE CASE OF CONFLICTS BETWEEN DRAWINGS, OR NOTES AND DRAWINGS, IT SHALL BE ASSUMED THE STRICTEST CONDITION OR REQUIREMENT HAS BEEN INCLUDED IN THE COST AND SCOPE OF THE WORK.

2. ISSUE COMPLETE SETS OF THE CONTRACT DOCUMENTS TO EACH OF THE SUBCONTRACTORS FOR COORDINATION OF THEIR WORK WITH OTHER TRADES AND DESCRIPTION OF SCOPE.

 APPLY FOR, OBTAIN AND PAY FOR ALL PERMITS, FEES, INSPECTIONS AND APPROVALS BY LOCAL AUTHORITIES HAVING JURISDICTIONS OVER THE PROJECT. PROVIDE COPIES OF ALL CODES IN FORCE. CONTRACTOR SHALL BE RESPONSIBLE FOR COMPLIANCE WITH ORDERS OF ANY PUBLIC AUTHORITY BEARING ON THE PERFORMANCE OF THE WORK.
 CONTRACTOR IS RESPONSIBLE FOR COORDINATING AND PROVIDING PROTECTION FOR ALL

NEW AND EXISTING WORK IN PLACE WHEN SUBJECT TO POTENTIAL DAMAGE BY WORK OF OTHER TRADES. CONTRACTOR SHALL BE RESPONSIBLE FOR COORDINATION OF ALL ABOVE CEILING WORK AND SHALL DURING LAYOUT, SUBMIT COORDINATION SHOP DRAWINGS OF ALL CEILING HEIGHT, FIXTURES, CONDUIT, PIPING, SPRINKLER LINES AND DUCT WORK IDENTIFYING ANY POTENTIAL CONFLICTS. CONTRACTOR SHALL REROUTE ITEMS AS REQUIRED. CONTRACTOR SHALL BE RESPONSIBLE FOR MINOR RELOCATIONS OF ITEMS, TO AVOID CONFLICTS WHILE MAINTAINING THE DESIGN INTENT.

5. GC SHALL DEFINE SCOPE, SCHEDULE AND COST IMPLICATIONS WITH OWNER REGARDING ANY WORK BEING DONE BY OUTSIDE CONTRACTORS AND SUBCONTRACTORS.

6. COORDINATE SCHEDULING PROVISIONS FOR INSTALLATION, LOCATIONS AND THE ACTUAL INSTALLATION OF ITEMS FURNISHED BY OWNER OR BY OTHERS. FACILITATE WORK WITH ALL TRADES ON THE PROJECT NOT UNDER CONTRACT TO THE CONTRACTOR (I.E., TELEPHONE,

COMPUTER INSTALLERS, ETC.).
VERIFY DIMENSIONS IN THE FIELD. TO THE EXTENT THAT DIMENSIONS CANNOT BE VERIFIED OR THE VERIFICATION OF DIMENSIONS WOULD CAUSE A DELAY IN THE PROGRESS OF THE WORK, CONTRACTOR SHALL GUARANTEE DIMENSIONS TO HIS SUBCONTRACTOR FOR COORDINATION.

8. SUBMIT FOR CONSIDERATION SAMPLES AND PRODUCT LITERATURE AND OTHER PERTINENT DATA OF ANY PROPOSED SUBSTITUTIONS.

9. PERFORM ALL WORK AND INSTALL MATERIALS IN STRICT ACCORDANCE WITH MANUFACTURER'S SPECIFICATIONS AND INSTRUCTIONS AND IN A MANNER CONSISTENT WITH INDUSTRY STANDARDS OF WORKMANSHIP


INDUSTRY STANDARDS OF WORKMANSHIP.

10. EXAMINE ALL SURFACES TO DETERMINE THAT THEY ARE SOUND, DRY, CLEAN AND READY TO RECEIVE FINISHES OR MILLWORK PRIOR TO INSTALLATION. START OF INSTALLATION SHALL IMPLY ACCEPTANCE OF SUBSTRATE AND SHALL NOT BE GROUNDS FOR CLAIMS AGAINST IMPROPER PERFORMANCE OF INSTALLED MATERIALS.

11. INSTALL AND MAINTAIN ALL NECESSARY COVERINGS, PROTECTIVE ENCLOSURES, TEMPORARY DOORS AND PARTITIONS AND DUST BARRIERS TO PROTECT ALL OCCUPANTS AND EXISTING WORK AND FINISHES TO REMAIN. REPAIR AND REPLACE ANY DAMAGES CAUSED BY IMPROPER PROTECTION AT NO ADDITIONAL COST TO OWNER.

12. PROVIDE TO OWNER ANY MANUFACTURER/ PRODUCT LITERATURE, MAINTENANCE REQUIREMENTS AND/ OR SCHEDULES.

## SYMBOLS LEGEND

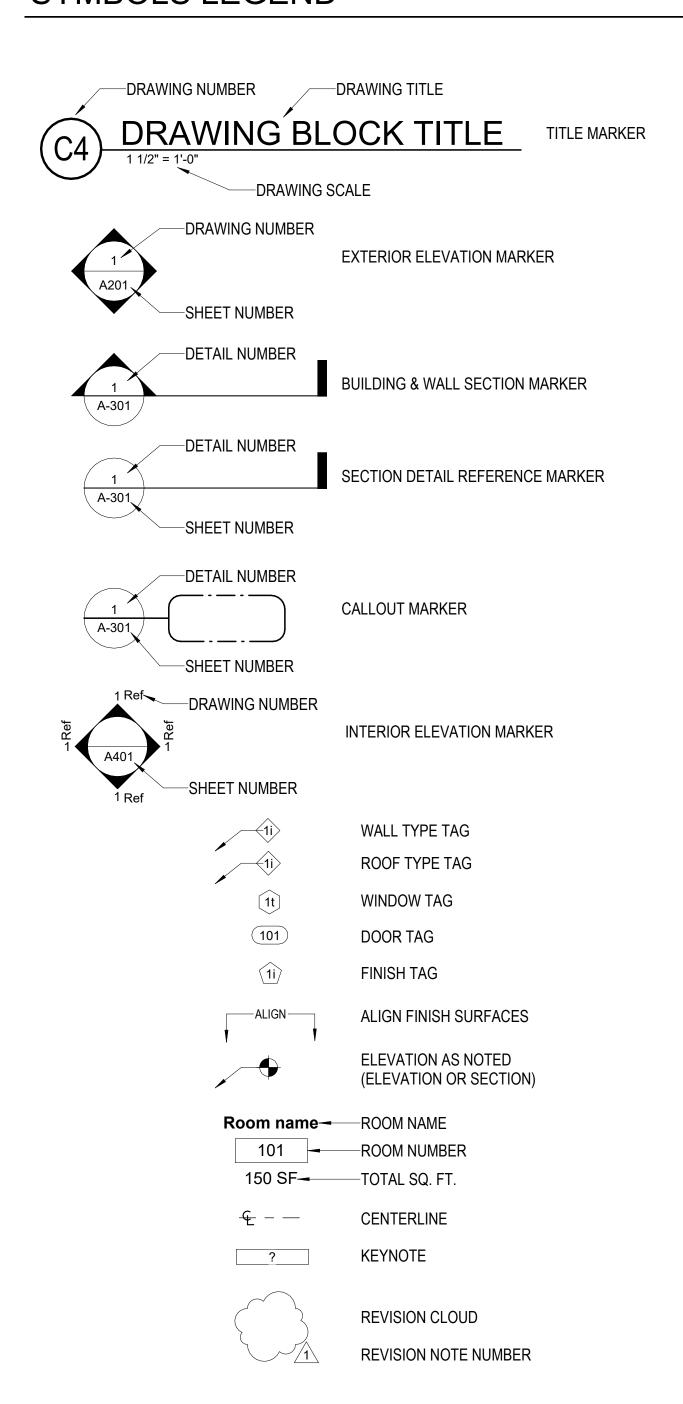

### PROPERTY INFORMATION

ADDRESS:	3320 BROWN ST NW WASHINGTON DC 20010-1811		
SSL:	2611- 0804		
NEIGHBORHOOD:	036 - Mount Pleasant		
USE CODE:	041 - Store-Small (1 Story)		
TAX CLASS:	2 - Commercial		
WARD:	1		
ZONING - Title DCMR			

ZONING - Title DO

ZONING - Titl

LOT AREA: 832 SF

Α	ALLOWED	EXISITNG	PROPOSED
FRONT YARD:	SAME AS BLOCK	0' - 0"	NO CHANGE
REAR YARD:	20' -0"	0' - 0"	NO CHANGE
SIDE YARD:	5' - 0"	SIDE 1 ( 0' - 0")	NO CHANGE
		SIDE 2 ( 12' - 4")	
HEIGHT:	35' - 0"	18' - 2"	NO CHANGE
LOT OCC.:	40% (332.8 SF)	77.5% (644.96 SF)	NO CHANGE

BUILDING CODE - DC CONSTRUCTION CODE 2017		
PROPOSED USE:	COMMERCIAL	
CONSTRUCTION TYPE:	V-B	
FLOOR AREA:	509.23 SF	
EXITS:	1	
ELEVATOR:	NO	
SPRINKLERED:	NO	


# APPLICABLE CODES

2017 DC Construction Codes
2015 International Residential Code
2015 International Existing Building Code
2015 International Energy Conservation Code
2015 International Mechanical Code
2015 International Plumbing Code
2014 National Electric Code

DC Law 8-36 District of Columbia Environmental Policy Act of 1989 DCMR Title 11 - Zoning Regulations

DCMR Title 12 - Construction Codes Supplement (2017)
DCMR Title 13 - Electrical and Mechanical

# **VICINITY MAP**

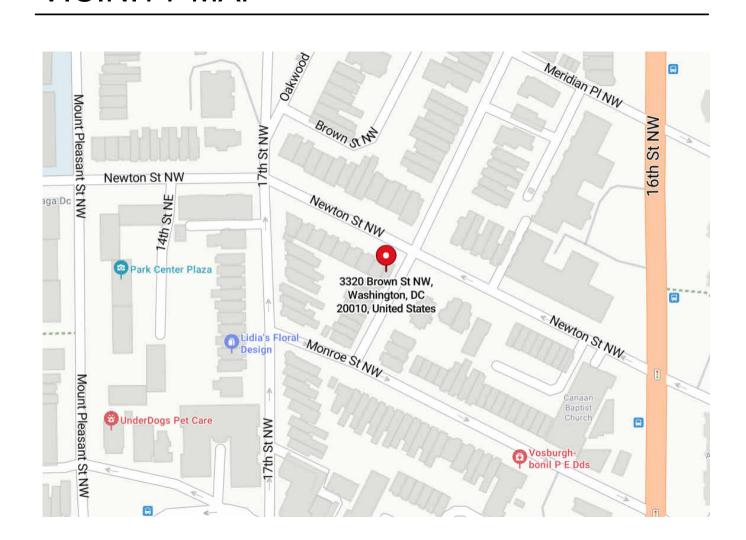

# PROJECT TEAM

OWNER: ARCHITECT:

Daniel Cidon Jonathan Kuhn Architect

403 W Rosenary LN 508 Kennedy Street NW #313 Falls Church VA 22046 Washington, DC 20011

Contact: dancidon@gmai.com Contact: Jonathan Kuhn 202.494.5061

MEP ENGINEER: STRUCTURAL ENGINEER:

### PROJECT DESCRIPTION

INTERIOR AND EXTERIOR RENOVATION TO EXISTING SEMI-DETACHED STRUCTURE (CONVERTING TO MULTIPURPOSE). INTERIOR RENOVATIONS INCLUDE NEW FIXTURES, FINISHES AND LOFT STORAGE AREA. EXTERIOR ALTERATIONS INCLUDE REMOVAL OF SECURITY BARS, NEW WINDOWS, NEW FOLDING DOOR, EXTERIOR PAINT.

### **DRAWING INDEX**

PROJECT INFO

A000 COVER SHEET
A001 PROJECT INFO

ARCHITECTURAL

101 EXISTING FLOOR PLAN AND ELEVATIONS

D102 EXISTING CONDITIONS

ARCHITECTURAL

A 10 1 PROPOSED FLOOR PLAN AND ELEVATIONS

A102 PROPOSED USES DIAGRAMS

JKA

OFFICIAL STAMPS

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3320 Brown St NW
Washignton DC 20010

06/21/24 SCHEMATIC DESIGN

ISSUE RECORD

NO. DATE


SEAL

SHEET NAME

PROJECT INFO


SCALE 1/4" = 1'-0"

A001

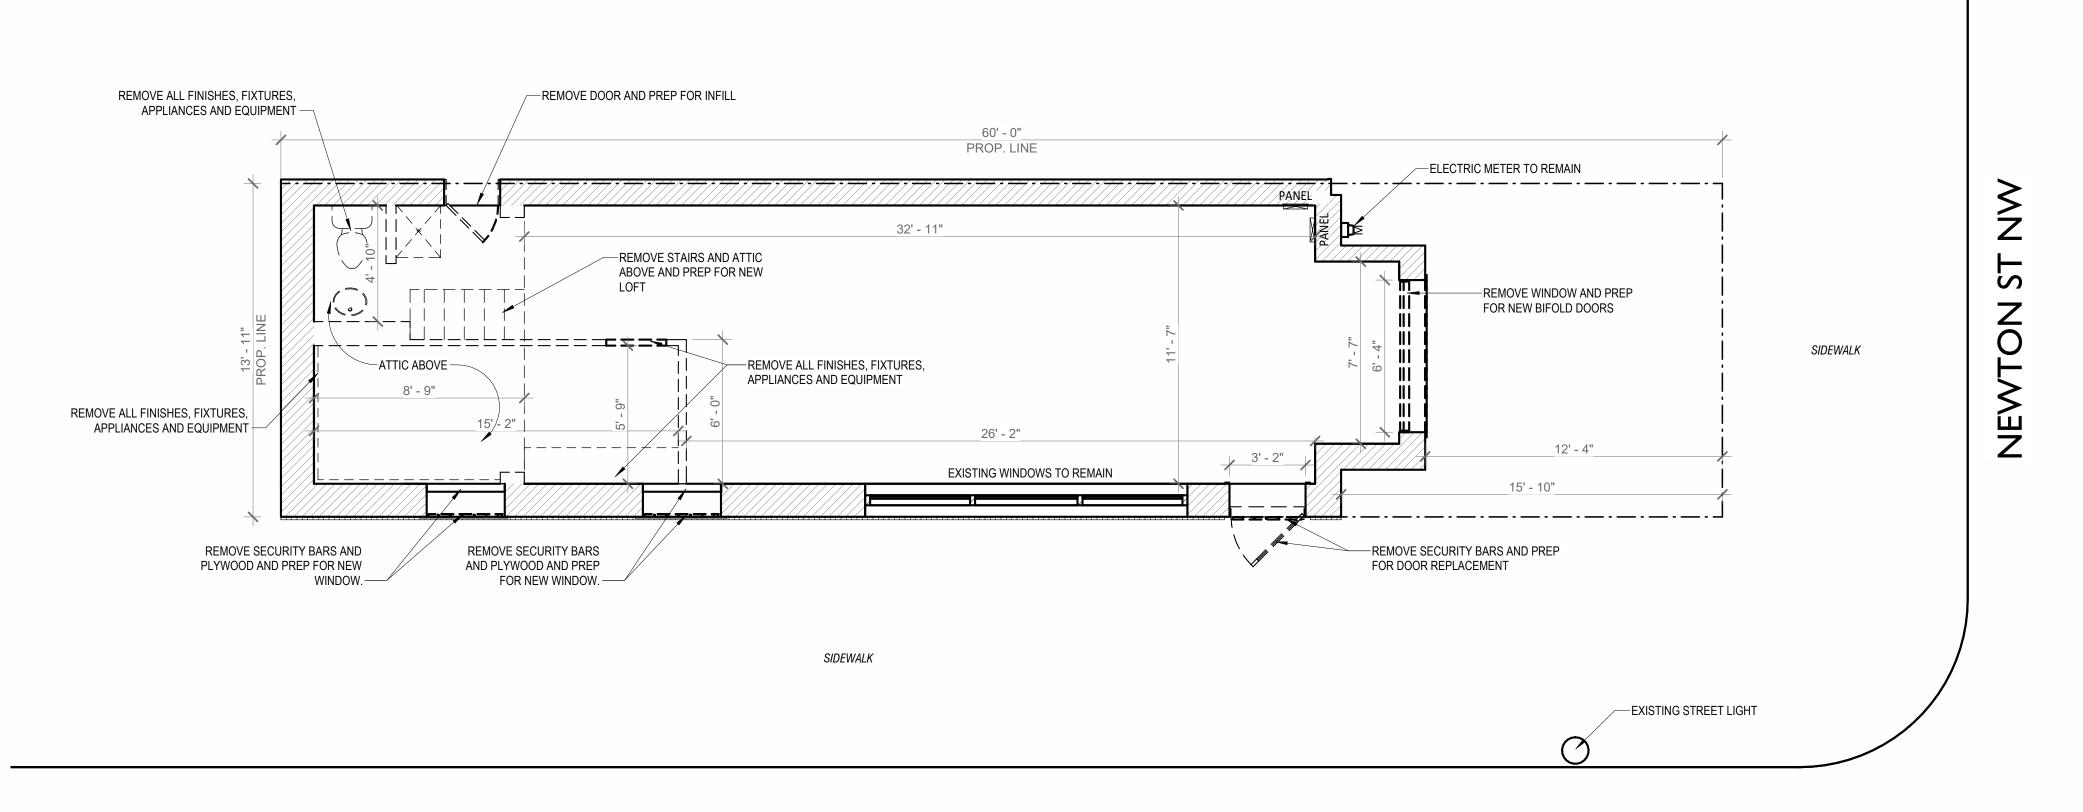


# BROWN ST NW



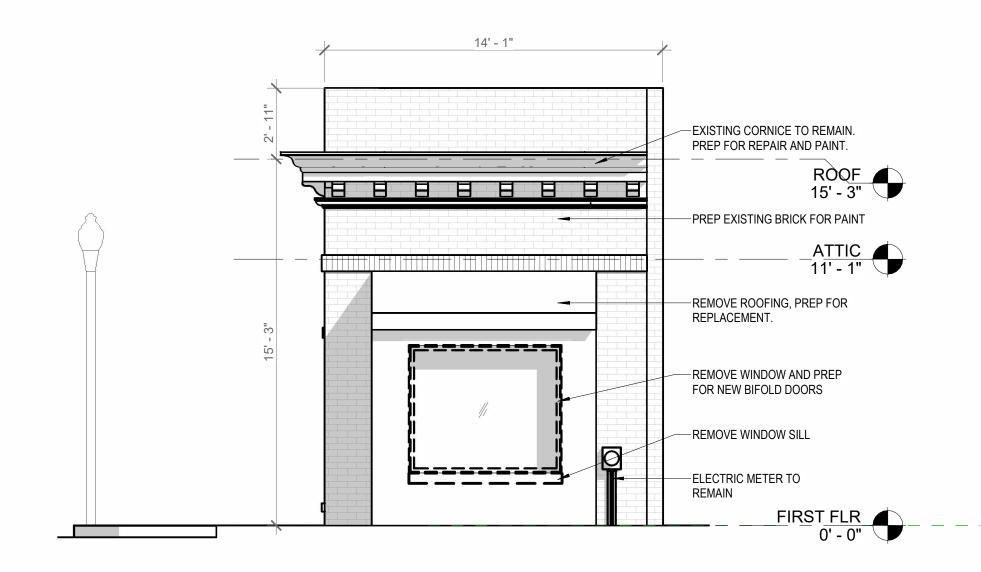



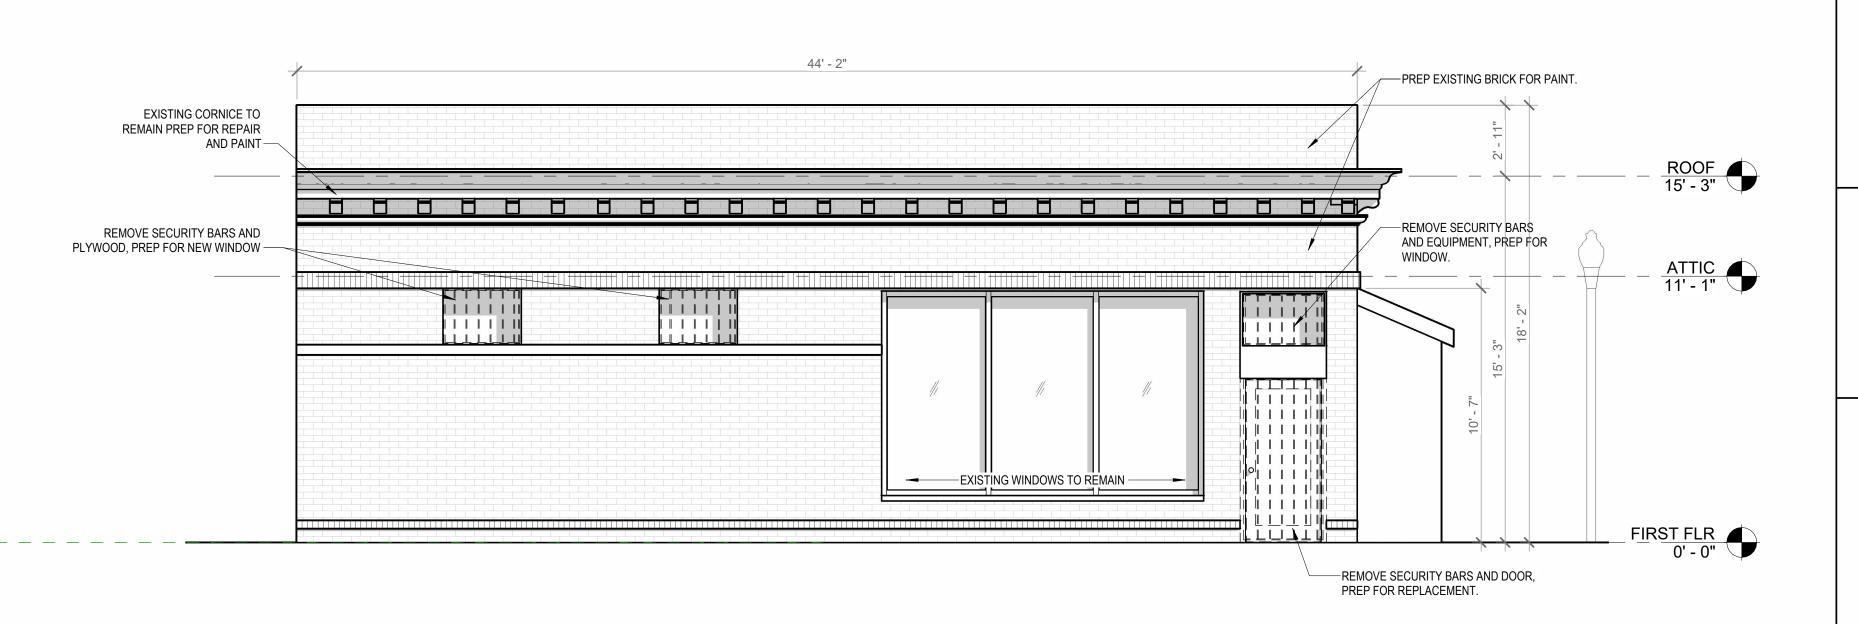

3 EXISTING SIDE ELEVATION

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06/21/24
SCHEMATIC DESIGN

REVISION SCHEDULE
NO. DATE

SEAL

EXISTING FLOOR
PLAN AND

ELEVATIONS

SCALE

1/4" = 1'-0" SHEET NO.

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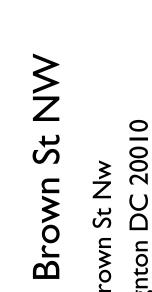


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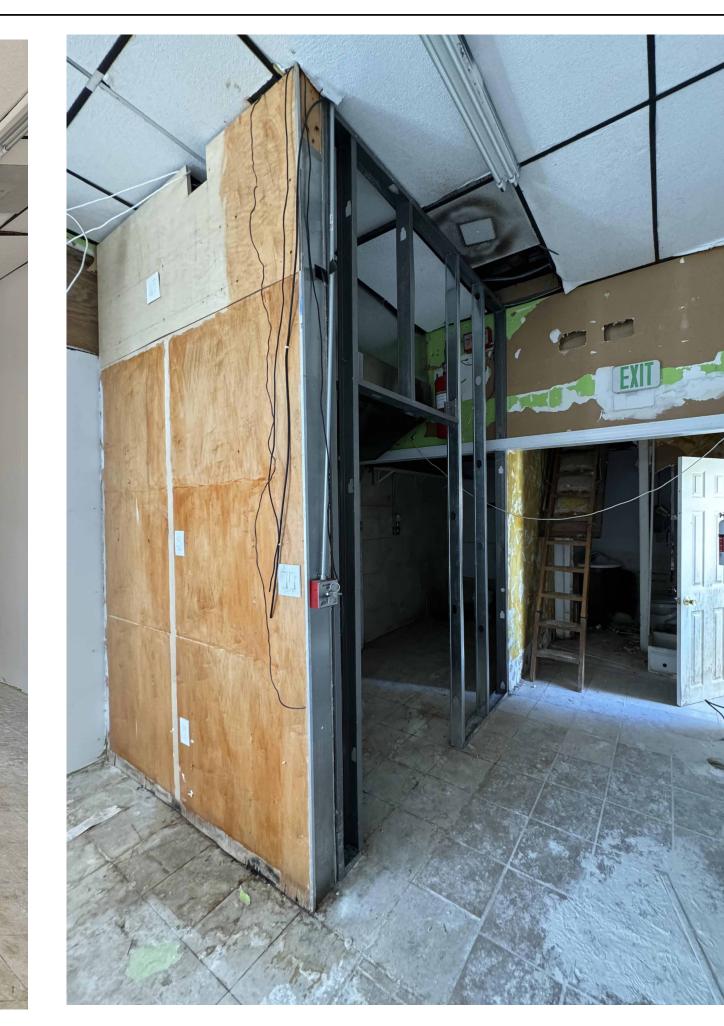


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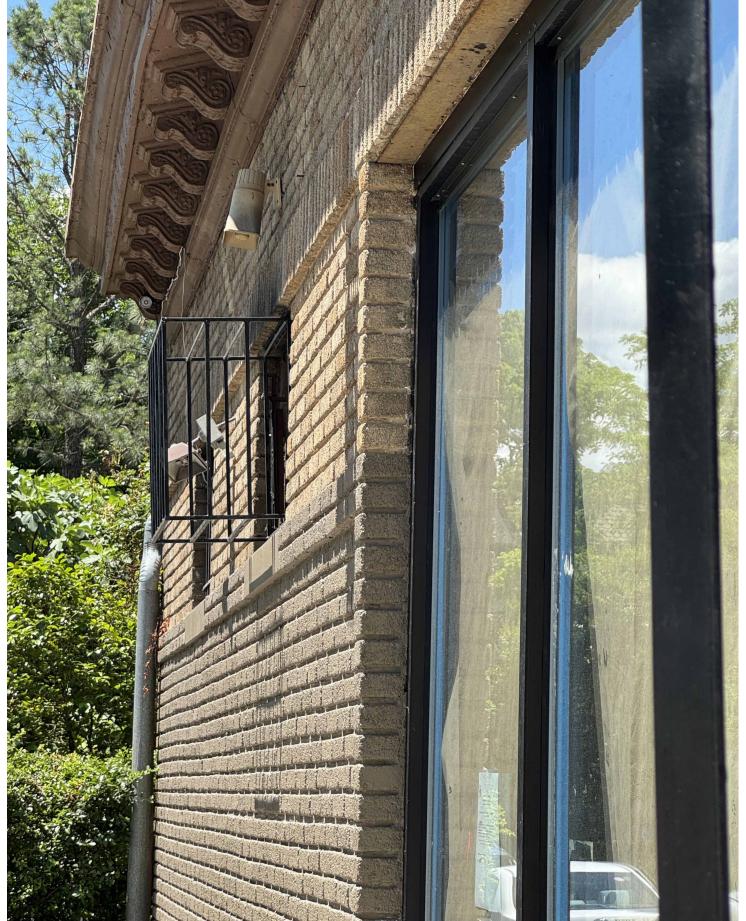
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**EXISTING** CONDITIONS

D102









SIDE ELEVATION



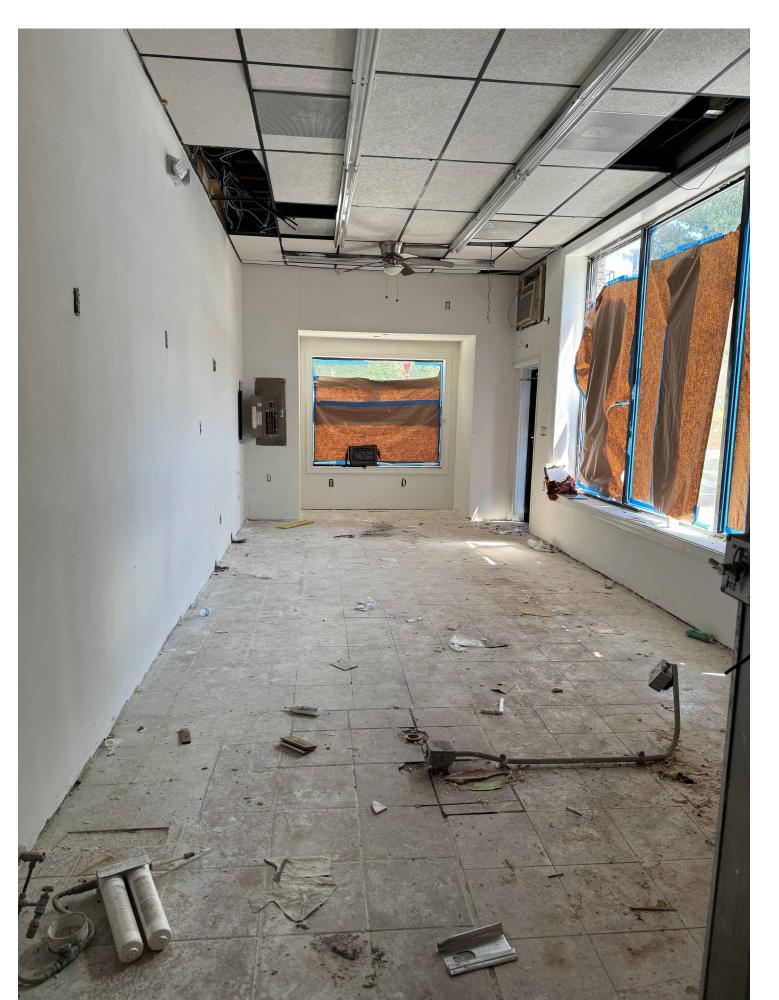


INTERIOR CONDITIONS

**INTERIOR VIEW** 

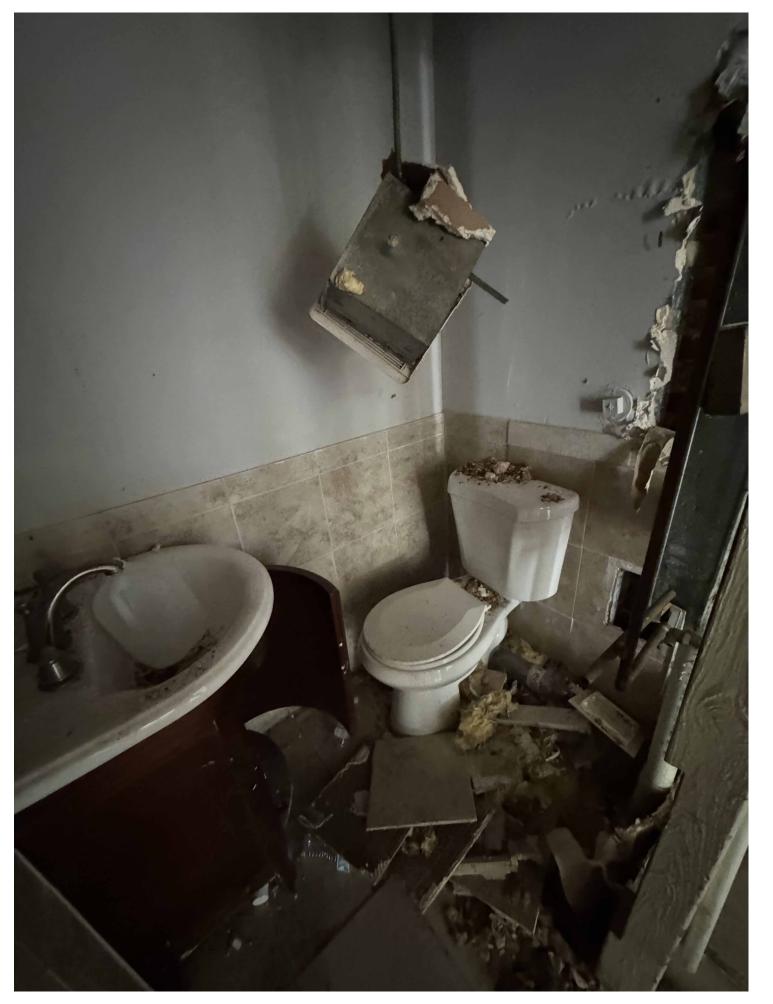

INTERIOR CONDITIONS



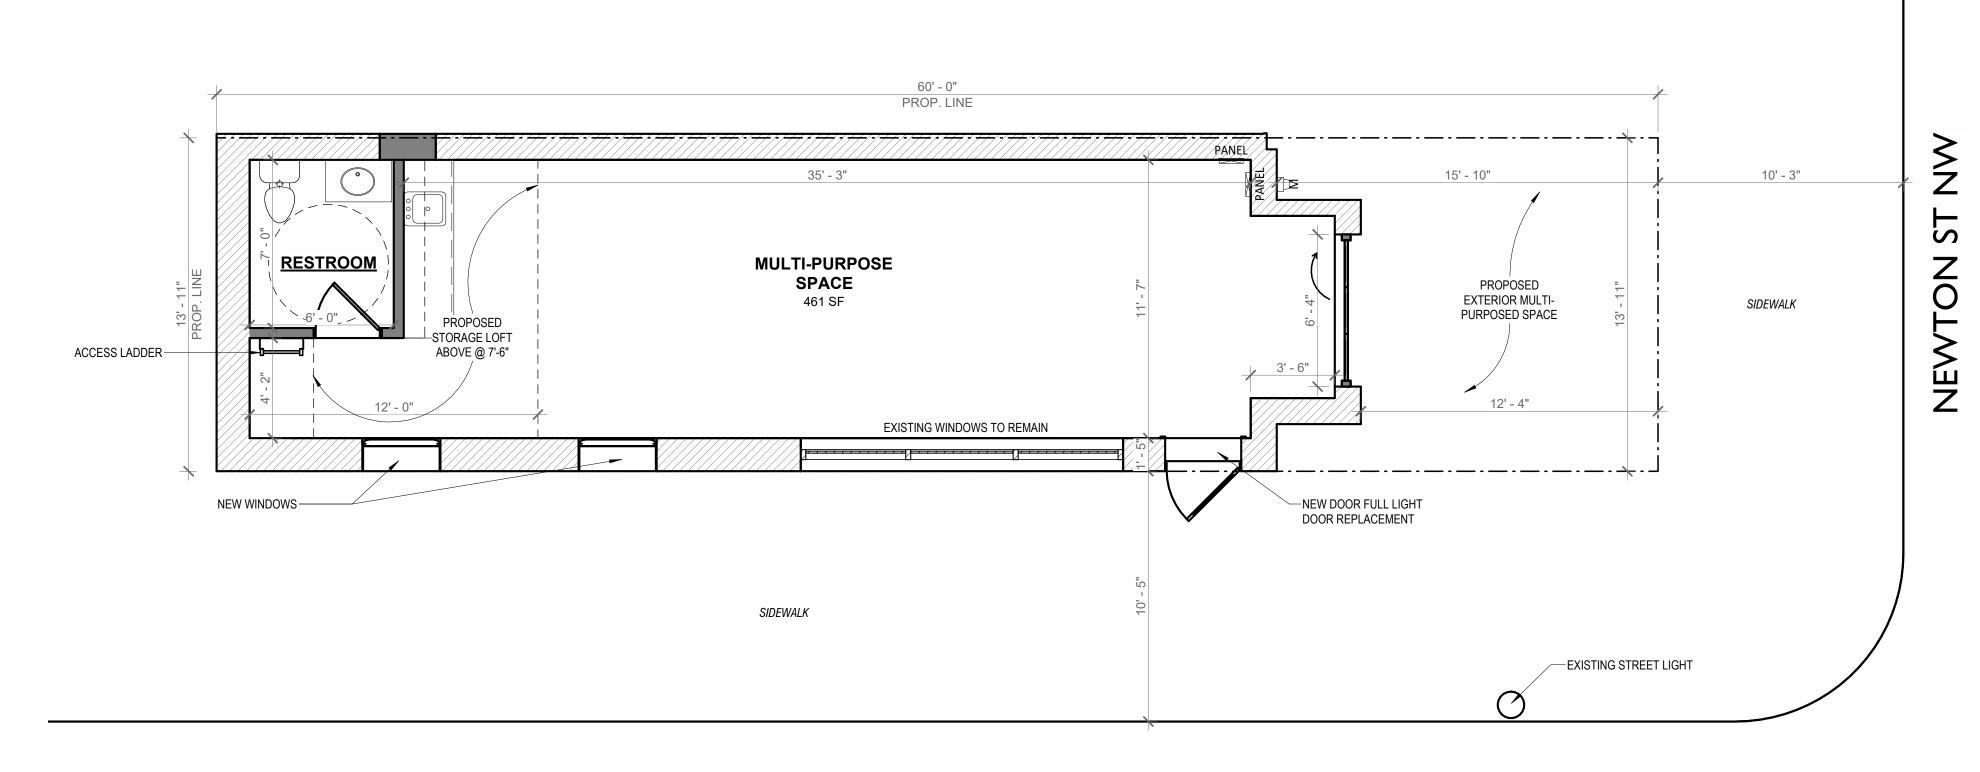

# OCCUPANT LOAD CALCULATIONS

PROPOSED MULTI PURPOSE SPACE - OCCUPANT LOAD:

- TOTAL AREA: 461 SF

- TABLE 1004.1.2, ASSEMBLY WITHOUT FIXED SEATS: 7 NET

- OCCUPANT LOAD: 461 / 7 = 65.85

TOTAL OCCUPANT LOAD: = 65 CALCULATED ( MAX ALLOWABLE IS 49 )

- TRAVEL DISTANCE TO EXIT FROM FARTHEST POINT: 41'-10"

\* FOR SPACES WITH ONLY ONE MEAN OF EGRESS, THE MAXIMUN ALLOWABLE OCCUPANT LOAD IS 49.\*

\* FOR OCCUPANT LOAD < 49 AND UP TO TRAVEL DISTANCE 75'
ONE MEAN OF EGRESS REQUIRED PER 2017 DCBC TABLE 1006.2.1

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SEAL

PROPOSED FLOOR
PLAN AND
ELEVATIONS

As indicated


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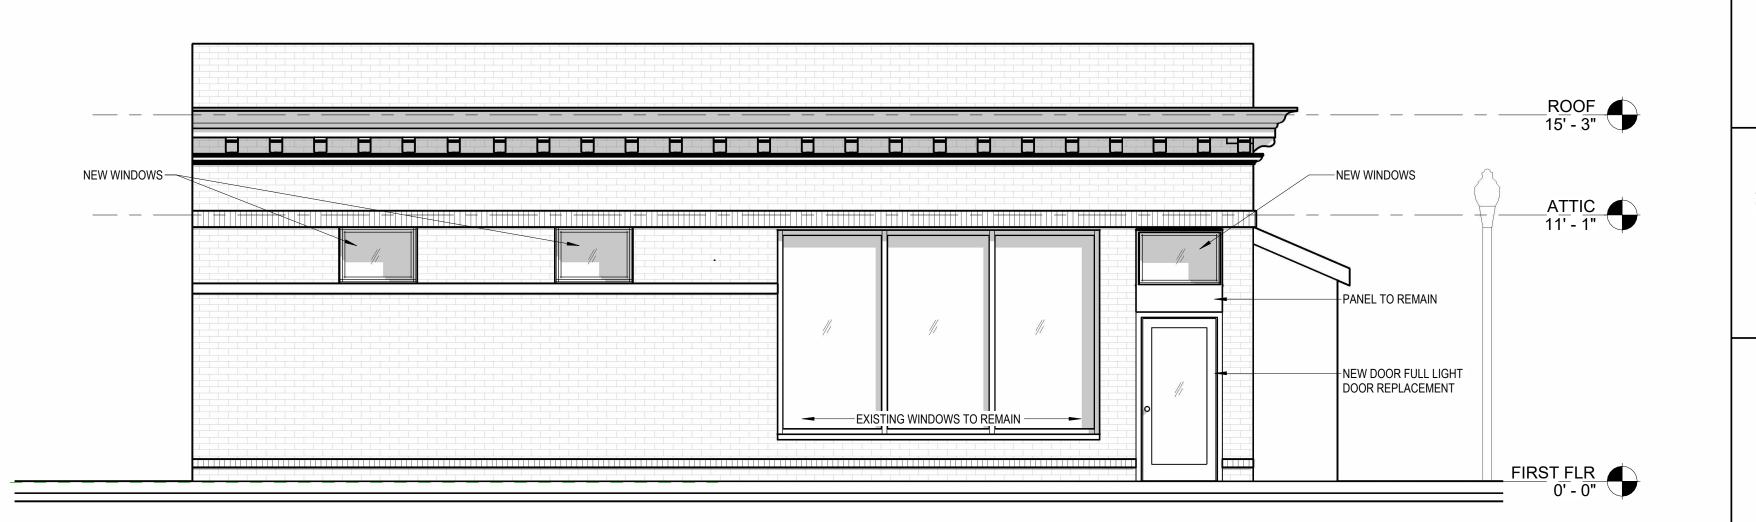
BROWN ST NW

1 PROPOSED FIRST FLOOR PLAN

1/4" = 1'-0"






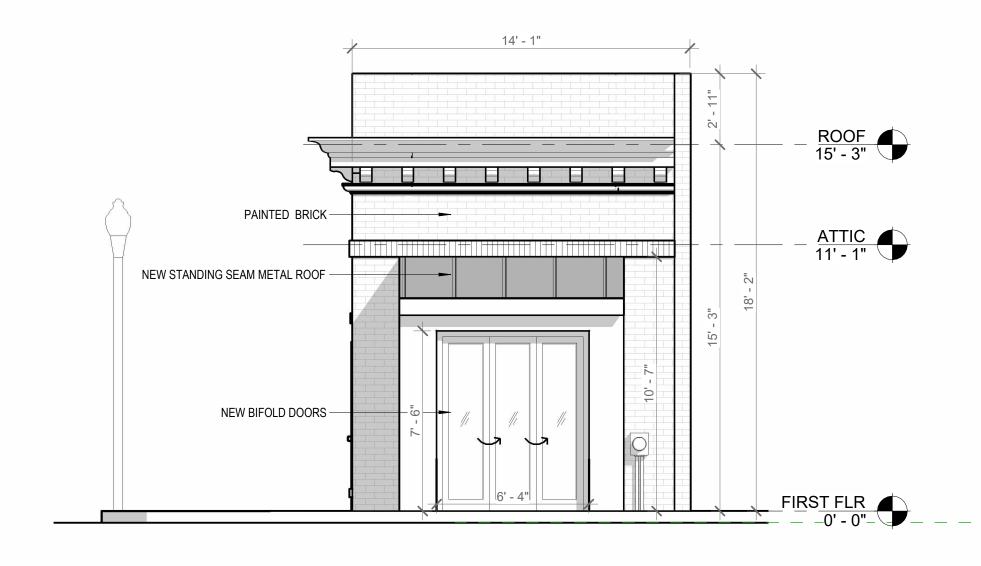


PROPOSED SIDE ELEVATION

1/4" = 1'-0"

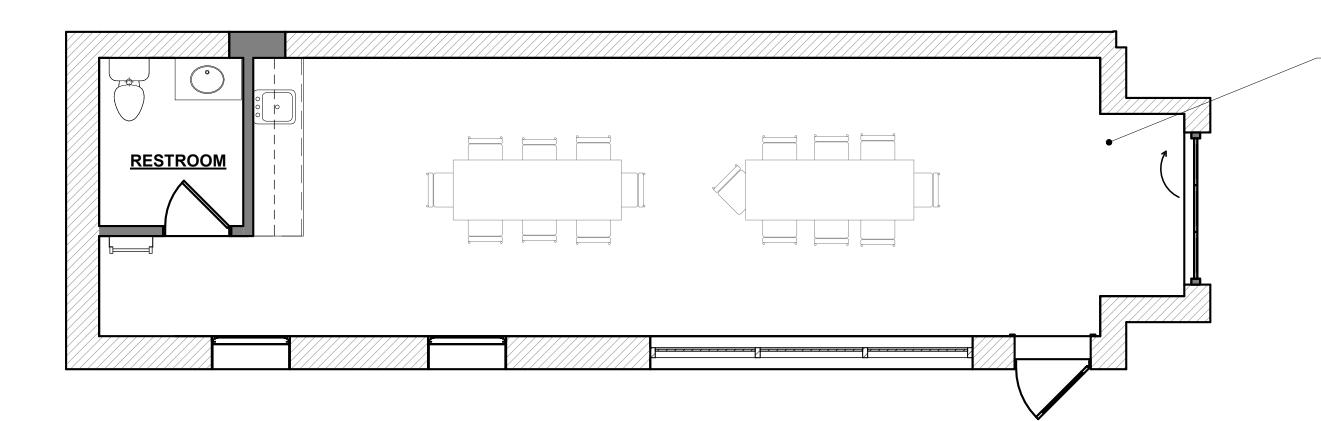


### PROPOSED PROGRAM:

- 10-15 PEOPLE CRAFT CLASSES
- 15-30 PEOPLE WRITING WORKSHOPS
- 16-20 KIDS ACTIVITIES

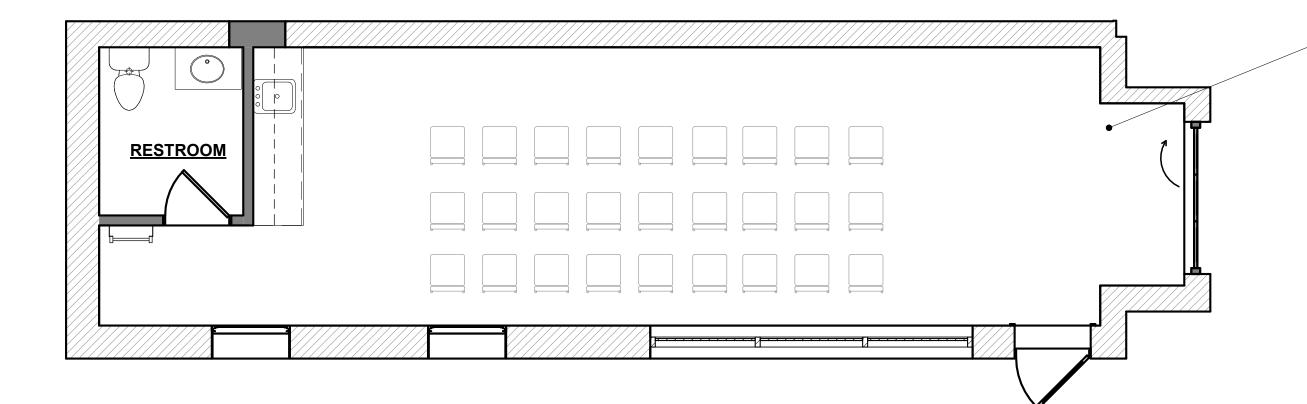


# PROPOSED PROGRAM: (UP TO 49 OCCUPANTS)

- SEATED PRESENTATION
- SEATED MOVIE SCREENING
- MUSICAL EVENTS / PRESENTATIONS

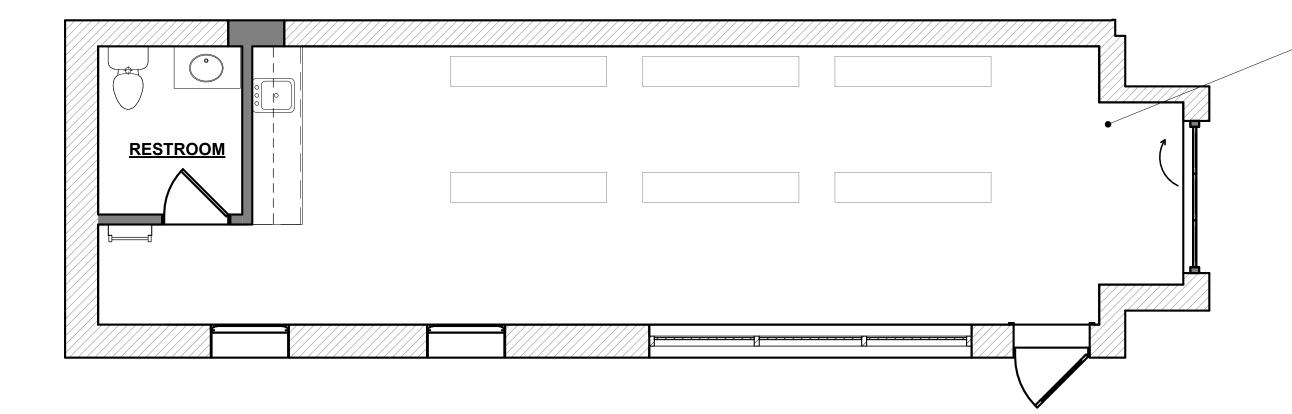


# PROPOSED PROGRAM: (UP TO 49 OCCUPANTS)


- BOOK FAIR
- ANTIQUE FAIR
- ART DISPLAY
- POP UP CERAMIC SHOP

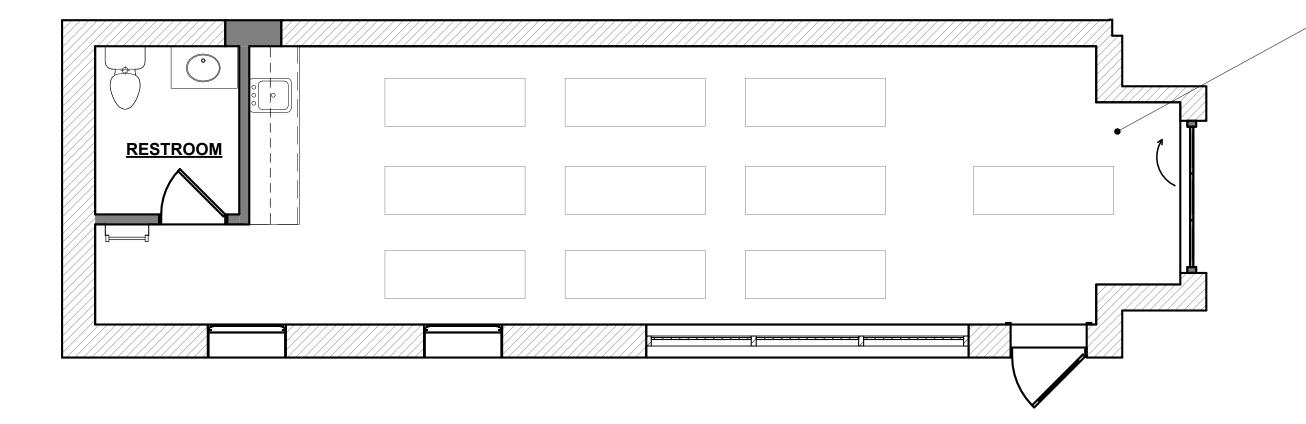


# PROPOSED PROGRAM:

- 6-10 PEOPLE YOGA CLASSES
- 10- 15 PEOPLE HITT CIRCUIT GYM CLASS
- 15-20 PEOPLE MEDITATION SESSIONS

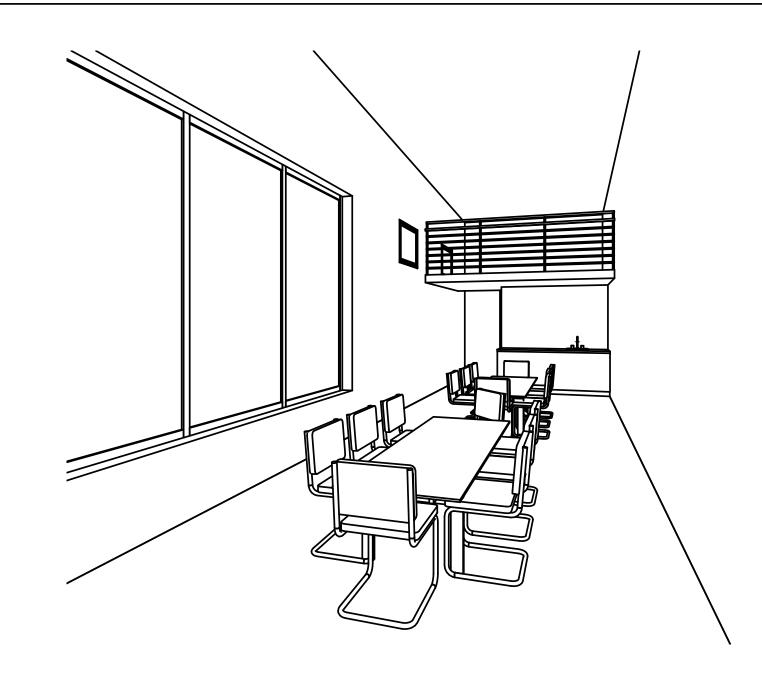

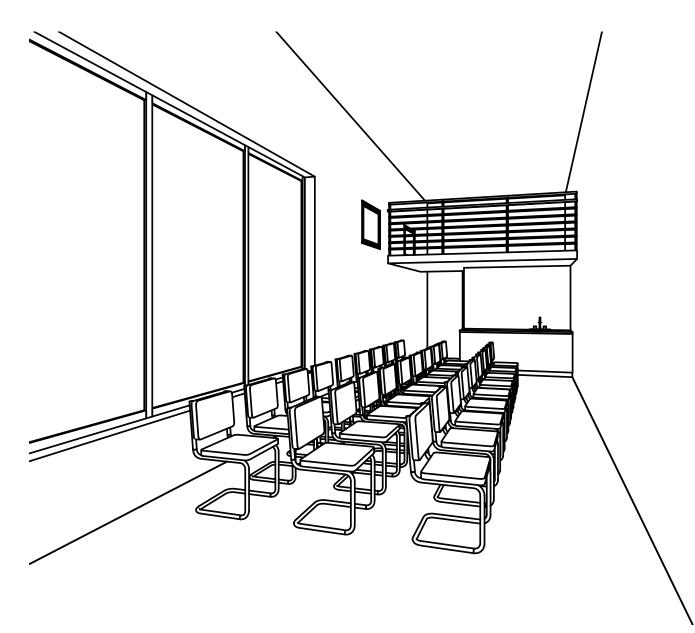

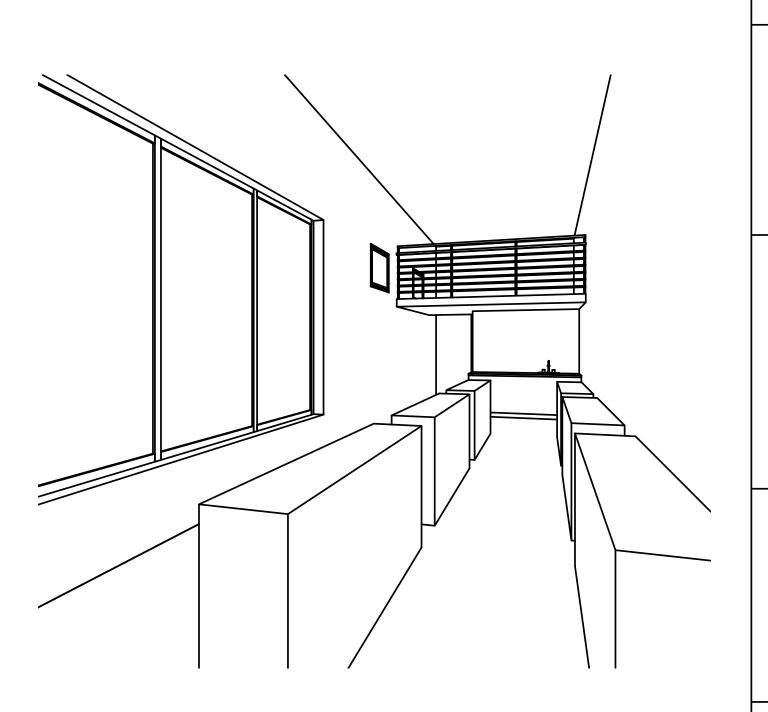



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PROPOSED USES DIAGRAMS

1/4" = 1'-0"

A102