

228 RESIDENCES
228 HAMILTON STREET NW
WASHINGTON, DC 20011

FOR PERMIT

15 AUGUST 2025

//3877

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DAVID SHOVE BROWN, AIA, NCARB
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WASHINGTON, DC 20007
[T] 703.425.3862

GENERAL CONTRACTOR :
PALMAR CONSTRUCTION
769 GRACE ST
HERNDON, VA 20170
[T] 703.589.4832

MEP ENGINEER: :
KK ENGINEERING LLC
8850 COLUMBIA 100 PARKWAY, SUITE 316
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[T] 443.393.1070


STRUCTURAL ENGINEER: :
GAVIN & ASSOC STRUCTURAL ENGINEERS
CHARLES GAVIN
PO BOX 5142
MCLEAN, VA 22103
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DEMOLITION NOTES


1. CONTRACTOR SHALL VISIT SITE TO DETERMINE AND VERIFY ALL EXISTING CONDITIONS.
2. PROTECT EXISTING ITEMS WHICH ARE NOT INDICATED TO BE ALTERED.
3. REMOVE EXISTING PARTITIONS, U.N.O.
4. REMOVE DOORS, FRAMES AND HARDWARE, U.N.O.
5. REMOVE EXISTING WINDOWS AS NOTED.
6. REMOVE ALL APPLIANCES THROUGHOUT, U.N.O.
7. REMOVE PLUMBING FIXTURES THROUGHOUT, U.N.O.
8. REMOVE ALL BRANCH WIRING REMOVED BACK TO PANEL (IDENTIFY AS SPARE) OR NEAREST JUNCTION BOX UNLESS NOTED OTHERWISE.
9. CONTRACTOR TO REMOVE/DISPOSE OF ALL REMAINING FURNITURE
10. REMOVE LIGHT FIXTURES THROUGHOUT, U.N.O.
11. REMOVE ALL EXISTING FLOOR FINSHES, SUBFLOOR TO REMAIN.
12. WHERE REQUIRED, STRUCTURES UNDER CONSTRUCTION, ALTERATION OR DEMOLITION SHALL BE PROVIDED WITH NO FEWER THAN ONE APPROVED PORTABLE IRE EXTINGUISHER IN ACCORDANCE WITH SECTION 906 AND SIZED FOR NOT LESS THAN ORDINARY HAZARD AS FOLLOWS: 1. AT EACH STAIRWAY ON ALL FLOOR LEVELS WHERE COMBUSTIBLE MATERIALS HAVE ACCUMULATED. 2. IN EVERY STORAGE AND CONSTRUCTION SHED. 3. ADDITIONAL PORTABLE FIRE EXTINGUISHERS SHALL BE PROVIDED WHERE SPECIAL HAZARDS EXIST, SUCH AS THE STORAGE AND USE OF FLAMMABLE AND COMBUSTIBLE LIQUIDS
13. SANITARY FACILITIES SHALL BE PROVIDED DURING CONSTRUCTION, REMODELING OR DEMOLITION ACTIVITIES IN ACCORDANCE WITH THE PLUMBING CODE
14. REQUIRED MEANS OF EGRESS SHALL BE MAINTAINED AT ALL TIMES DURING CONSTRUCTION, DEMOLITION, REMODELING OR ALTERATIONS AND ADDITIONS TO ANY BUILDING
15. FIRE SAFETY DURING DEMOLITION SHALL COMPLY WITH THE APPLICABLE REQUIREMENTS OF THIS CODE AND THE APPLICABLE PROVISIONS OF CHAPTER 33 OF THE FIRE CODE
16. AUTOMATIC SPRINKLER SYSTEMS REQUIRED DURING CONSTRUCTION, ALTERATION AND DEMOLITION OPERATIONS SHALL BE PROVIDED IN ACCORDANCE WITH CHAPTER 33 OF THE FIRE CODE

EXISTING TO REMAIN

===== TO BE DEMOLISHED

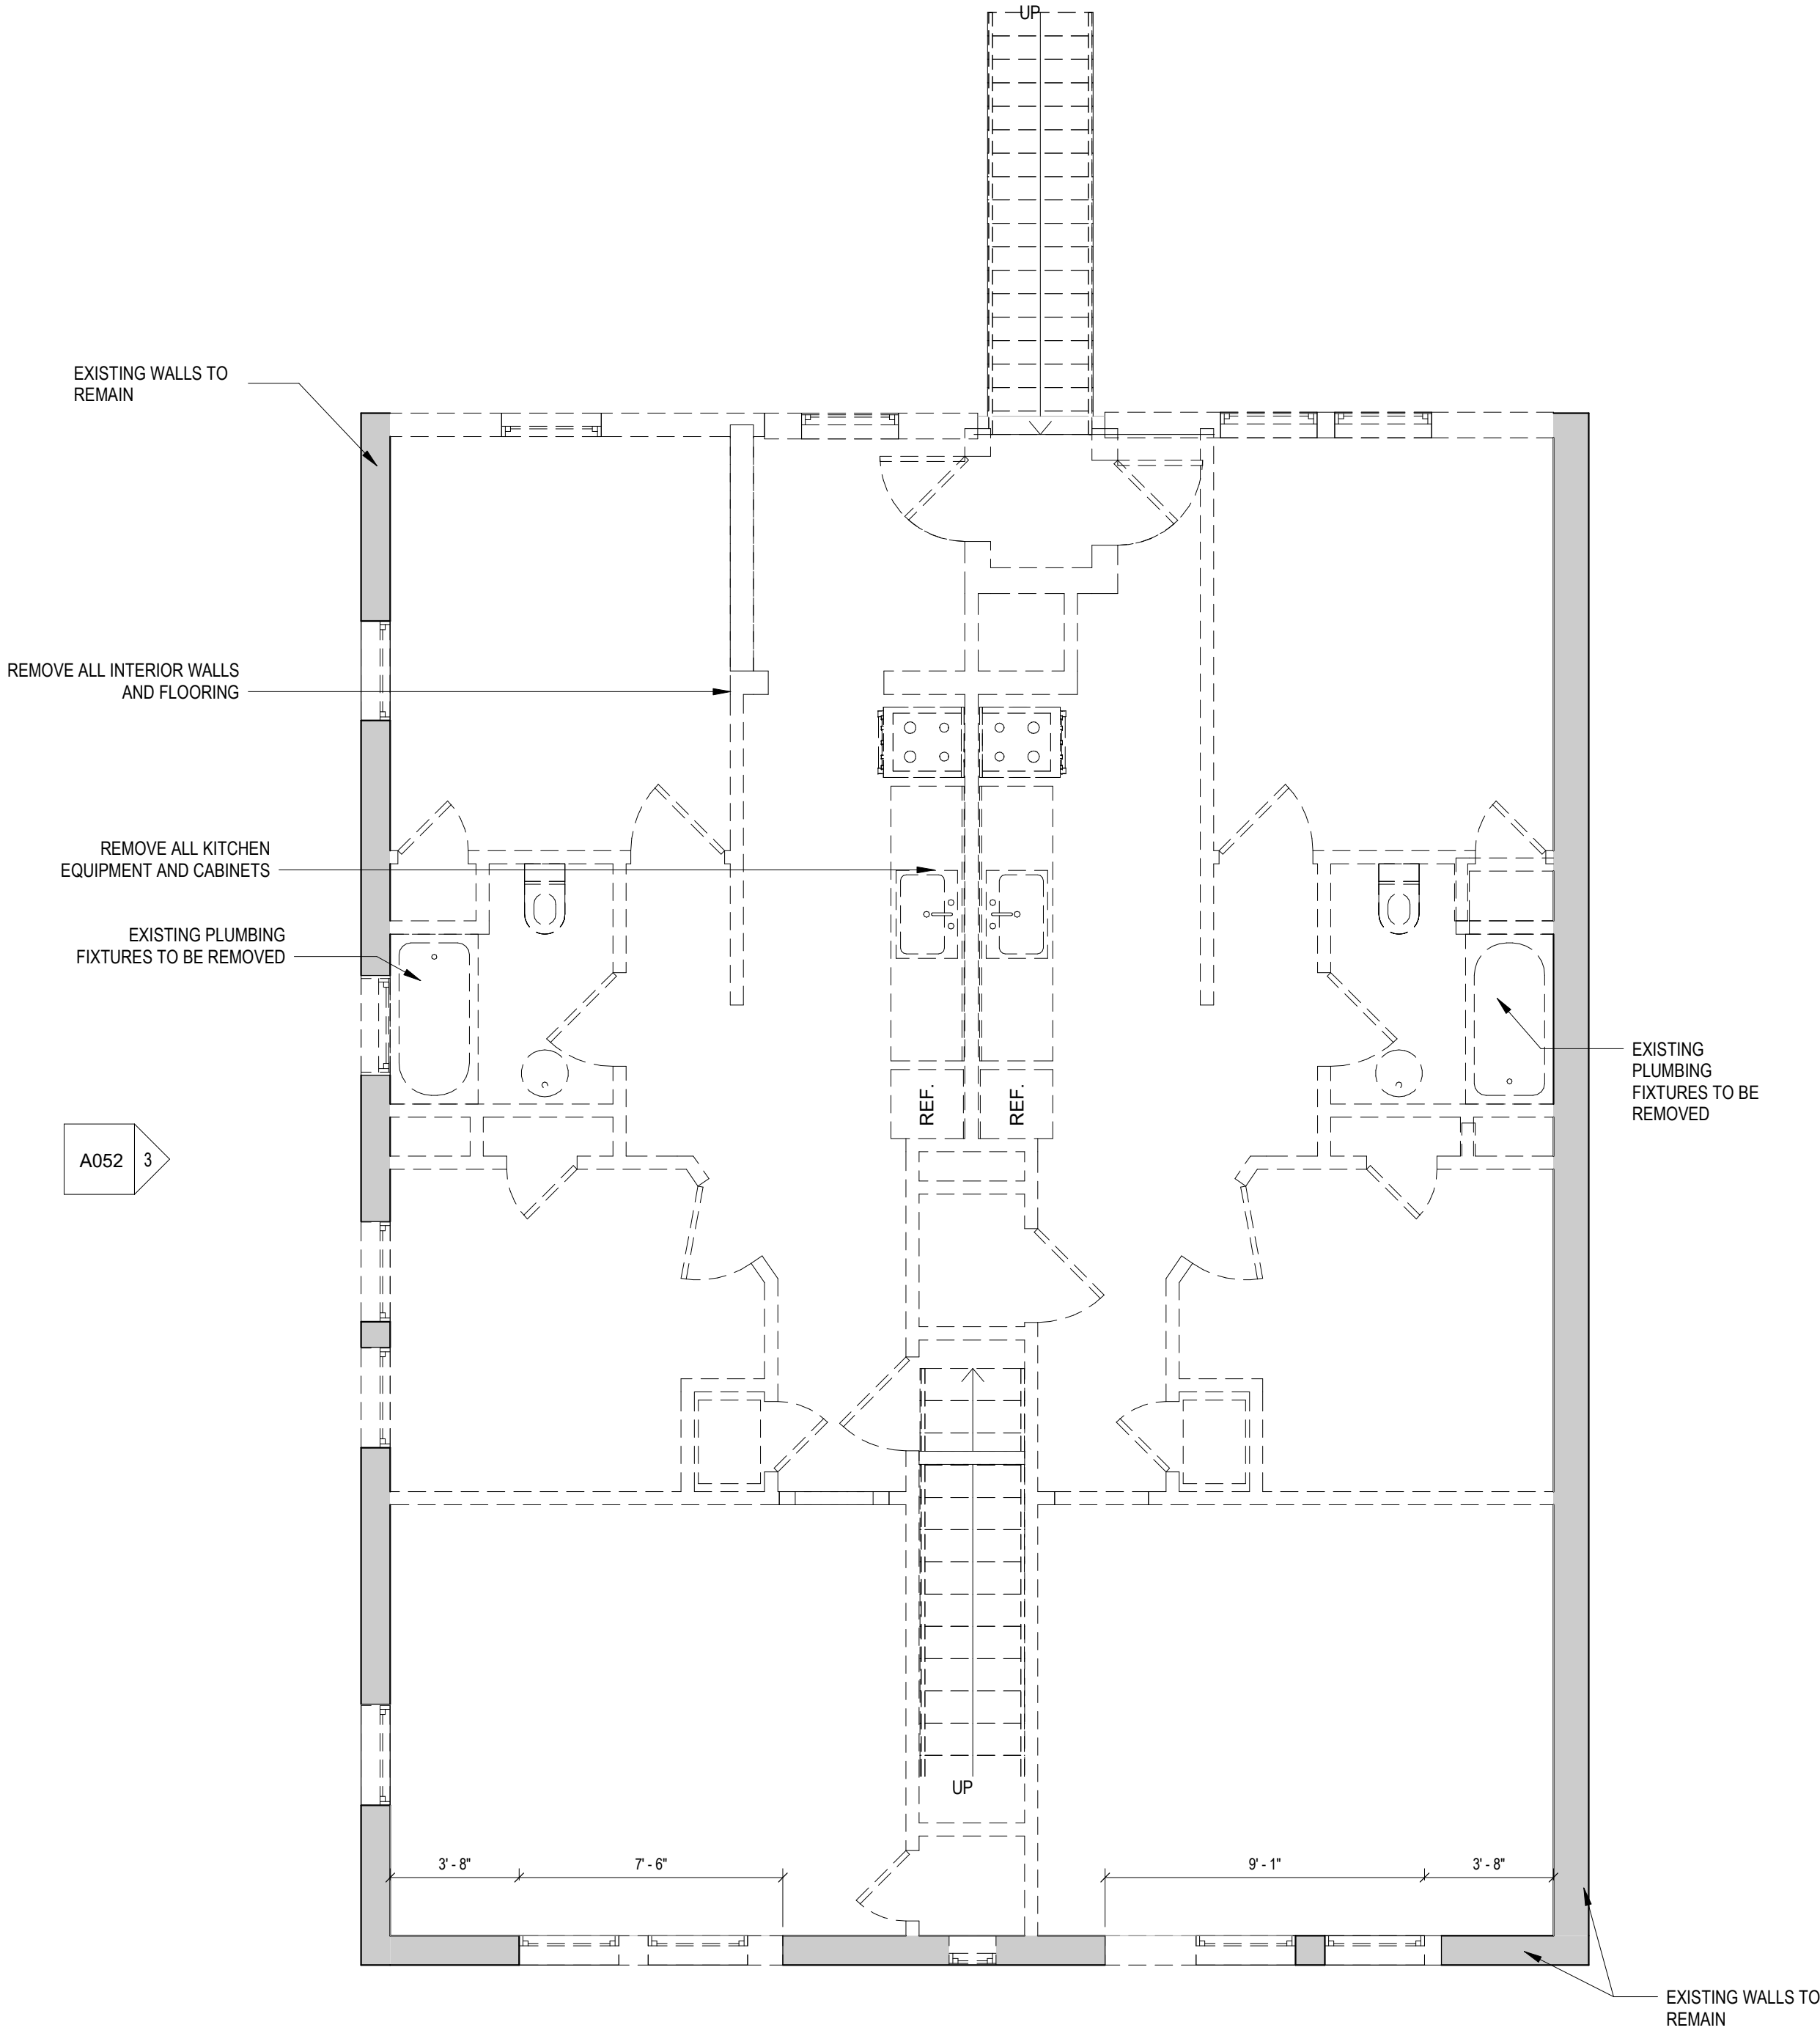

2 LEVEL 02 - FLOOR PLAN - DEMOLITION
1/4" = 1'-0"

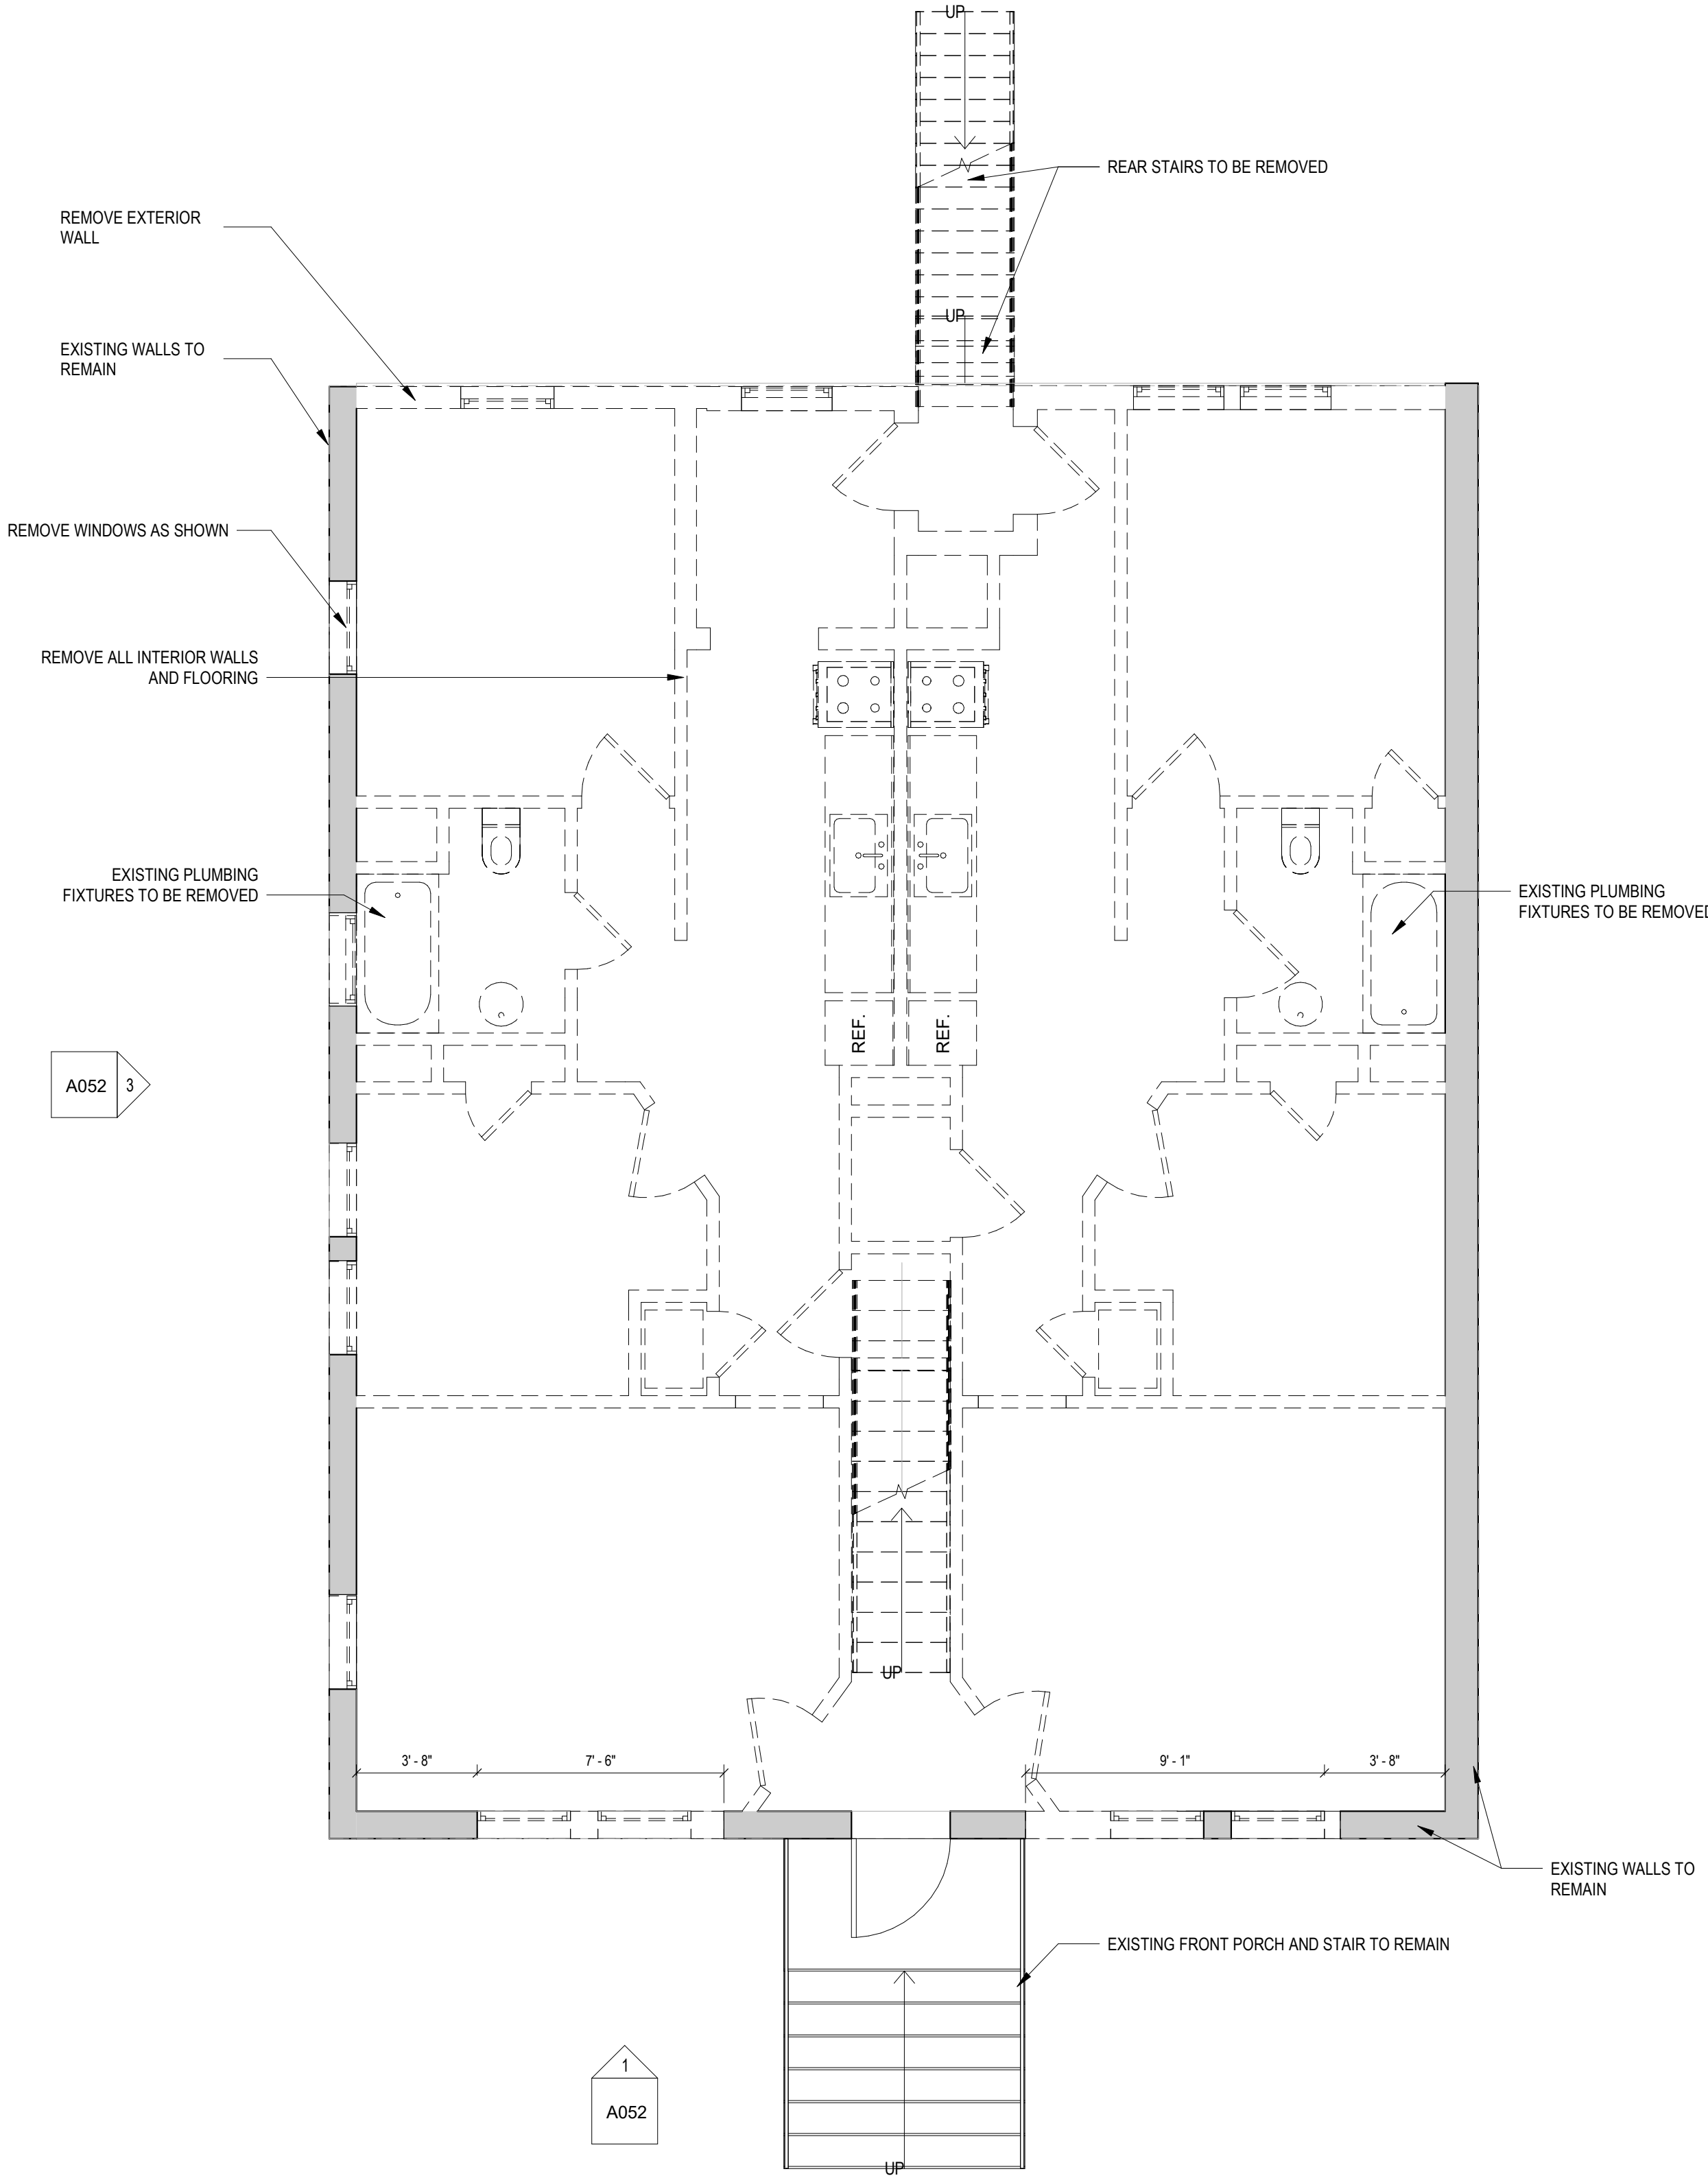

1 LEVEL 01 - FLOOR PLAN - DEMOLITION
1/4" = 1'-0"



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DRAWING DATA

PROJECT: 228RESIDENCES
ADDRESS: 228 RESIDENCES
228 HAMILTON STREET NW
WASHINGTON, DC 20011

SHEET SUBMISSION INDEX
ISSUE FOR PERMIT_ 04 APRIL 2022

| REV NO. | REVISION | DATE |
|---------|----------|------|
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SEAL &
SIGNATURE:

I AM RESPONSIBLE FOR DETERMINING THAT THE ARCHITECTURAL DESIGNS INCLUDED IN THIS APPLICATION ARE IN COMPLIANCE WITH ALL LAWS AND REGULATIONS OF THE DISTRICT OF COLUMBIA. I HAVE PERSONALLY PREPARED, OR DIRECTLY SUPERVISED THE DEVELOPMENT OF, THE ARCHITECTURAL DESIGNS INCLUDED IN THIS APPLICATION.

SHEET TITLE: DEMOLITIONS PLANS

PROJECT NO: 2021.175


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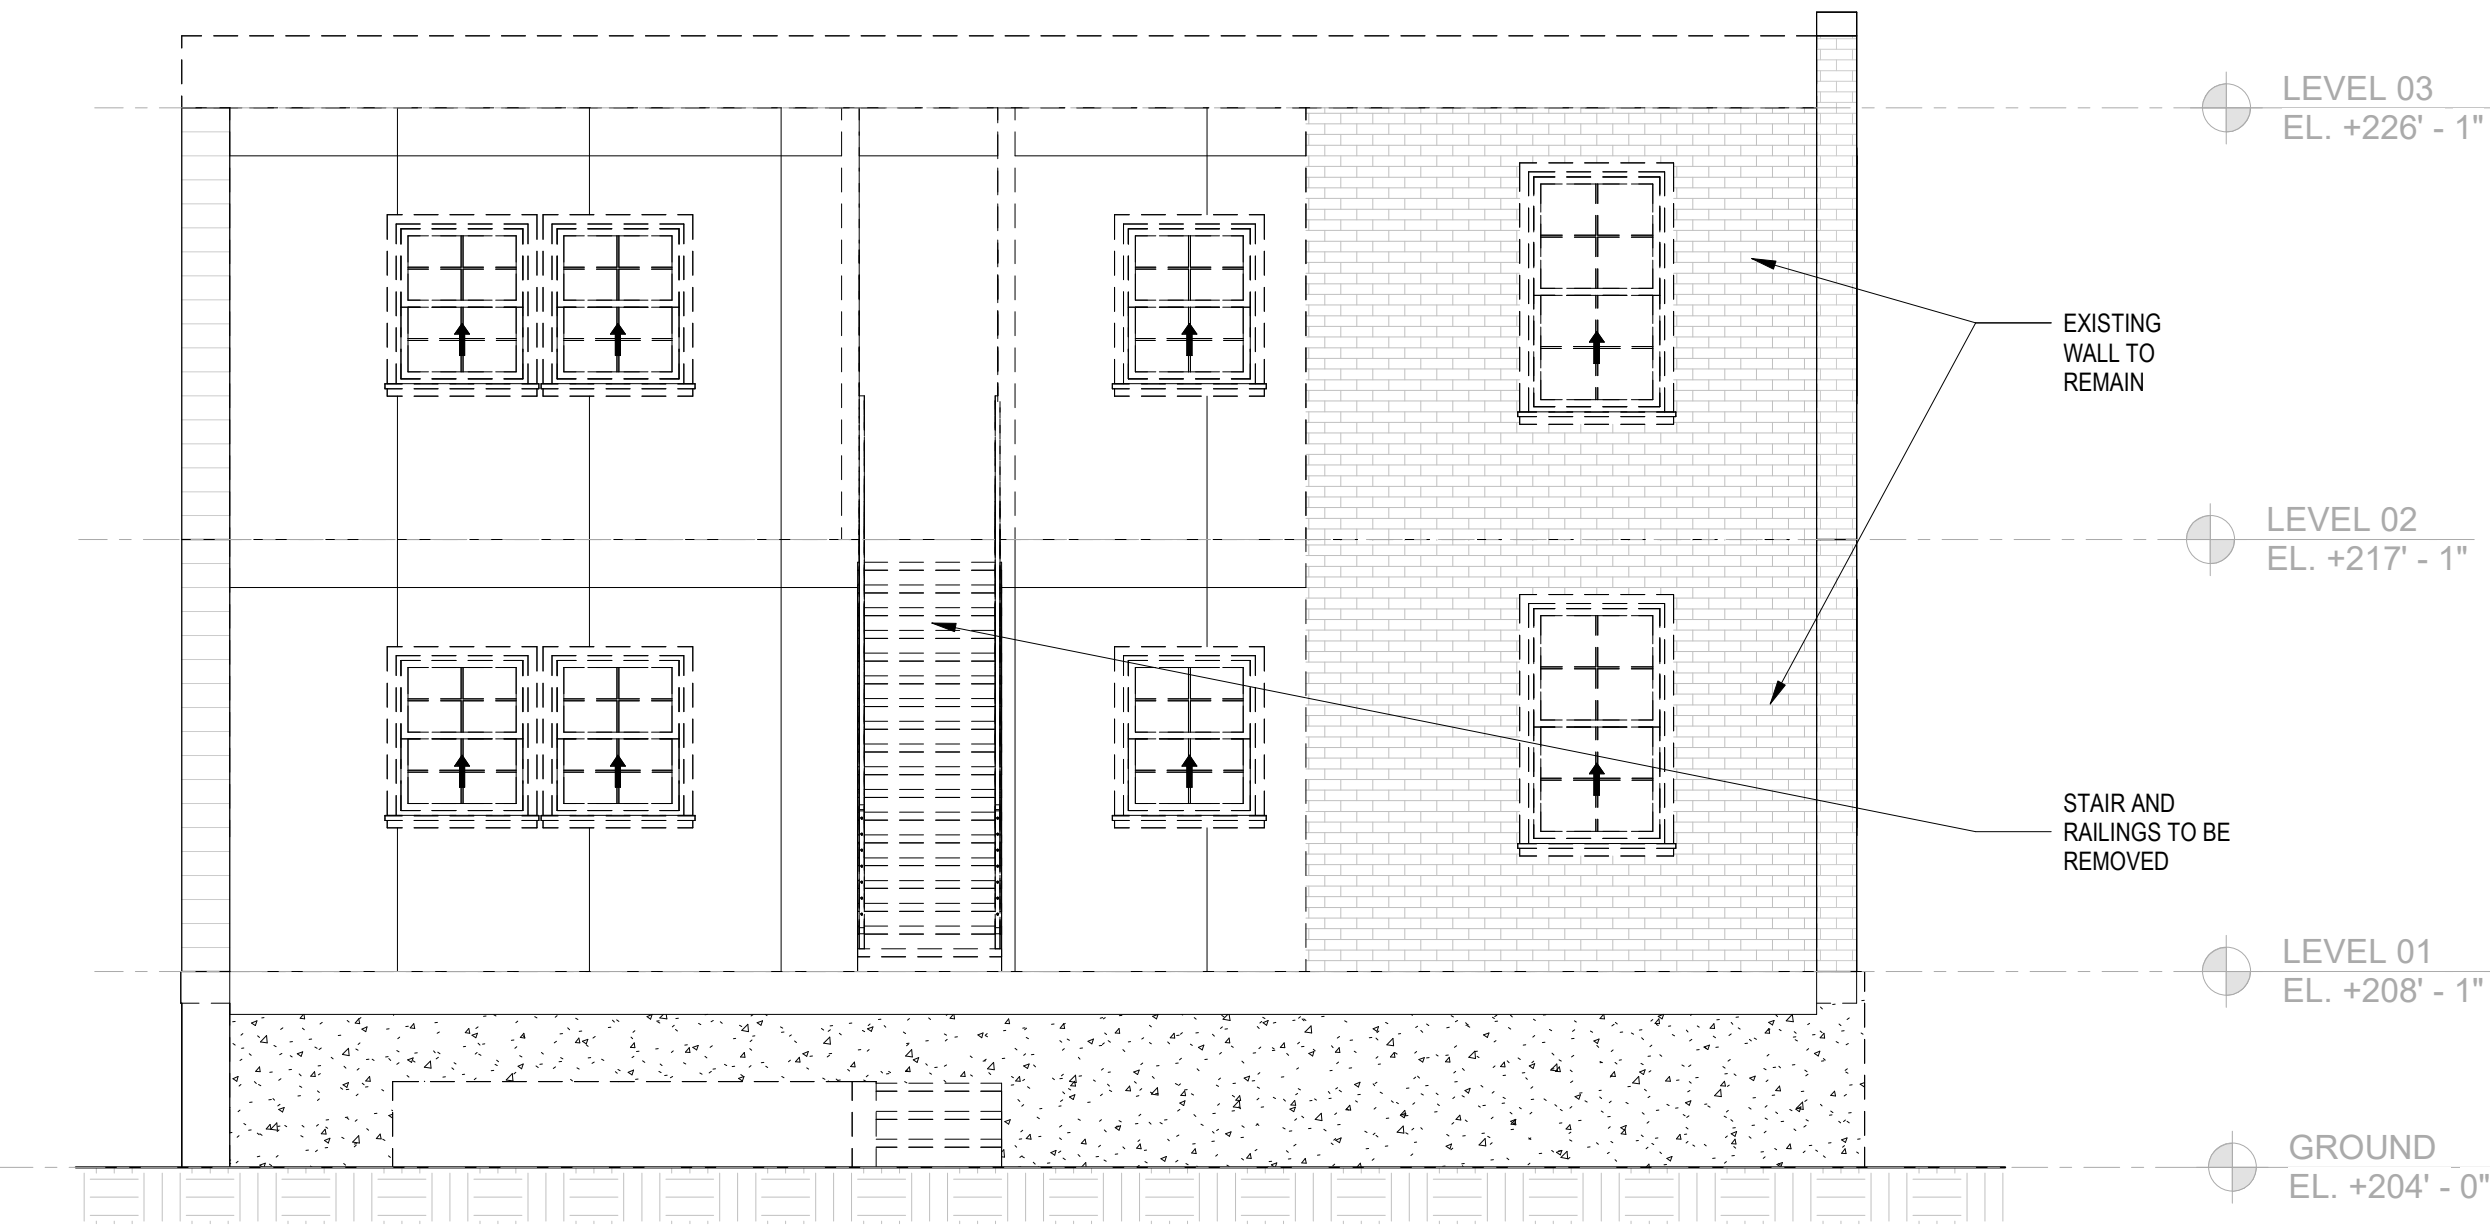
A051




EXISTING FRONT FACADE




EXISTING REAR FACADE

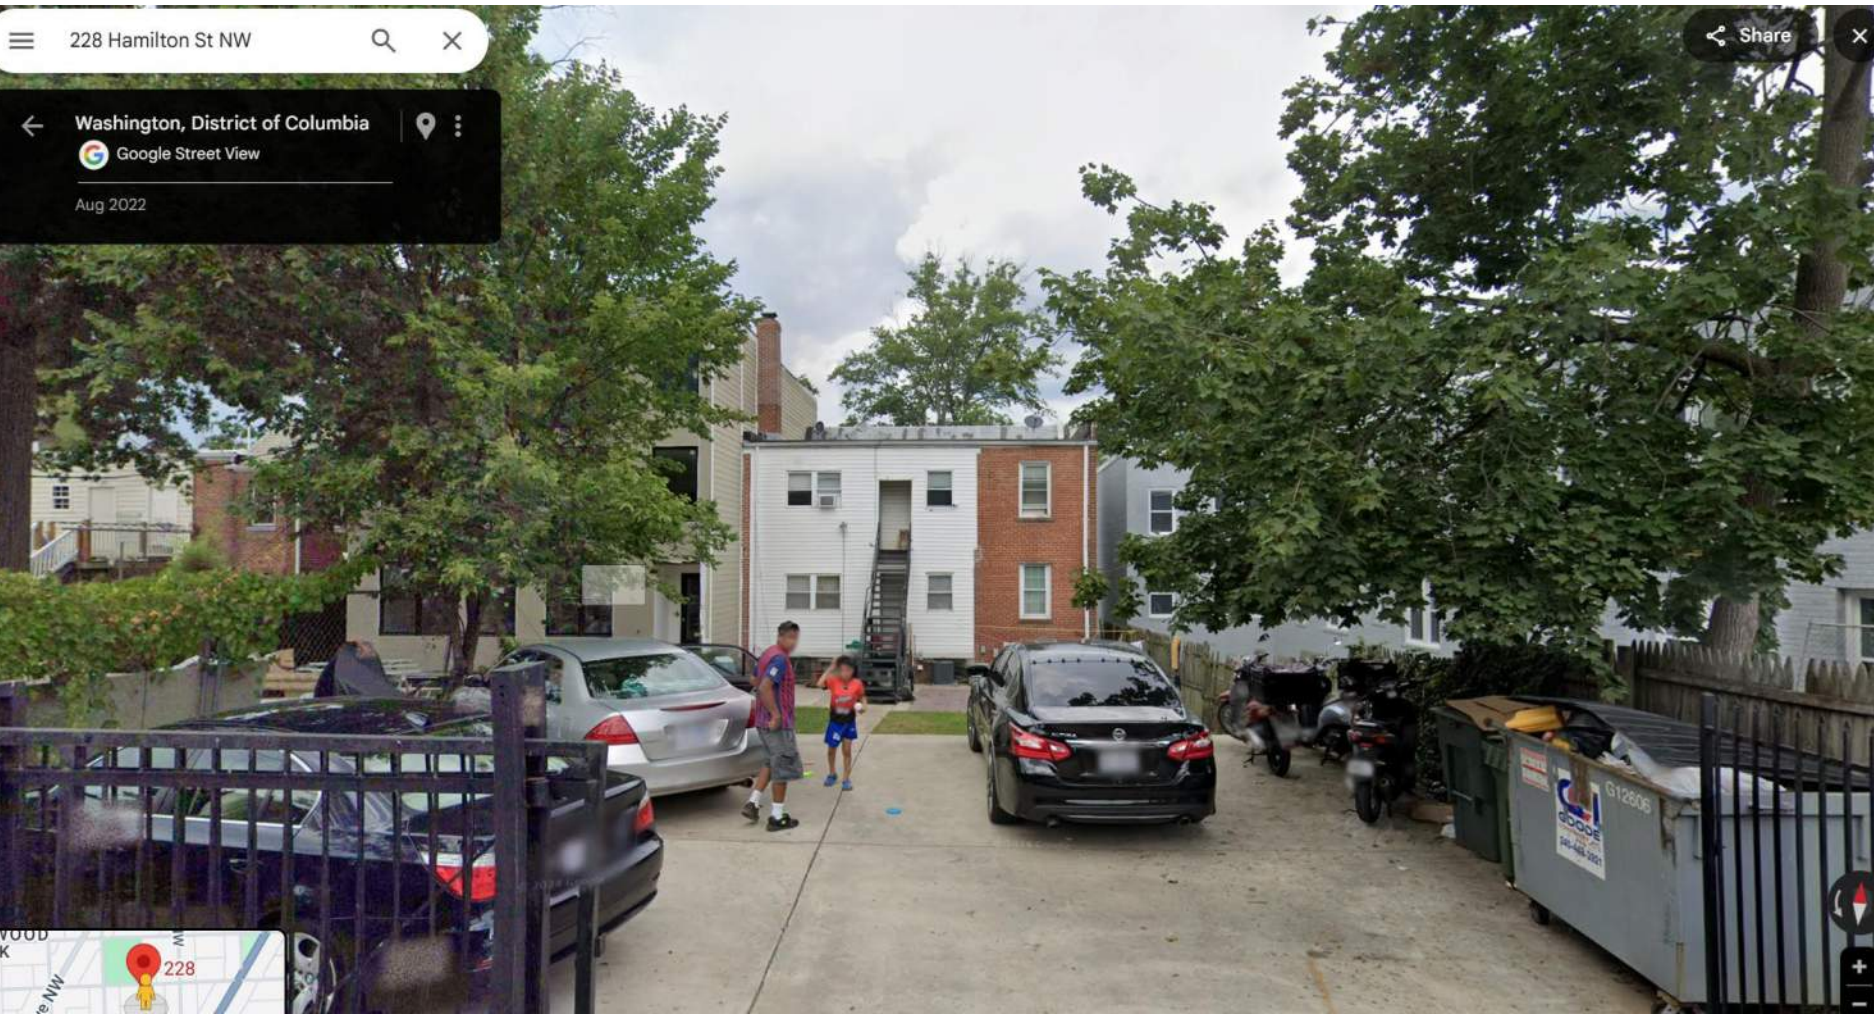

2 REAR ELEVATION - DEMOLITION
1/4" = 1'-0"

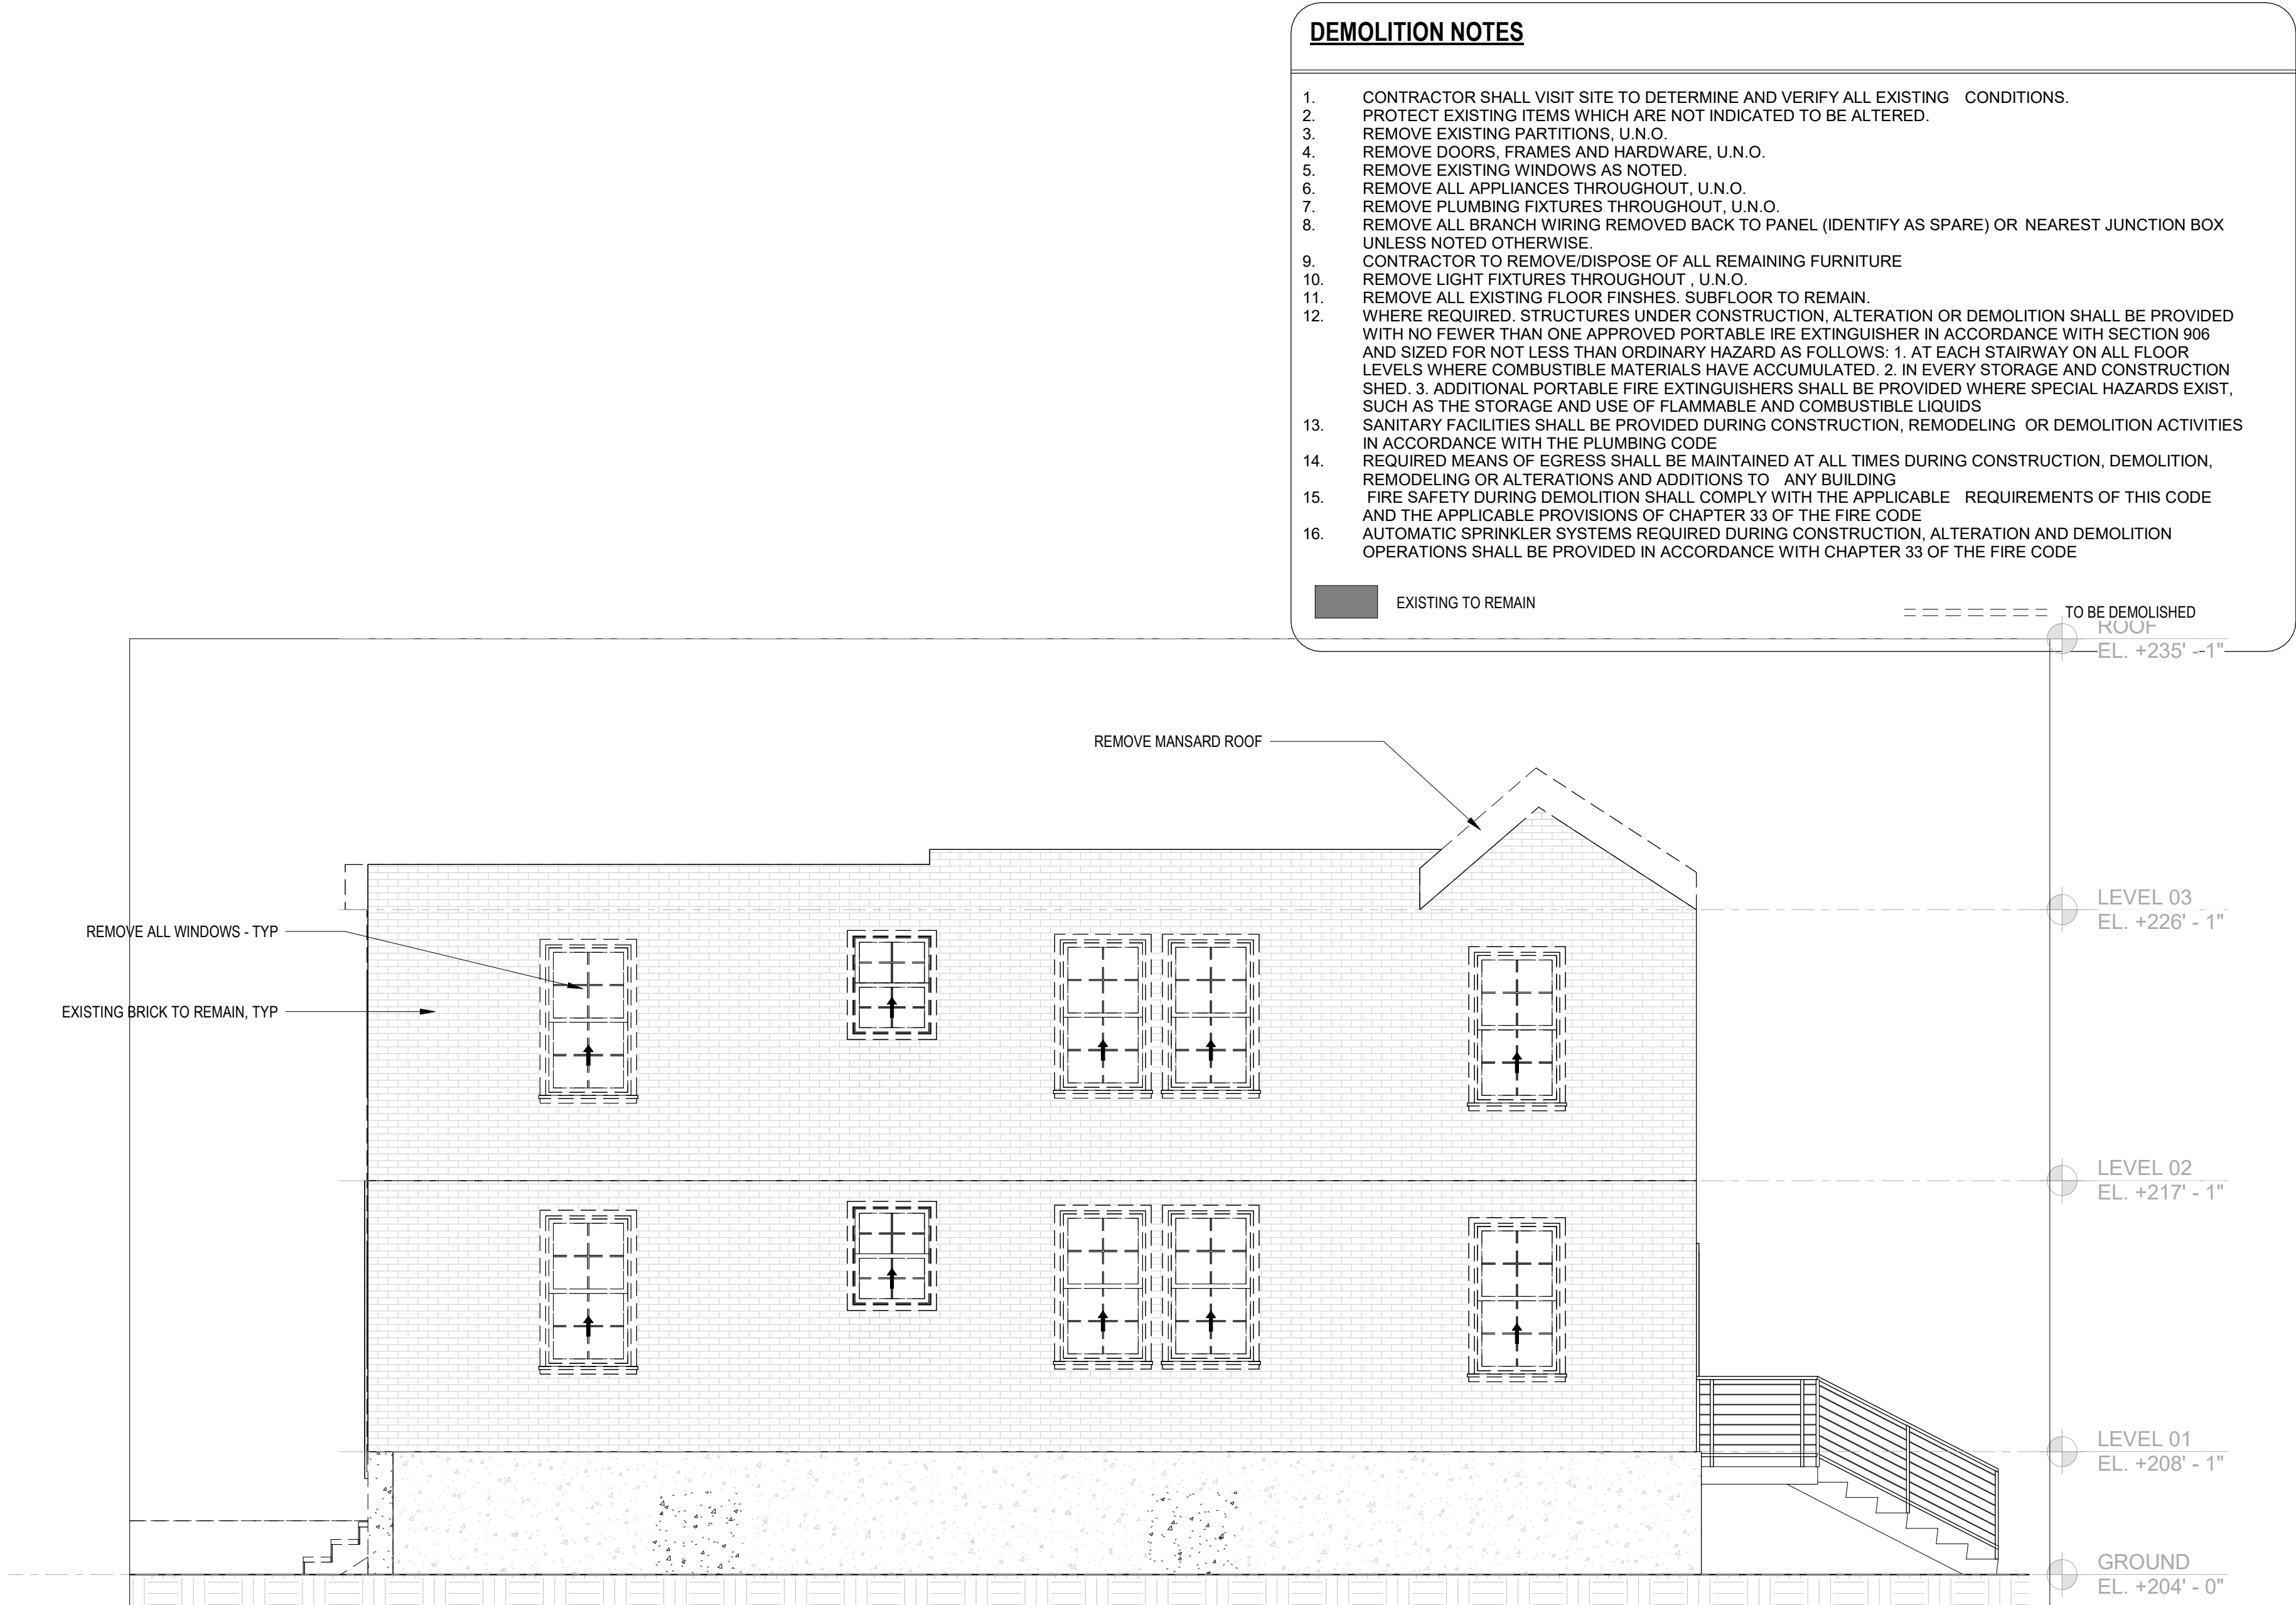

3 SIDE ELEVATION 1 - DEMOLITION
1/4" = 1'-0"

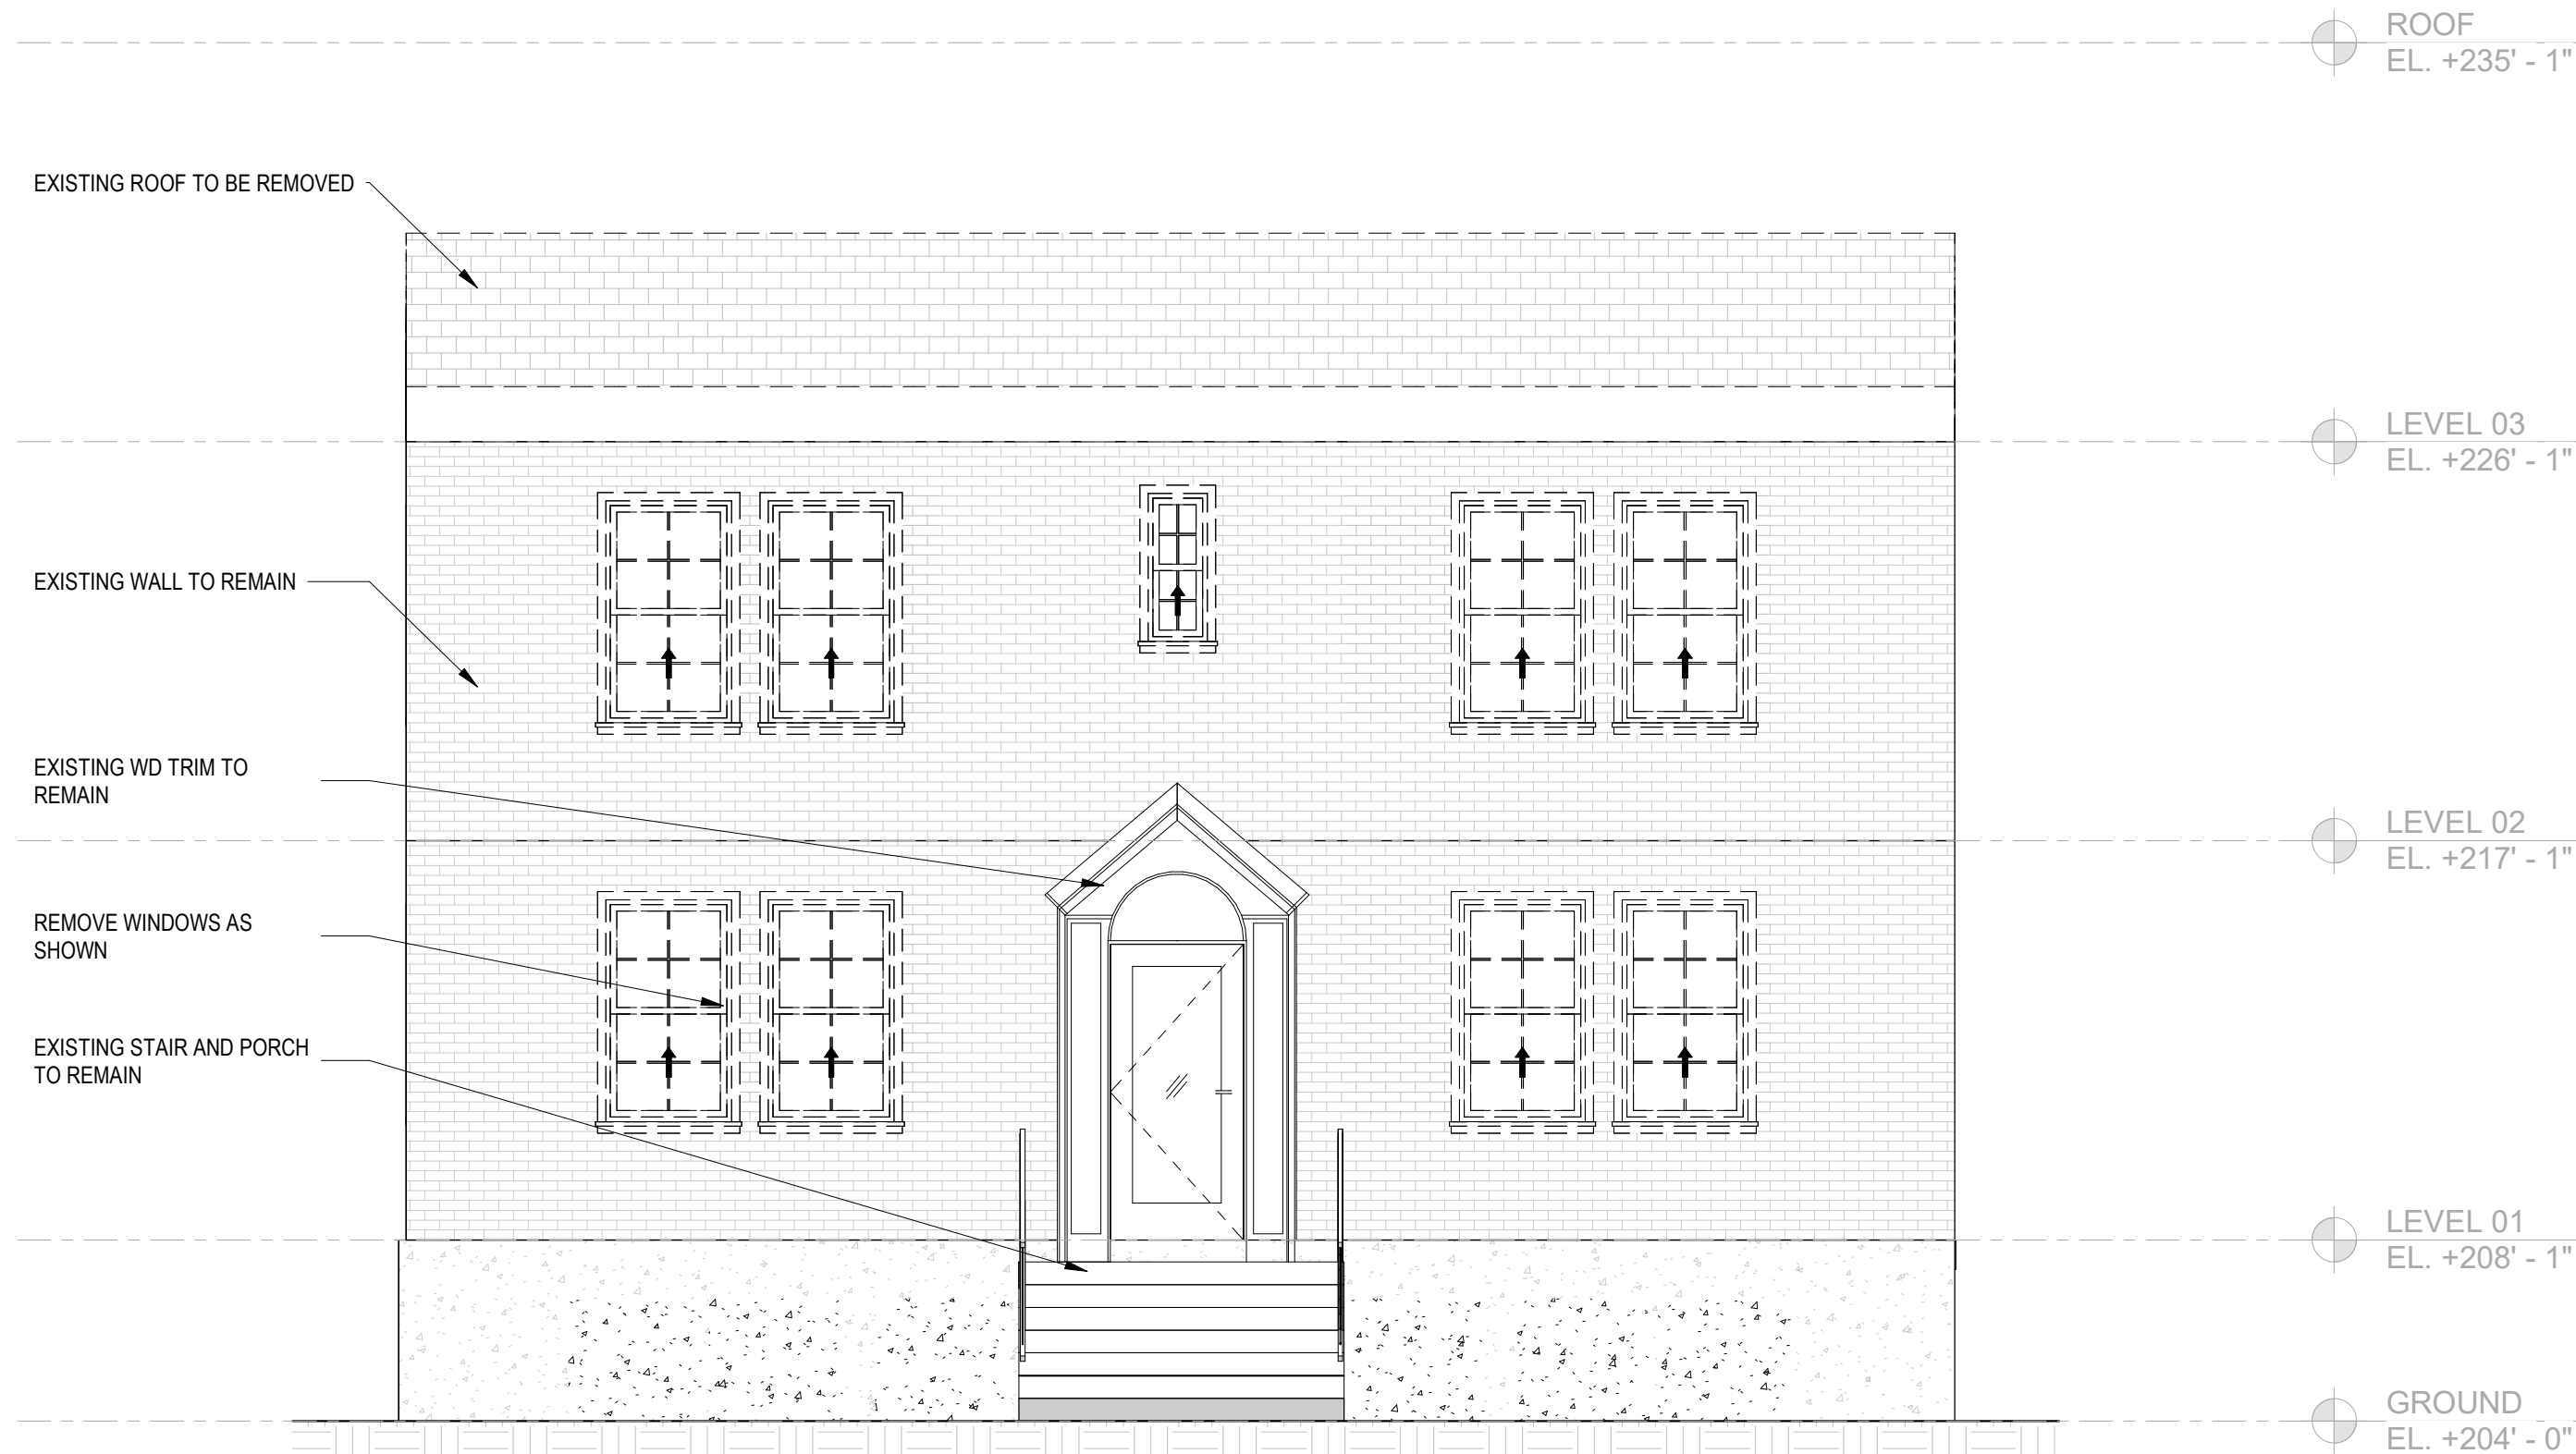

1 FRONT ELEVATION - DEMOLITION
1/4" = 1'-0"

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EXISTING TO REMAIN TO BE DEMOLISHED
EL. +235' - 1"

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ISSUE FOR PERMIT_04 APRIL 2022

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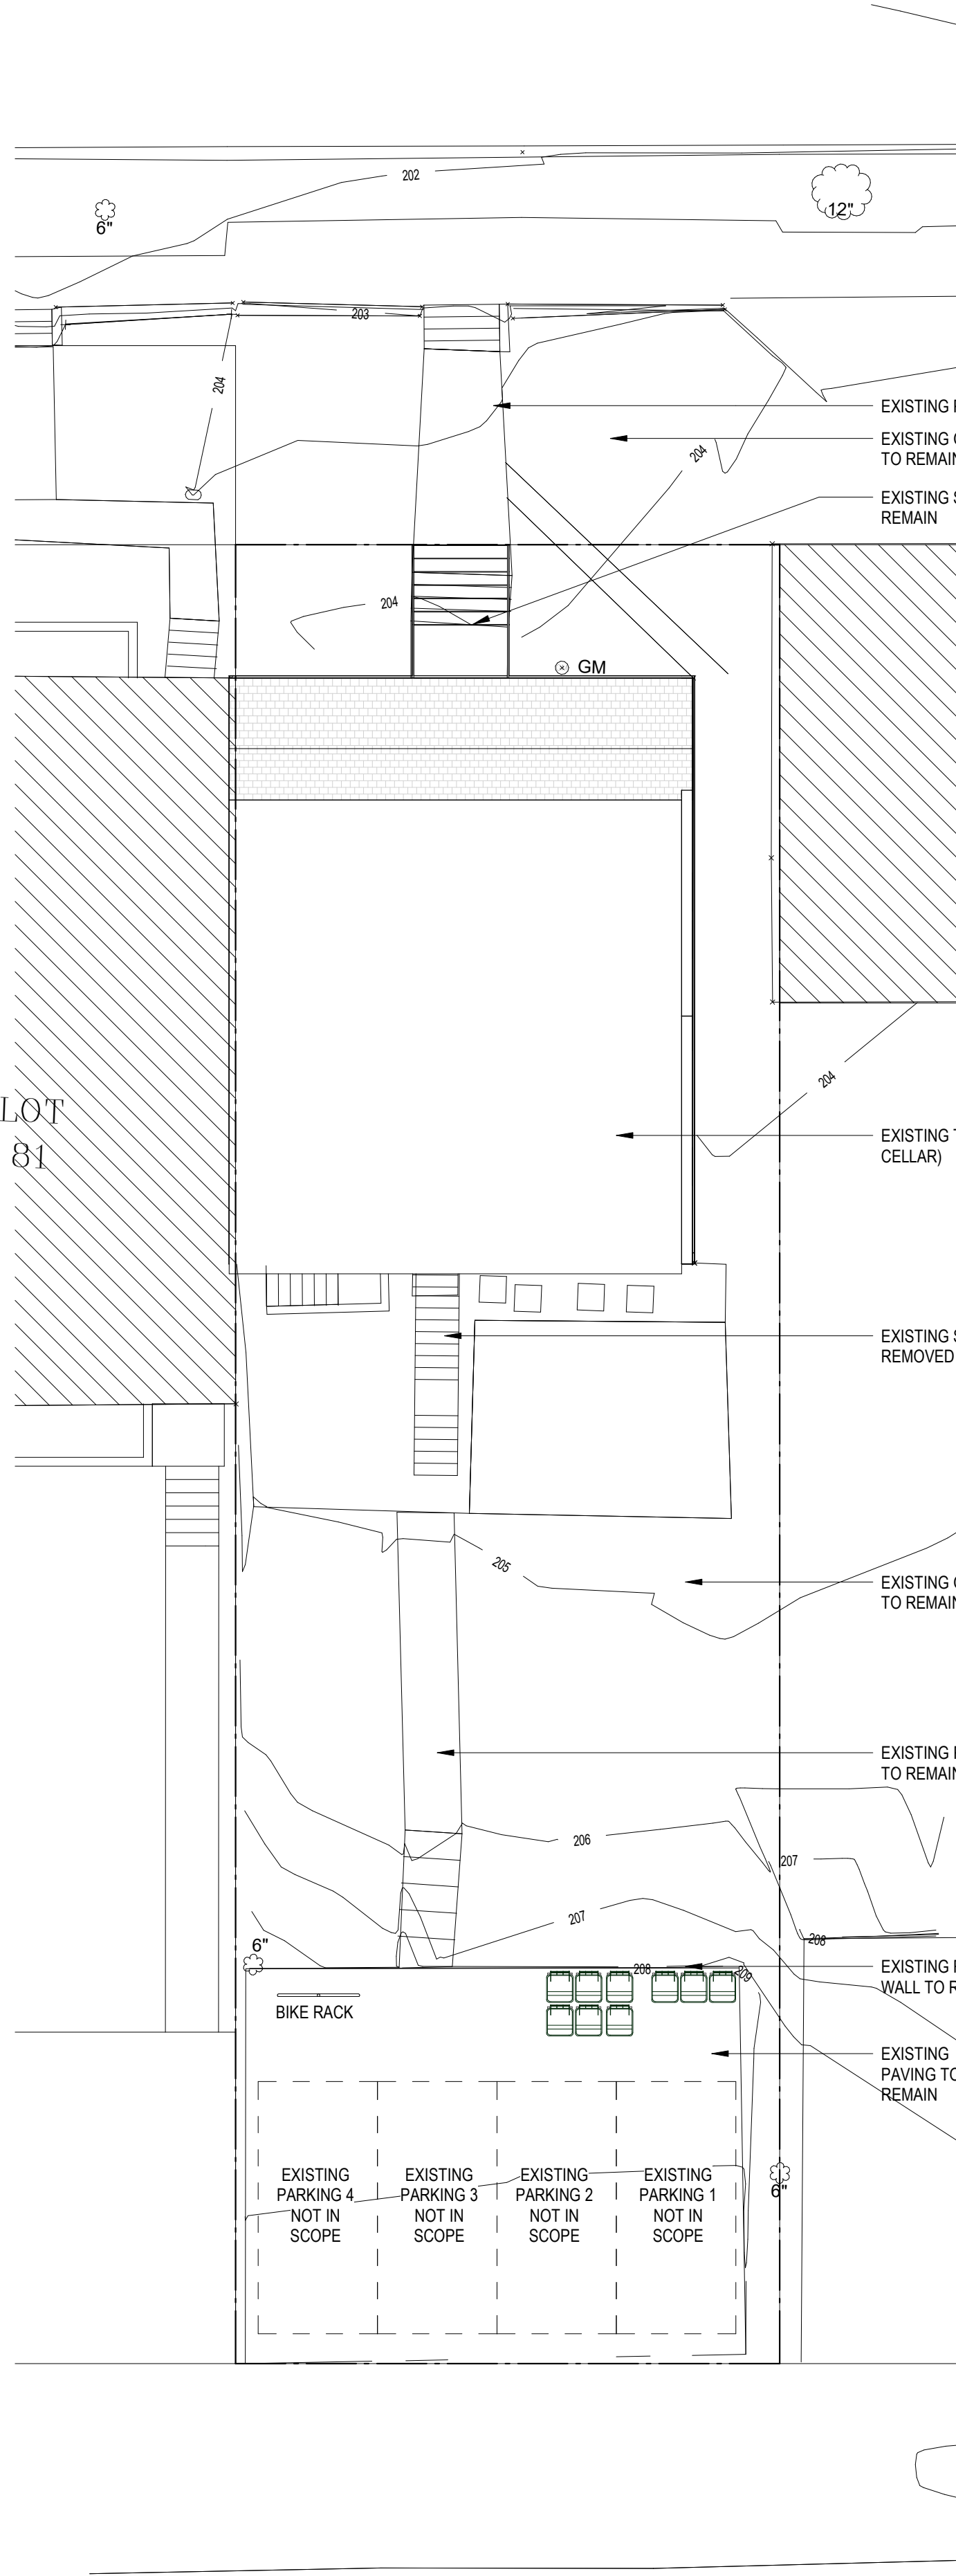
SHEET TITLE: DEMOLITION ELEVATIONS

PROJECT NO: 2021.175


DATE ISSUED: 04/05/2022

SCALE: As indicated

A052



2 SITE PLAN - EXISTING 1
1" = 10'-0"

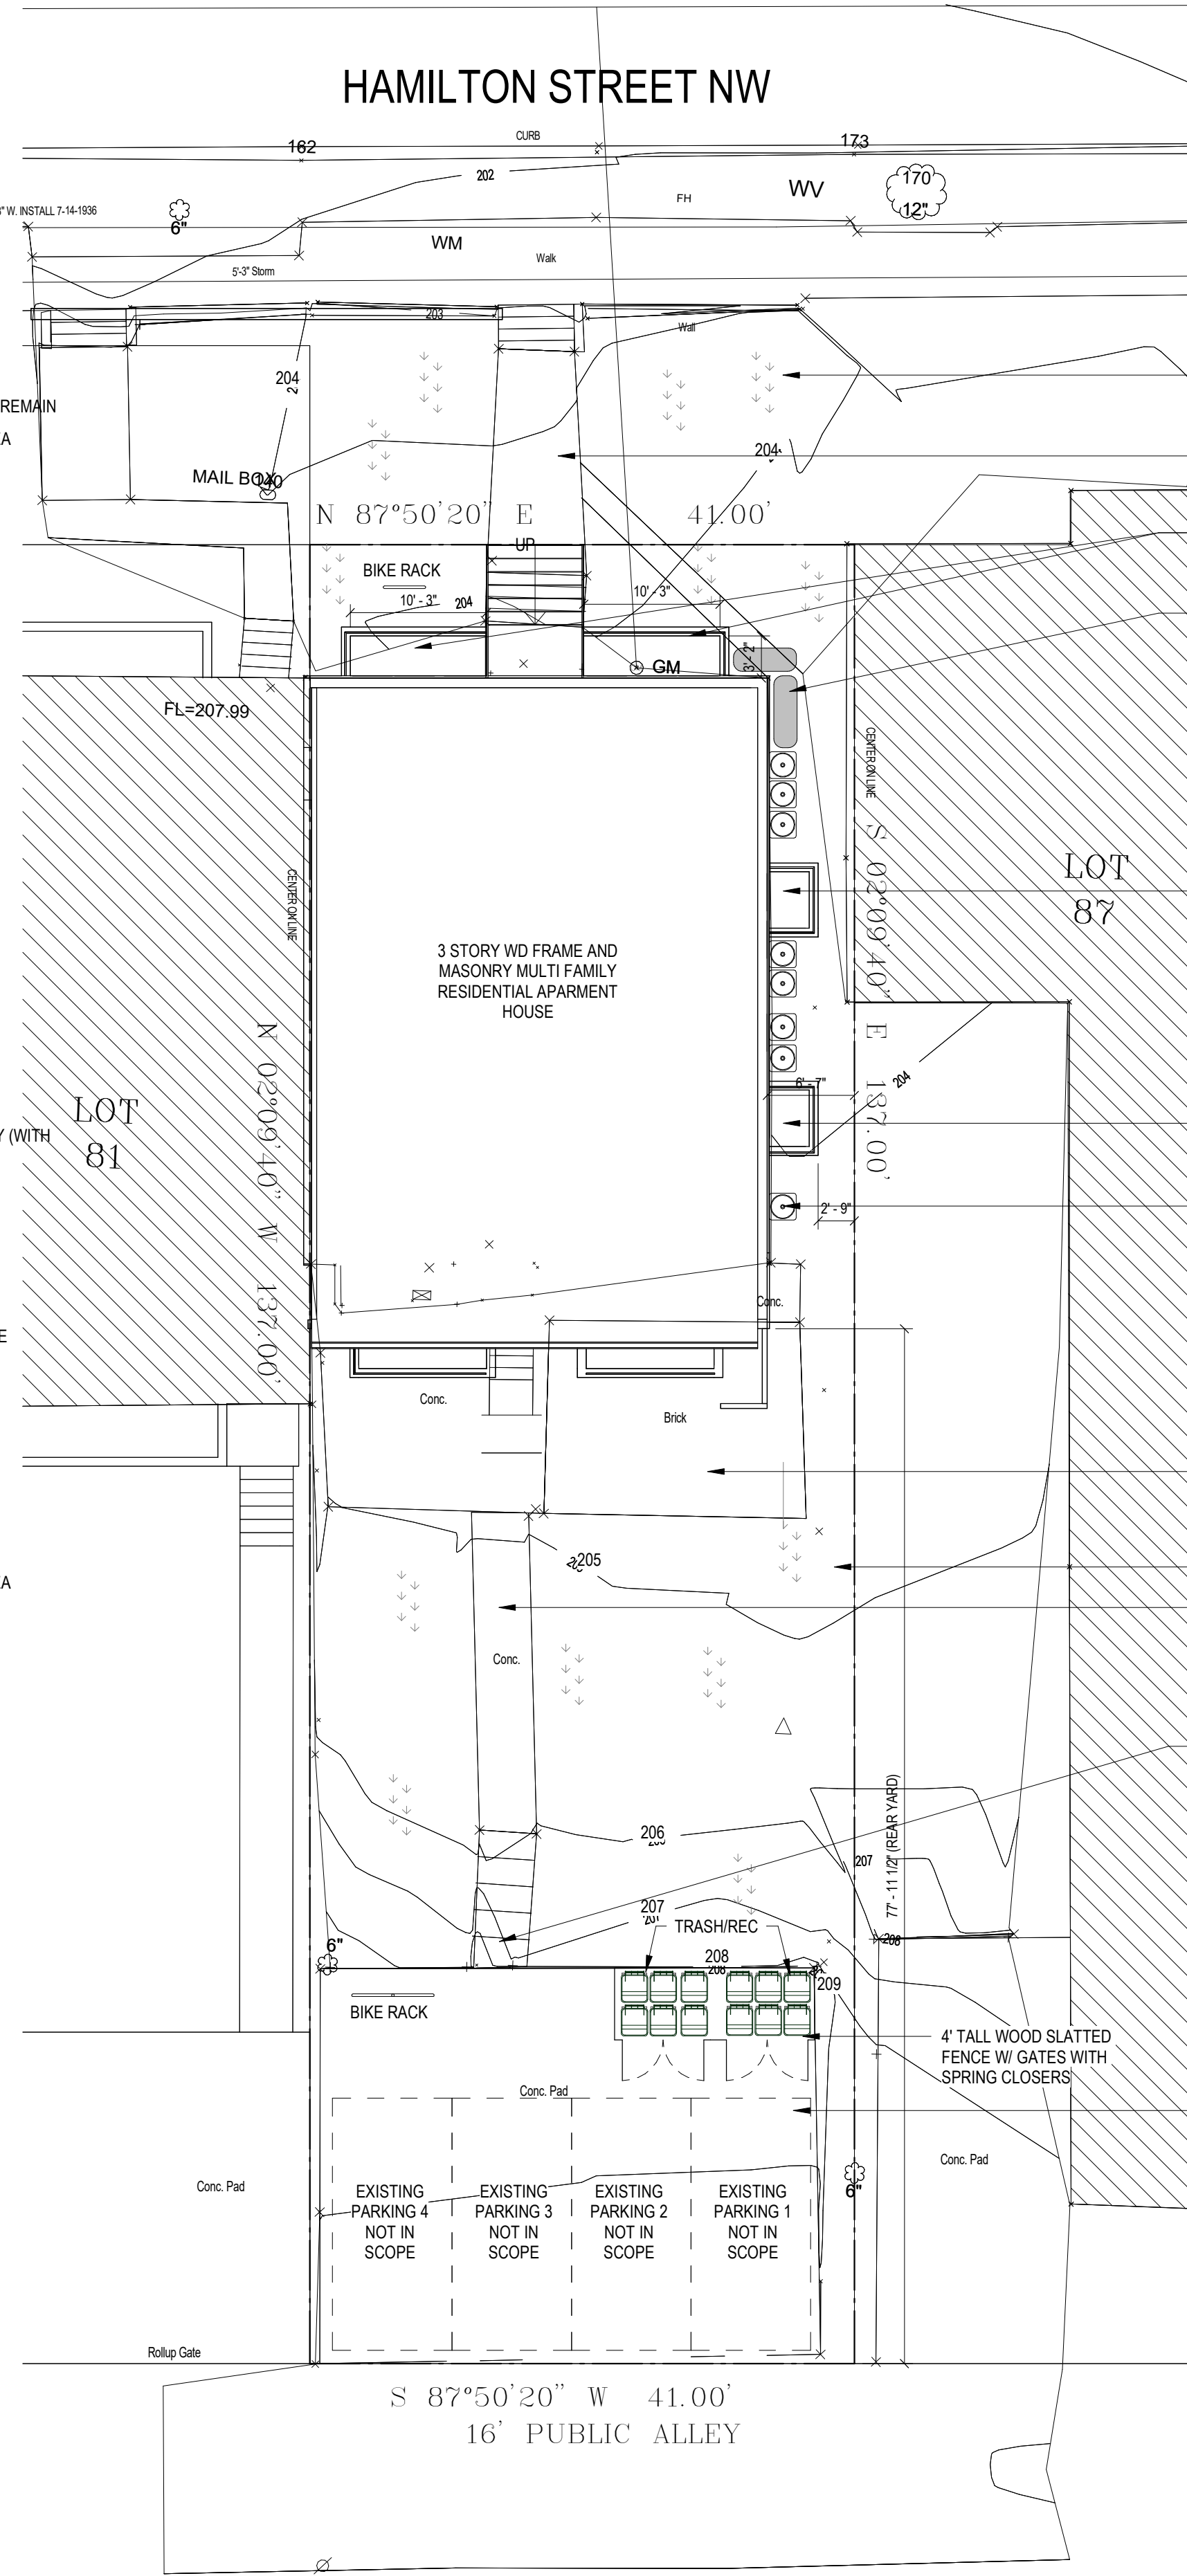

1 SITE PLAN - PROPOSED Copy 1
1" = 10'-0"

| SEQUENCE OF CONSTRUCTION A. CLEARING AND GRUBBING REQUIRED FOR PERIMETER CONTROLS; B. CONSTRUCTION OF PERIMETER CONTROLS; C. REMAINING CLEARING AND GRUBBING; D. ROAD GRADING; NOT APPLICABLE; E. GRADING FOR THE REMAINDER OF THE SITE; F. UTILITY INSTALLATION, INCLUDING THE USE OR BLOCKING OF STORM DRAINS AFTER CONSTRUCTION IF APPLICABLE; G. FINAL GRADING, LANDSCAPING, OR STABILIZATION; AND H. REMOVAL OF CONTROLS. | CIVIL NARRATIVE: EXISTING PARKING PAD AND SITE PAVING TO REMAIN. SCOPE INCLUDES DIG OUT OF EXISTING CELLAR, AREA WELLS ACCESSING CELLAR UNITS AND REAR ADDITION | | |--|---|---------------|--|--|----------|----------|--|-----------------|---------|--|--|-------------------------|---------------|---------------|--|---------------------------|---------------|---------------|--|------------------------|---------------|---------------|--|-------------------|--|------------|
| | CIVIL CALCULATION TABLE: <table><tr><th></th><th>EXISTING</th><th>PROPOSED</th><th></th></tr><tr><td>TOTAL LOT AREA:</td><td>5617 SF</td><td></td><td></td></tr><tr><td>TOTAL PERVIOUS SURFACE:</td><td>48% - 2671 SF</td><td>42% - 2364 SF</td><td></td></tr><tr><td>TOTAL BUILDING FOOTPRINT:</td><td>27% - 1542 SF</td><td>30% - 1681 SF</td><td></td></tr><tr><td>TOTAL PAVED FOOTPRINT:</td><td>25% - 1404 SF</td><td>28% - 1572 SF</td><td></td></tr><tr><td>EXCAVATION VOLUME</td><td></td><td>3362 CU.FT</td><td></td></tr></table> | | | | EXISTING | PROPOSED | | TOTAL LOT AREA: | 5617 SF | | | TOTAL PERVIOUS SURFACE: | 48% - 2671 SF | 42% - 2364 SF | | TOTAL BUILDING FOOTPRINT: | 27% - 1542 SF | 30% - 1681 SF | | TOTAL PAVED FOOTPRINT: | 25% - 1404 SF | 28% - 1572 SF | | EXCAVATION VOLUME | | 3362 CU.FT |
| | EXISTING | PROPOSED | | | | | | | | | | | | | | | | | | | | | | | | |
| TOTAL LOT AREA: | 5617 SF | | | | | | | | | | | | | | | | | | | | | | | | | |
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| EXCAVATION VOLUME | | 3362 CU.FT | | | | | | | | | | | | | | | | | | | | | | | | |
| | CIVIL PLAN LEGEND | | | | | | | | | | | | | | | | | | | | | | | | | |
| | - GRASS AND OTHER PERVIOUS VEGETATIVE SURFACE | | | | | | | | | | | | | | | | | | | | | | | | | |



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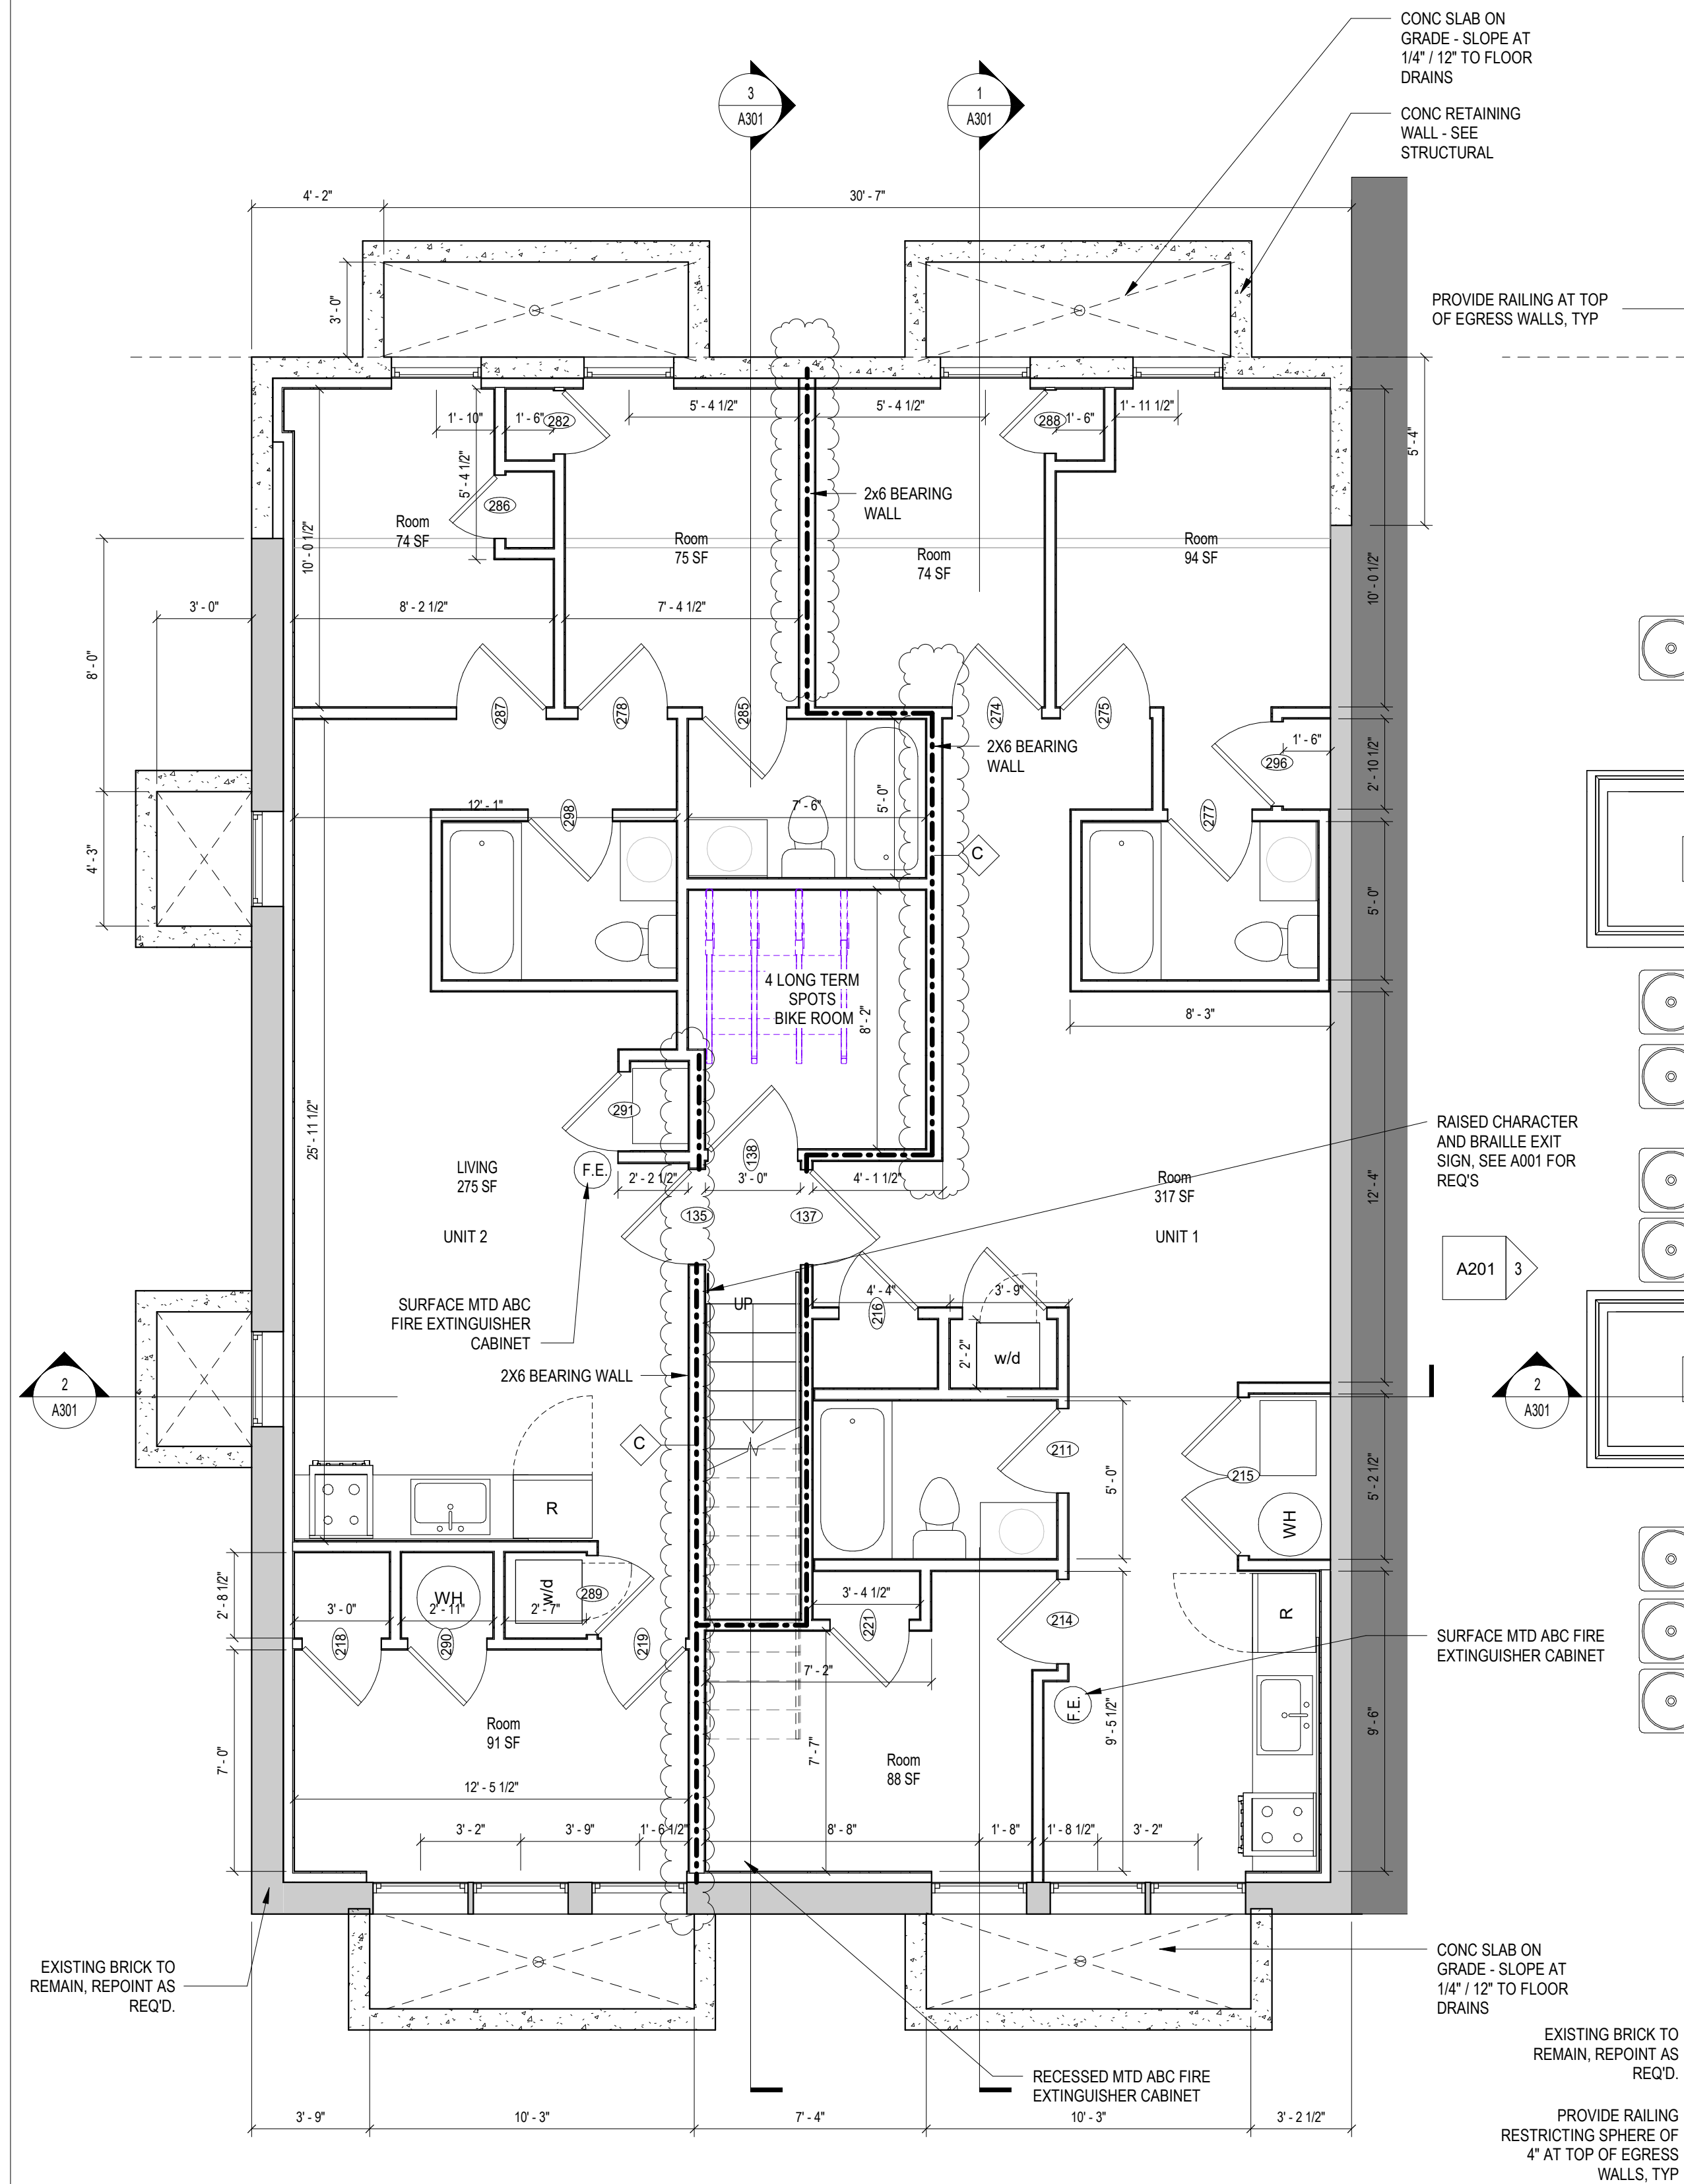
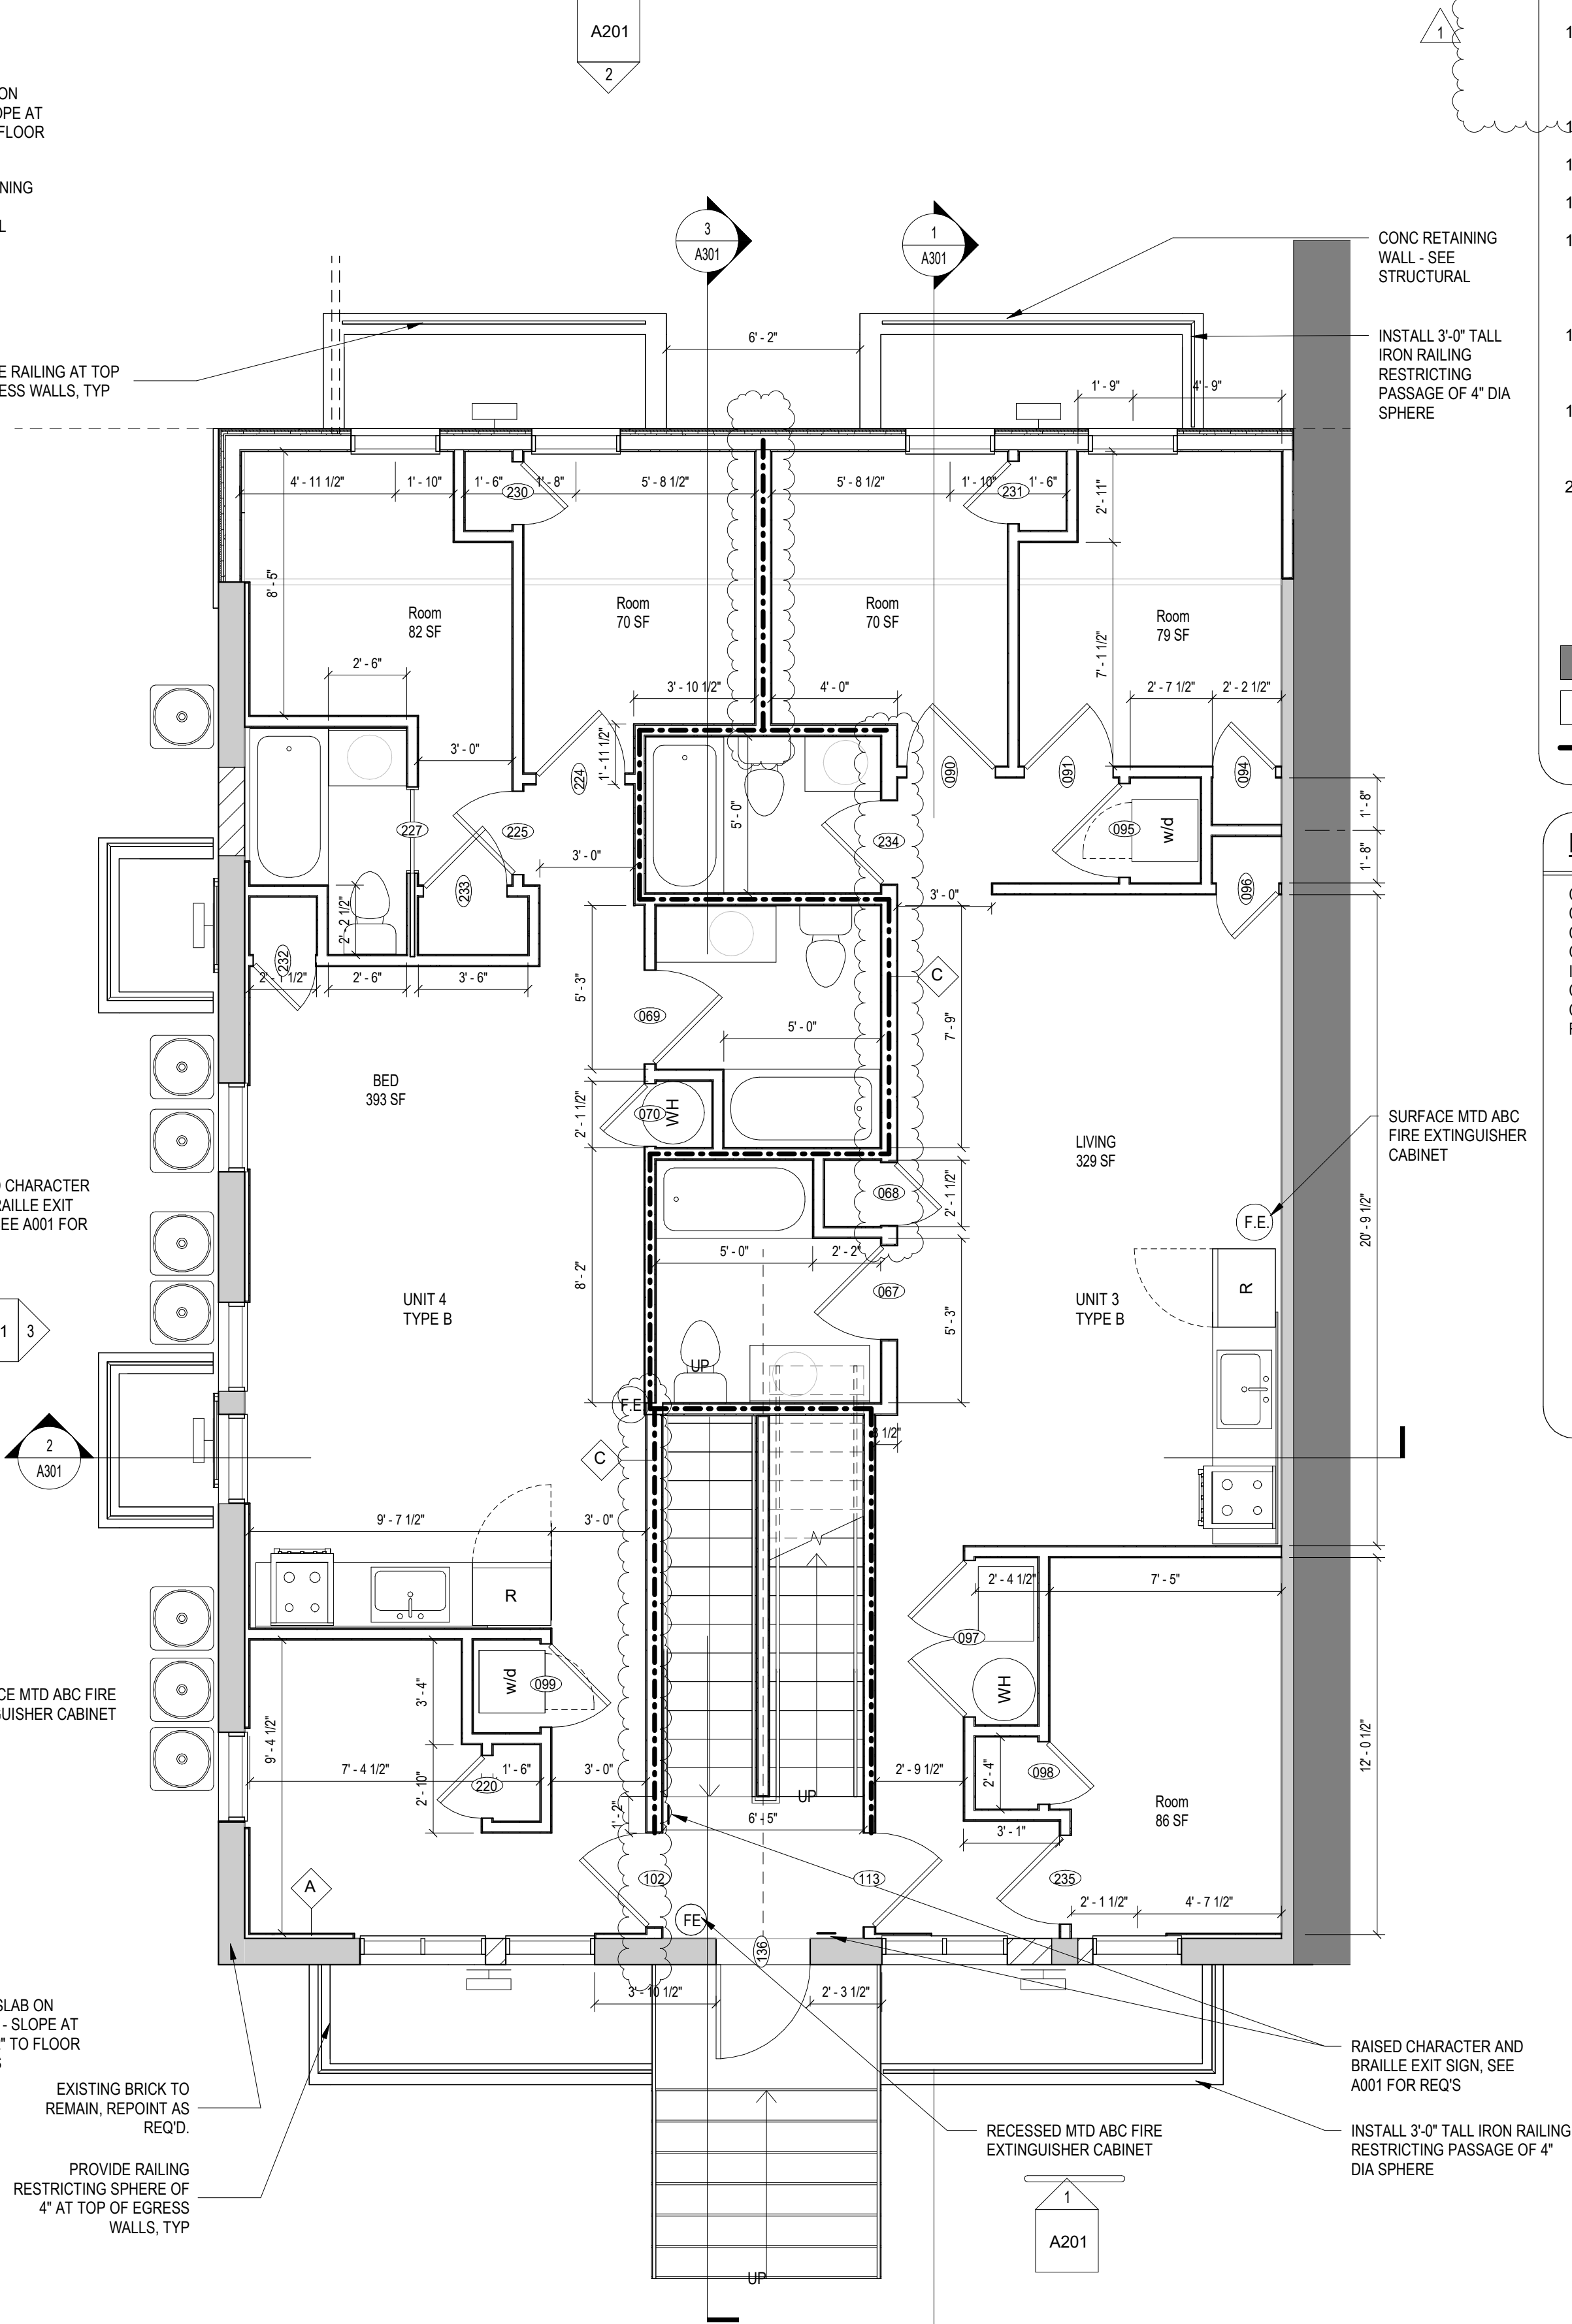
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SHEET TITLE: SITE PLAN
PROJECT NO: 2021.175
DATE ISSUED: 04/05/2022
SCALE: 1" = 10'-0"

A100

3 CELLAR - FLOOR PLAN - PROPOSED Copy 1
1/4" = 1'-0"4 LEVEL 01 - FLOOR PLAN - PROPOSED Copy 1
1/4" = 1'-0"

CONSTRUCTION GENERAL NOTES

- ALL DIMENSIONS TO FINISH FACE, U.N.O.
- ALL INTERIOR PARTITIONS TO BE TYPE A, U.N.O. SEE GI.01 FOR PARTITION SCHEDULE
- ALL INTERIOR WALLS TO BE PAINTED, U.N.O.
- ALL CEILINGS TO BE 5/8" GWB - PAINTED - FLAT FINISH
- ALL WALLS TO BE PAINTED - EGGSHELL FINISH
- REPAIR ALL WALLS EXISTING TO REMAIN AS REQUIRED
- SEE ELEVATIONS FOR WINDOW TAGS
- PROVIDE ARC-FAULT PROTECTION FOR ALL LIVING SPACE OUTLETS TO COMPLY
- ALL FLOORING TO BE CONTINUOUS HARDWOOD SPECIFIED BY OWNER, U.N.O.
- REPLACE ALL EXISTING WINDOWS W LOW-E GLASS WINDOWS
- GC TO VERIFY INSULATION OF EXISTING EXTERIOR WALLS TO REMAIN MEETS R8/13 ACCORDING TO 2017 IECC 402.1.1
- AIR LEAKAGE RATE NOT TO EXCEED 3 AIR CHANGES PER HOUR, GC TO TEST BUILDING THERMAL ENVELOP IN ACCORDANCE WITH 2017 IECC 402.4.1.2
- GC TO PROVIDE NO FEWER THAN ONE APPROVE PORTABLE FIRE EXTINGUISHERS IN ACCORDANCE WITH SECTION 906. AREAS TO HAVE FIRE EXTINGUISHERS AS FOLLOWS: EA. STAIRWAY FLOOR LEVEL, STORAGE AND CONSTRUCTION SHED, WHERE SPECIAL HAZARDS EXIST. SEE PLAN FOR FIRE EXTINGUISHER (F.E.) LOCATIONS
- GC TO PROVIDE PORTABLE FIRE EXTINGUISHERS IN WALL KITCHEN AREAS IN RECESSED JL ORBIT LOW PROFILE CABINET @ 48" AFF
- HANDRAILS AND GUARDS SHALL BE DESIGNED TO RESIST A LINEAR LOAD OF 50 POUNDS PER LINEAR FOOT (PLF) (0.73 KN/M). HANDRAILS AND GUARDS SHALL BE DESIGNED TO RESIST A CONCENTRATED LOAD OF 200 POUNDS (0.89 KN)
- WALLS, PARTITIONS, AND FLOOR/CEILING ASSEMBLIES SEPARATING DWELLING UNITS AND SLEEPING UNITS FROM EACH OTHER OR FROM PUBLIC OR SERVICE AREAS SHALL HAVE A SOUND TRANSMISSION CLASS (STC) OF NOT LESS THAN 50 (45 IF FIELD TESTED) FOR AIR-BORNE NOISE WHEN TESTED IN ACCORDANCE WITH ASTM E90
- GRAB BARS, SHOWER SEATS AND DRESSING ROOM BENCH SEATS SHALL BE DESIGNED TO RESIST A SINGLE CONCENTRATED LOAD OF 250 POUNDS (1.11 KN) APPLIED IN ANY DIRECTION AT ANY POINT ON THE GRAB BAR OR SEAT SO AS TO PRODUCE THE MAXIMUM LOAD EFFECTS
- ACCESSORIES SUCH AS GRAB BARS, TOWEL BARS, PAPER DISPENSERS AND SOAP DISHES, PROVIDED ON OR WITHIN WALLS, SHALL BE INSTALLED AND SEALED TO PROTECT STRUCTURAL ELEMENTS FROM MOISTURE
- PROTECTION MUST BE PROVIDED FOR LOTS, AND FOR ALL ELEMENTS OF A BUILDING OR OTHER STRUCTURE, INCLUDING, BUT NOT LIMITED TO, FOOTINGS, FOUNDATIONS, PARTY WALLS, CHIMNEYS, VENTS, SKYLIGHTS, PORCHES, DECKS, ROOFS, ROOF OUTLETS, ROOF STRUCTURES AND FLASHING. PROVISIONS SHALL BE MADE TO CONTROL WATER RUNOFF AND EROSION DURING CONSTRUCTION OR DEMOLITION OR RAZE ACTIVITIES.

EXISTING TO REMAIN
NEW CONSTRUCTION
1 HR FIRE RATED WALL

INTERIOR FINISHES (PER DCBC TABLE 803.11)

Class A = Flame spread index 0-25; smoke-developed index 0-450
Class B = Flame spread index 26-75; smoke-developed index 0-450
Class C = Flame spread index 76-200; smoke-developed index 0-450
OCCUPANCY GROUP A-2, SPRINKLERED (MOST RESTRICTIVE)
Interior exit stairways, interior exit ramps and exit passageways: Class B
Corridors and enclosure for exit access stairways and exit access ramps: Class B
Rooms and enclosed spaces: Class C
a. Class C interior finish materials shall be permitted for wainscoting or paneling of not more than 1,000 square feet of applied surface area in the grade lobby where applied directly to a noncombustible base or over furring strips applied to a noncombustible base and fireblocked as required by Section 803.13.1.
b. In other than Group I-3 occupancies in buildings less than three stories above grade plane, Class B interior finish for nonsprinklered buildings and Class C interior finish for sprinklered buildings shall be permitted in interior exit stairways and ramps.
c. Requirements for rooms and enclosed spaces shall be based upon spaces enclosed by partitions. Where a fire-resistance rating is required for structural elements, the enclosing partitions shall extend from the floor to the ceiling. Partitions that do not comply with this shall be considered enclosing spaces and the rooms or spaces on both sides shall be considered one. In determining the applicable requirements for rooms and enclosed spaces, the specific occupancy thereof shall be the governing factor regardless of the group classification of the building or structure.
d. Lobby areas in Group A-1, A-2 and A-3 occupancies shall not be less than Class B materials.
e. Class C interior finish materials shall be permitted in places of assembly with an occupant load of 300 persons or less.

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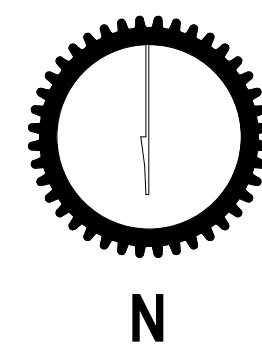
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A101



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FOR PERMIT

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PROJECT: 228RESIDENCES
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228 HAMILTON STREET NW
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SHEET SUBMISSION INDEX
ISSUE FOR PERMIT_04 APRIL 2022

| REV NO. | REVISION | DATE |
|---------|-----------------|------------|
| 1 | PERMIT RESPONSE | 2025.10.20 |

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SIGNATURE:


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SHEET TITLE: FLOOR PLANS

PROJECT NO: 2021.175

DATE ISSUED: 04/05/2022

SCALE: As indicated

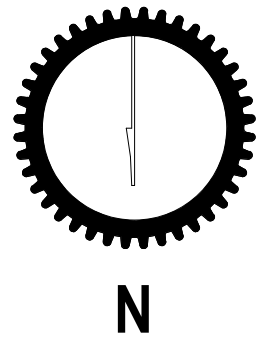

A102

CONSTRUCTION GENERAL NOTES

- ALL DIMENSIONS TO FINISH FACE, U.N.O.
- ALL INTERIOR PARTITIONS TO BE TYPE A, U.N.O. SEE GL01 FOR PARTITION SCHEDULE
- ALL INTERIOR WALLS TO BE PAINTED, U.N.O.
- ALL CEILINGS TO BE 5/8" GWB - PAINTED - FLAT FINISH
- ALL WALLS TO BE PAINTED - EGGSHELL FINISH
- REPAIR ALL WALLS EXISTING TO REMAIN AS REQUIRED
- SEE ELEVATIONS FOR WINDOW TAGS
- PROVIDE ARC-FAULT PROTECTION FOR ALL LIVING SPACE OUTLETS TO COMPLY
- ALL FLOORING TO BE CONTINUOUS HARDWOOD SPECIFIED BY OWNER, U.N.O.
- REPLACE ALL EXISTING WINDOWS W LOW-E GLASS WINDOWS
- GC TO VERIFY INSULATION OF EXISTING EXTERIOR WALLS TO REMAIN MEETS R8/13 ACCORDING TO 2017 IECC 402.1.1
- AIR LEAKAGE RATE NOT TO EXCEED 3 AIR CHANGES PER HOUR. GC TO TEST BUILDING THERMAL ENVELOP IN ACCORDANCE WITH 2017 IECC 402.4.1.2
- GC TO PROVIDE NO FEWER THAN ONE APPROVE PORTABLE FIRE EXTINGUISHERS IN ACCORDANCE WITH SECTION 906. AREAS TO HAVE FIRE EXTINGUISHERS AS FOLLOWS: EA. STAIRWAY FLOOR LEVEL, STORAGE AND CONSTRUCTION SHED, WHERE SPECIAL HAZARDS EXIST. SEE PLAN FOR FIRE EXTINGUISHER (F.E.) LOCATIONS.
- GC TO PROVIDE PORTABLE FIRE EXTINGUISHERS IN ALL KITCHEN AREAS IN RECESSED JL ORBIT LOW PROFILE CABINET @ 48" AFF
- HANDRAILS AND GUARDS SHALL BE DESIGNED TO RESIST A LINEAR LOAD OF 50 POUNDS PER LINEAR FOOT (PLF) (0.73 KN/M).
- HANDRAILS AND GUARDS SHALL BE DESIGNED TO RESIST A CONCENTRATED LOAD OF 200 POUNDS (0.89 KN)
- WALLS, PARTITIONS, AND FLOOR/CEILING ASSEMBLIES SEPARATING DWELLING UNITS AND SLEEPING UNITS FROM EACH OTHER OR FROM PUBLIC OR SERVICE AREAS SHALL HAVE A SOUND TRANSMISSION CLASS (STC) OF NOT LESS THAN 50 (45 IF FIELD TESTED) FOR AIR-BORNE NOISE WHEN TESTED IN ACCORDANCE WITH ASTM E90
- GRAB BARS, SHOWER SEATS AND DRESSING ROOM BENCH SEATS SHALL BE DESIGNED TO RESIST A SINGLE CONCENTRATED LOAD OF 250 POUNDS (1.11 KN) APPLIED IN ANY DIRECTION AT ANY POINT ON THE GRAB BAR OR SEAT SO AS TO PRODUCE THE MAXIMUM LOAD EFFECTS
- ACCESSORIES SUCH AS GRAB BARS, TOWEL BARS, PAPER DISPENSERS AND SOAP DISHES, PROVIDED ON OR WITHIN WALLS, SHALL BE INSTALLED AND SEALED TO PROTECT STRUCTURAL ELEMENTS FROM MOISTURE
- PROTECTION MUST BE PROVIDED FOR LOTS, AND FOR ALL ELEMENTS OF A BUILDING OR OTHER STRUCTURE, INCLUDING, BUT NOT LIMITED TO, FOOTINGS, FOUNDATIONS, PARTY WALLS, CHIMNEYS, VENTS, SKYLIGHTS, PORCHES, DECKS, ROOFS, ROOF OUTLETS, ROOF STRUCTURES AND FLASHING. PROVISIONS SHALL BE MADE TO CONTROL WATER RUNOFF AND EROSION DURING CONSTRUCTION OR DEMOLITION OR RAZE ACTIVITIES.

EXISTING TO REMAIN
NEW CONSTRUCTION
1 HR FIRE RATED WALL

INTERIOR FINISHES (PER DCBC TABLE 803.11)


Class A = Flame spread index 0-25; smoke-developed index 0-450
Class B = Flame spread index 26-75; smoke-developed index 0-450
Class C = Flame spread index 76-200; smoke-developed index 0-450
OCCUPANCY GROUP A-2, SPRINKLERED (MOST RESTRICTIVE)
Interior exit stairways, interior exit ramps and exit passageways: Class B
Corridors and enclosure for exit access stairways and exit access ramps: Class B
Rooms and enclosed spaces: Class C
a. Class C interior finish materials shall be permitted for wainscoting or paneling of not more than 1,000 square feet of applied surface area in the grade lobby where applied directly to a noncombustible base or over furring strips applied to a noncombustible base and fireblocked as required by Section 803.13.1.
b. In other than Group I-3 occupancies in buildings less than three stories above grade plane, Class B interior finish for nonsprinklered buildings and Class C interior finish for sprinklered buildings shall be permitted in interior exit stairways and ramps.
c. Requirements for rooms and enclosed spaces shall be based upon spaces enclosed by partitions. Where a fire-resistance rating is required for structural elements, the enclosing partitions shall extend from the floor to the ceiling. Partitions that do not comply with this shall be considered enclosing spaces and the rooms or spaces on both sides shall be considered one. In determining the applicable requirements for rooms and enclosed spaces, the specific occupancy thereof shall be the governing factor regardless of the group classification of the building or structure.
d. Lobby areas in Group A-1, A-2 and A-3 occupancies shall not be less than Class B materials.
e. Class C interior finish materials shall be permitted in places of assembly with an occupant load of 300 persons or less.

RAISED CHARACTER AND
BRAILLE EXIT SIGN. SEE
A001 FOR REQ'S

RAISED CHARACTER AND
BRAILLE EXIT
SIGN. SEE A001 FOR
REQ'S

4 LEVEL 03 - FLOOR PLAN
1/4" = 1'-0"

3 LEVEL 02 - FLOOR PLAN - PROPOSED Copy 1
1/4" = 1'-0"

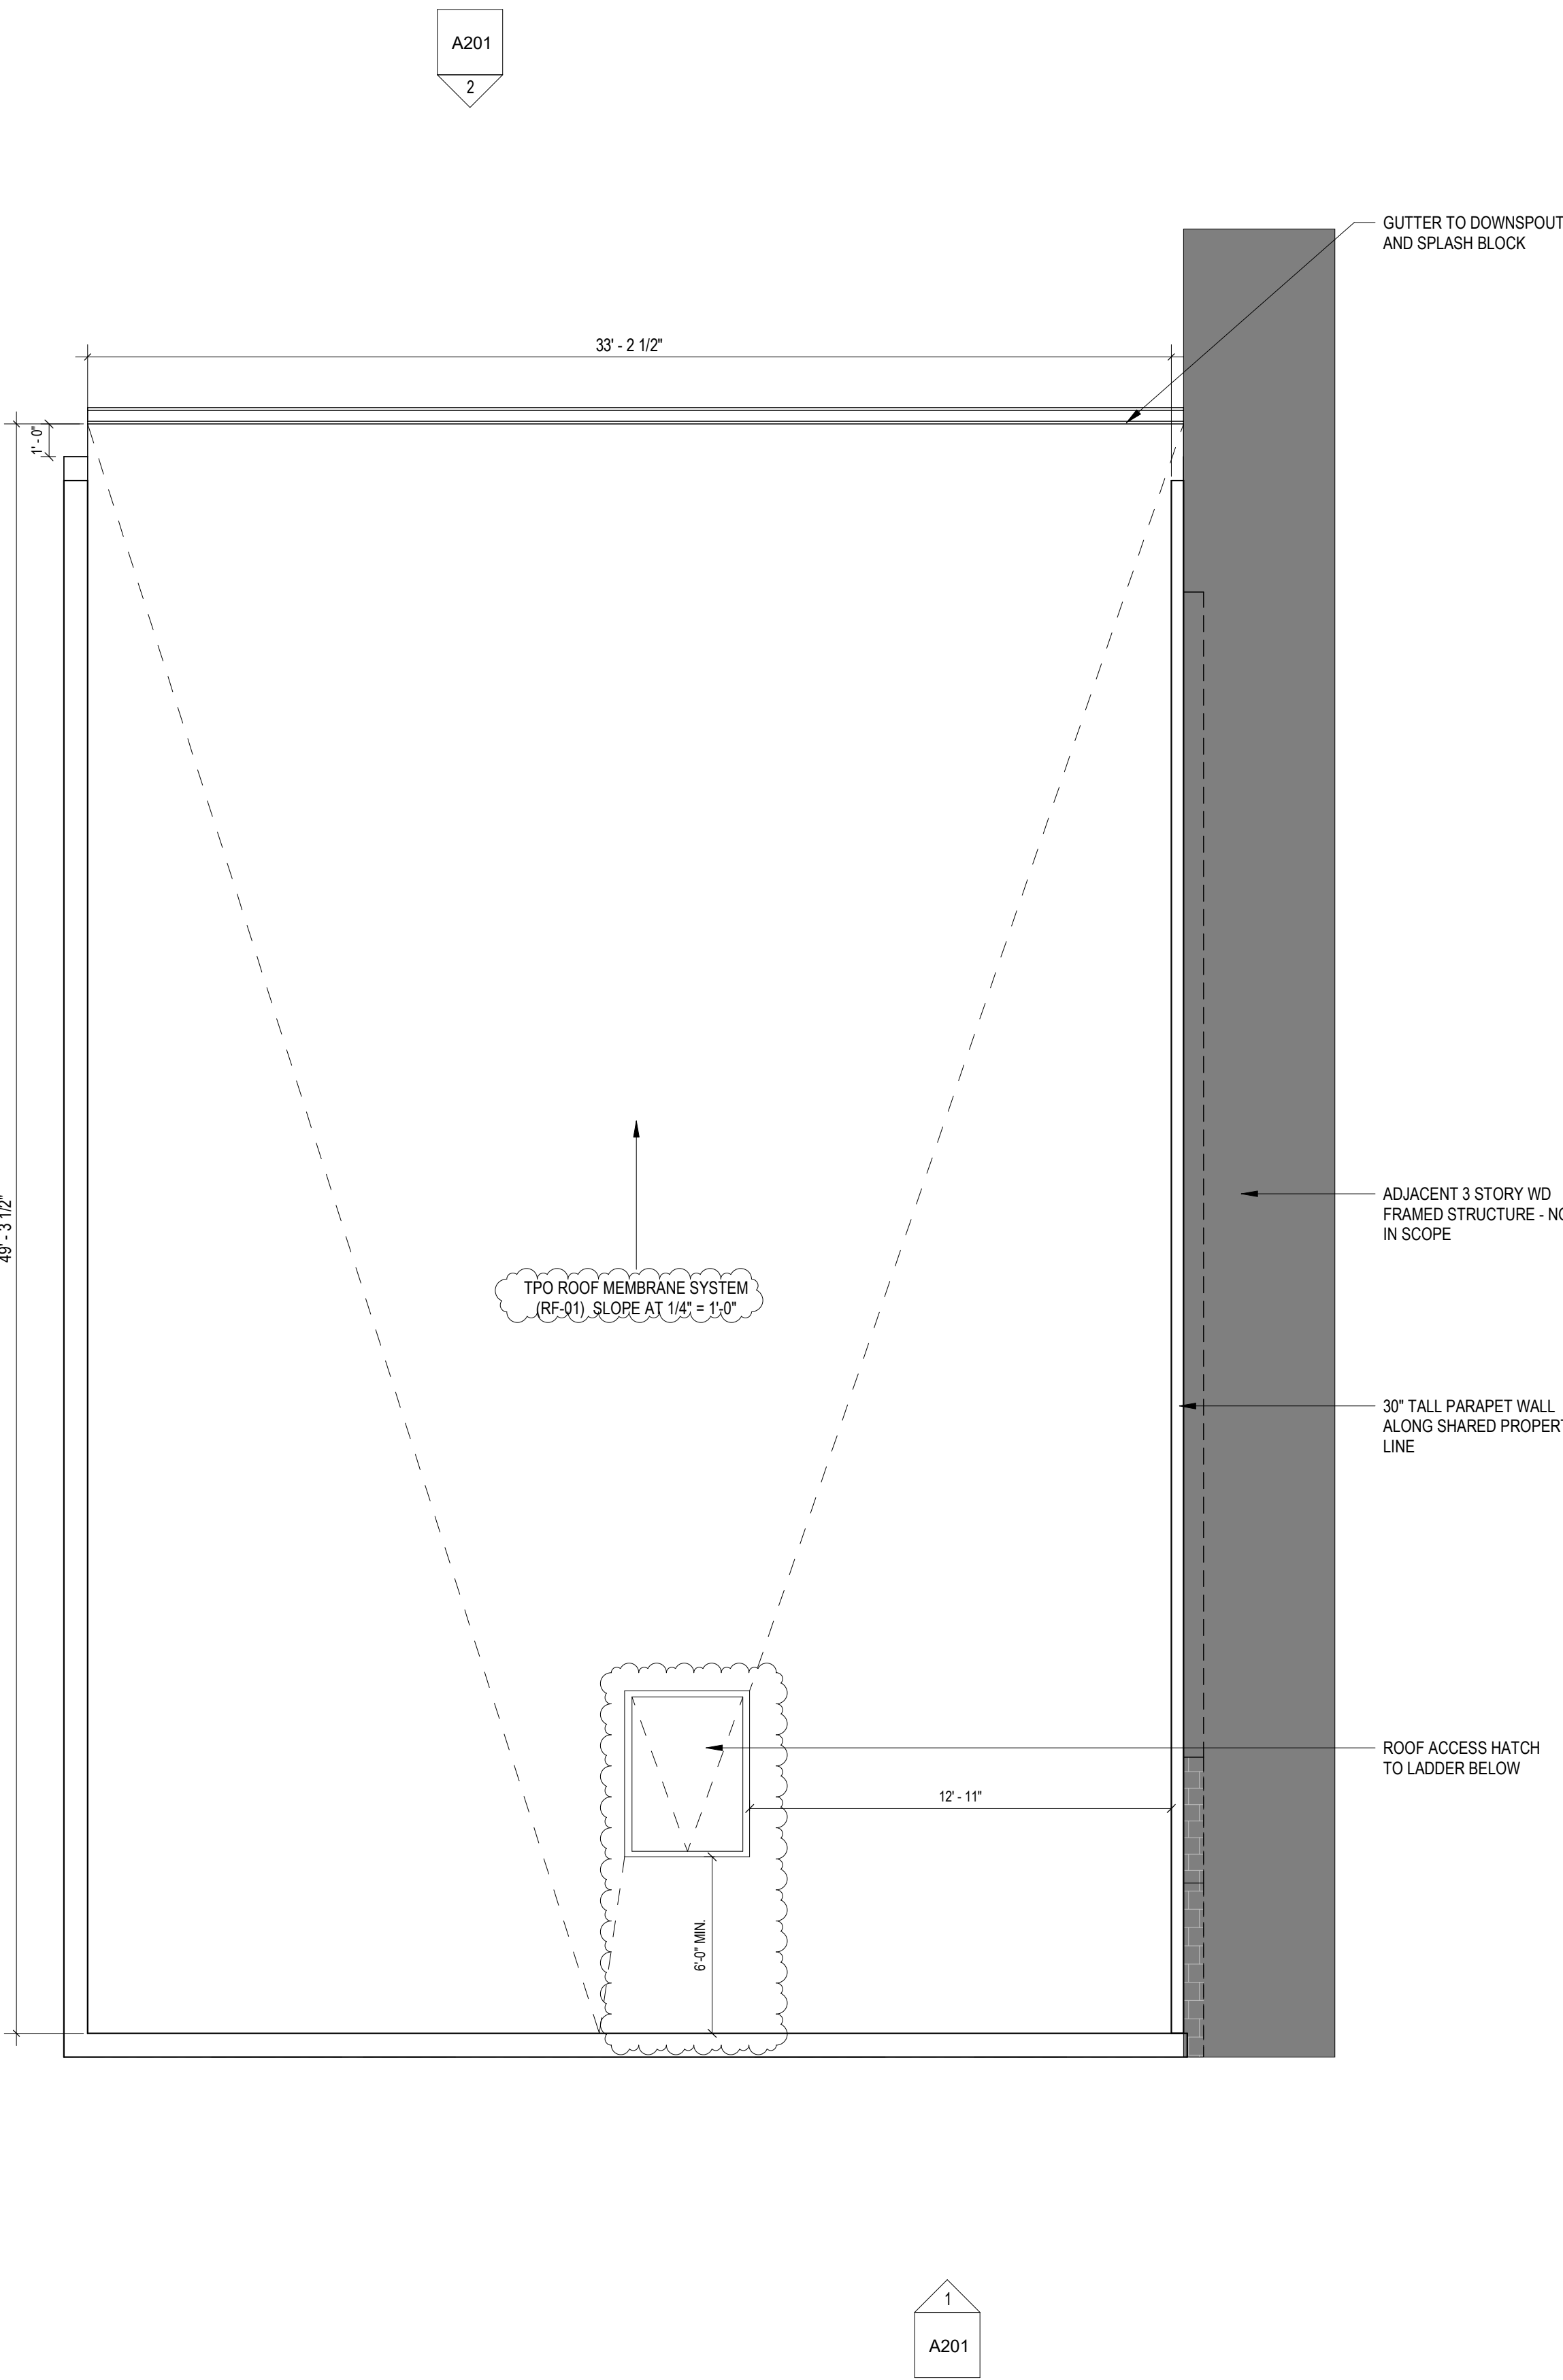

CONSTRUCTION GENERAL NOTES

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| 1 | PERMIT RESPONSE | 2025.10. 20 |

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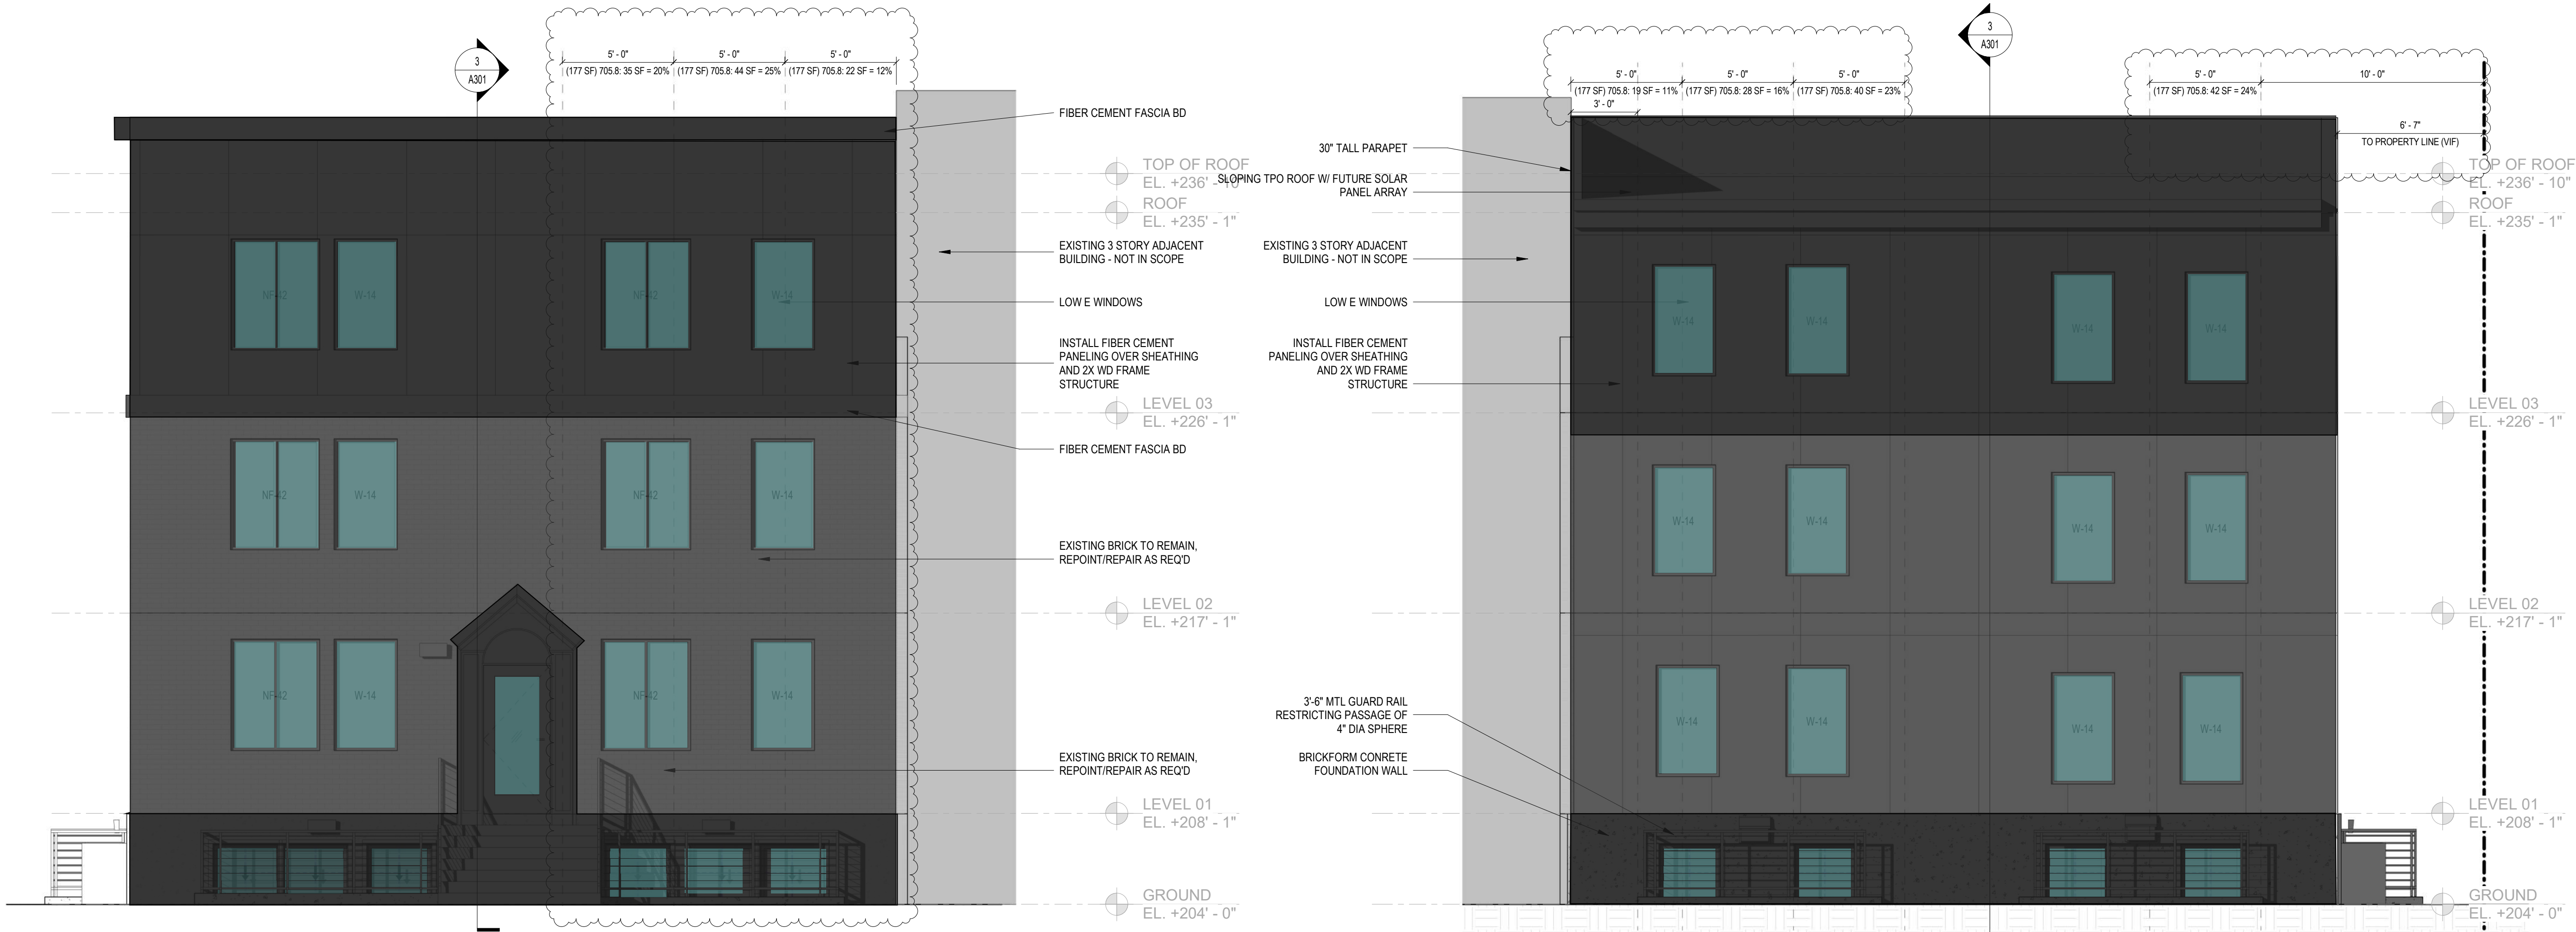
SHEET TITLE: ROOF PLAN

PROJECT NO: 2021.175

DATE ISSUED: 03/12/25

SCALE: As indicated

A103



1 FRONT ELEVATION - NEW CONSTRUCTION
1/4" = 1'-0"

2 REAR ELEVATION - NEW CONSTRUCTION
1/4" = 1'-0"



3 SIDE ELEVATION 1 - NEW CONSTRUCTION
1/4" = 1'-0"



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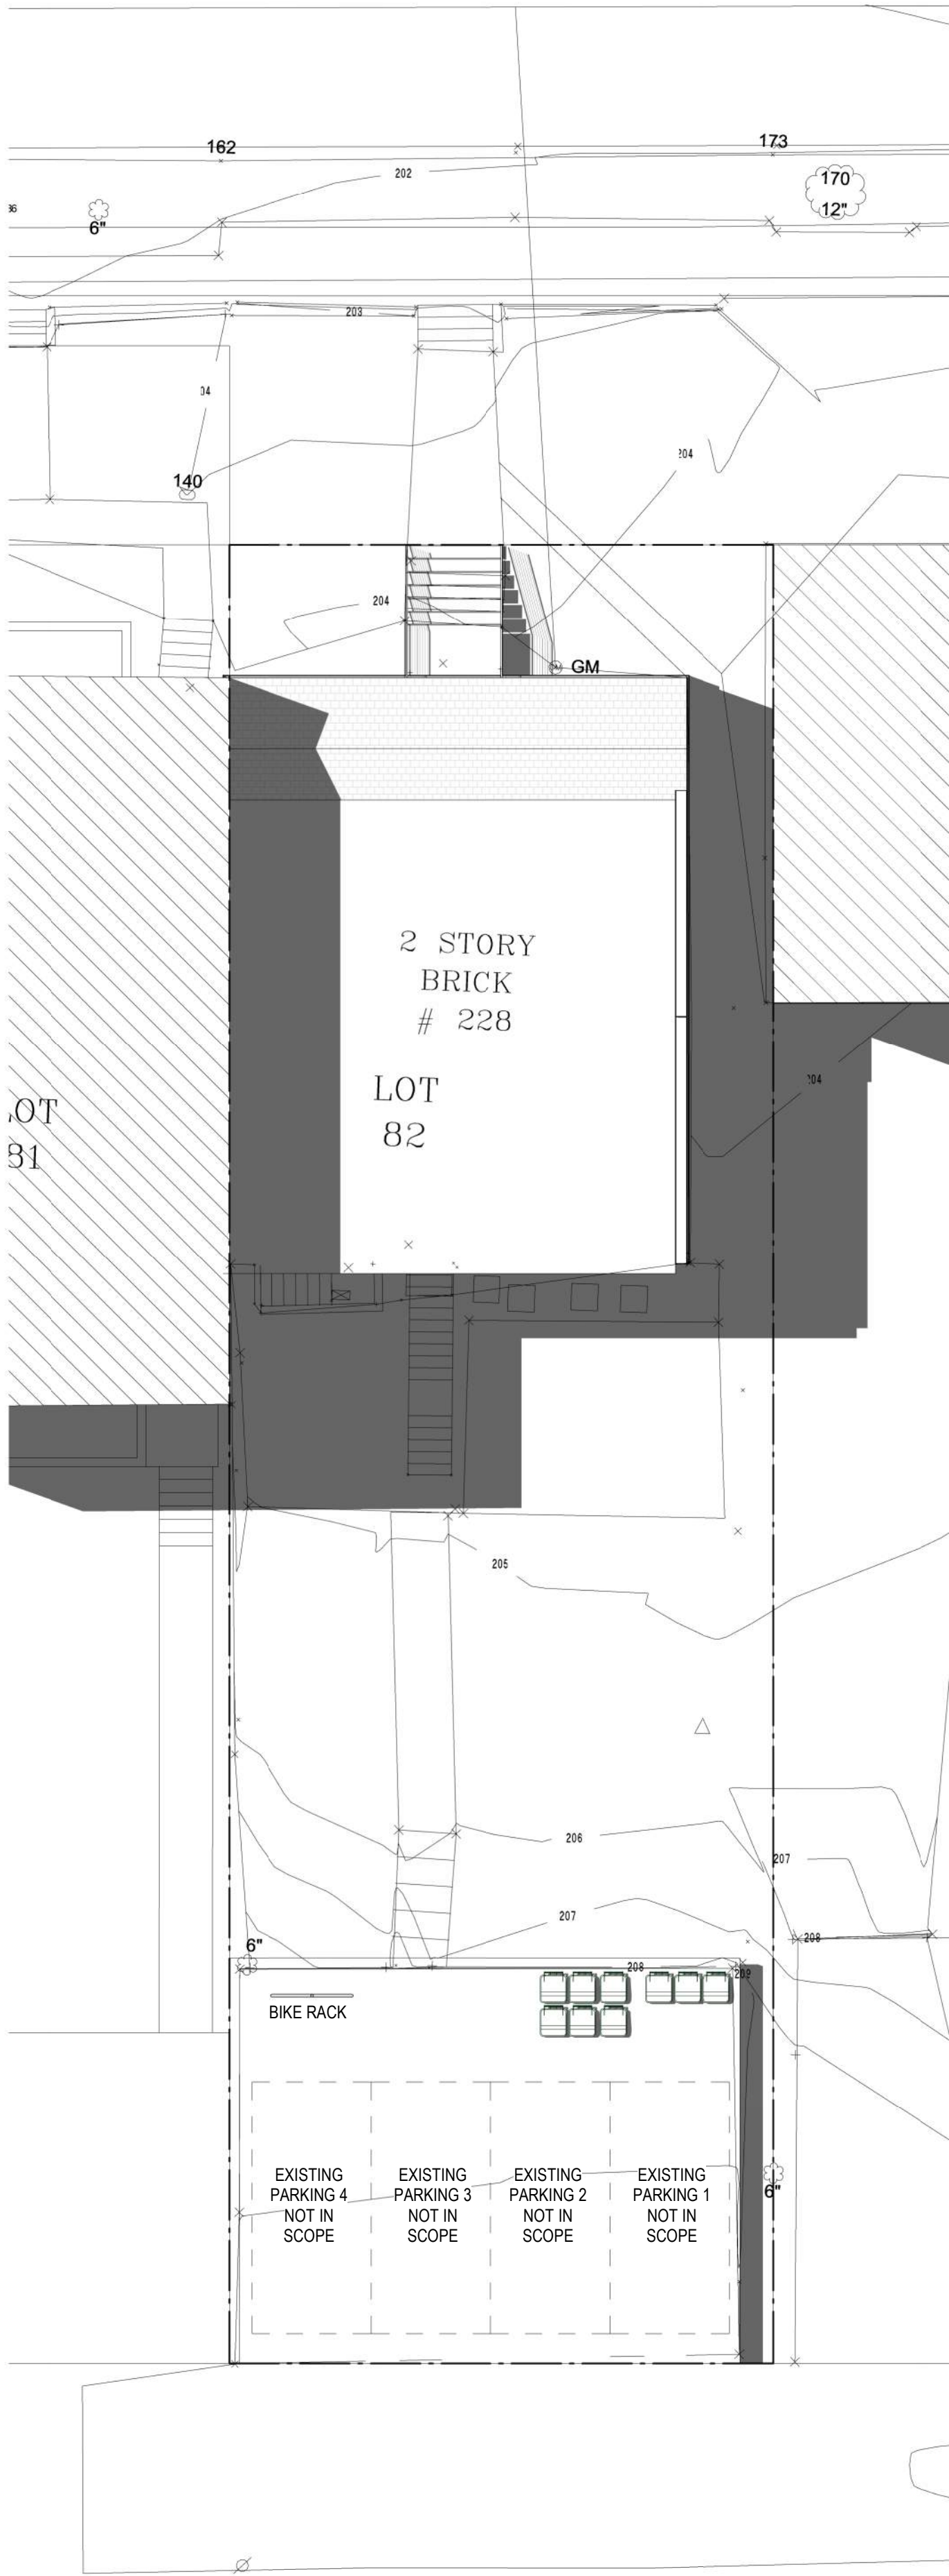
SHEET TITLE: EXTERIOR ELEVATIONS

PROJECT NO: 2021.175


DATE ISSUED: 04/05/2022

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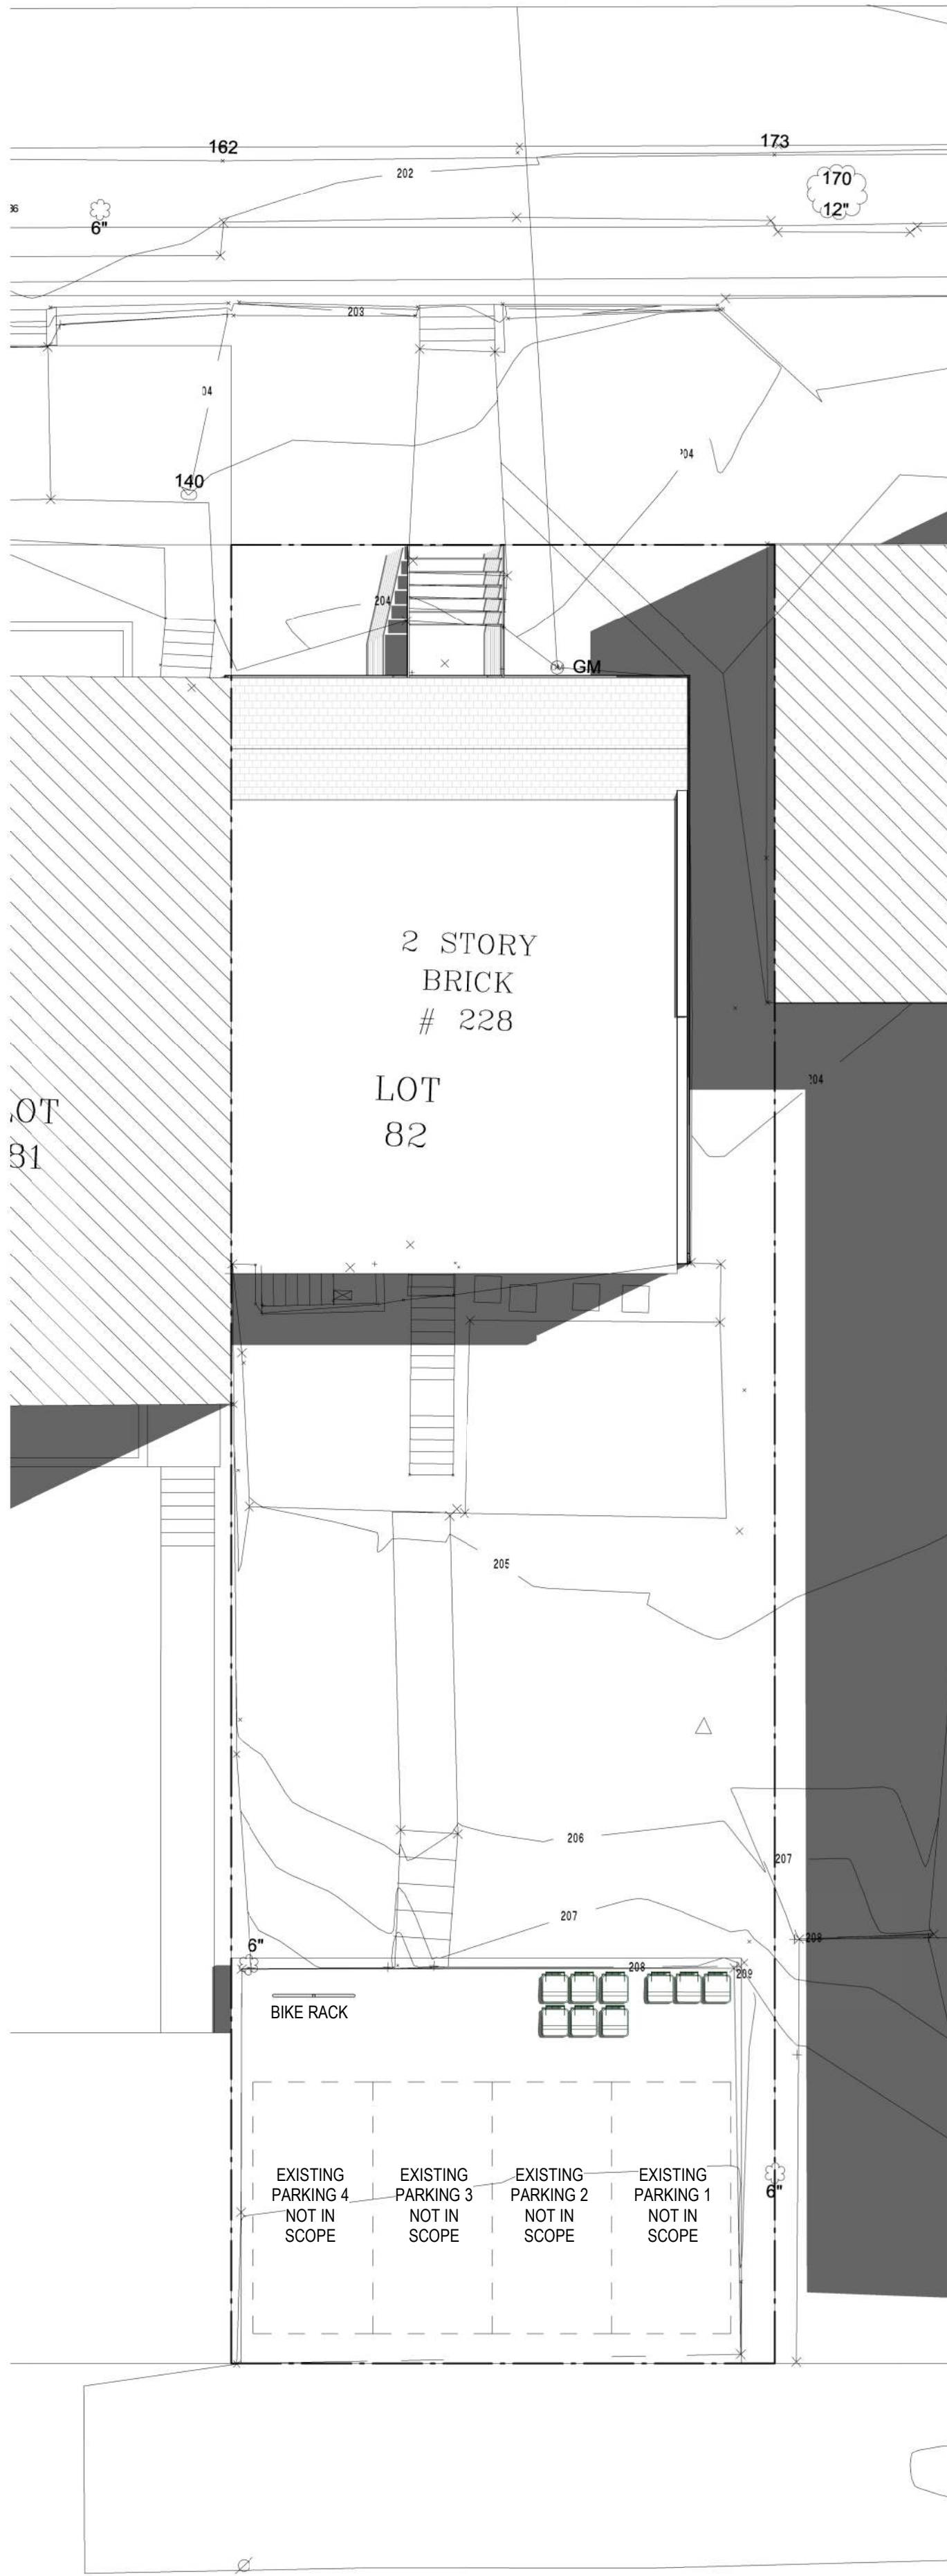
A201




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1" = 10'-0"

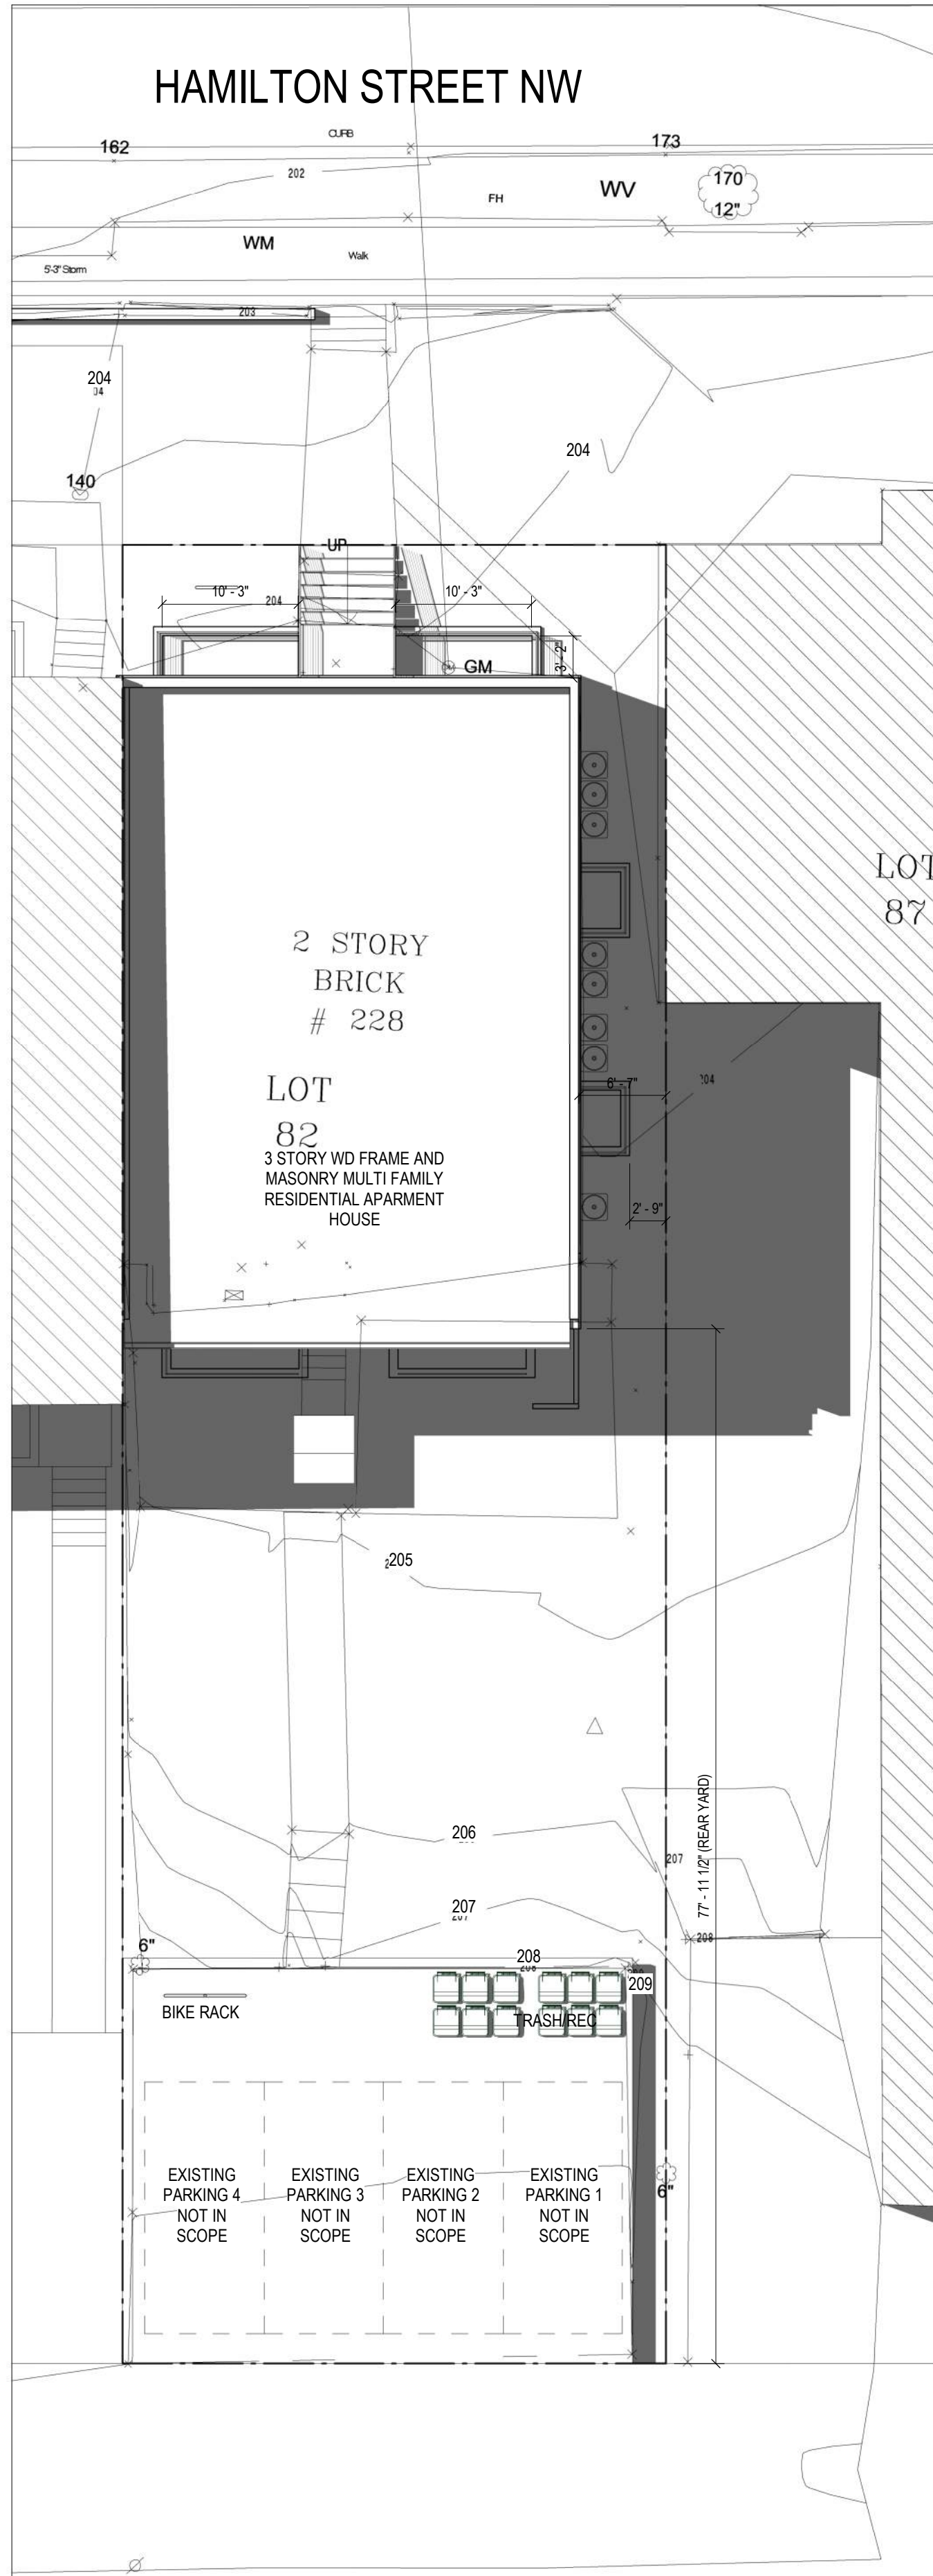

1 PROP - SUM SOL - 10AM
1" = 10'-0"



3 EXIST - SUM SOL - 2PM
1" = 10'-0"

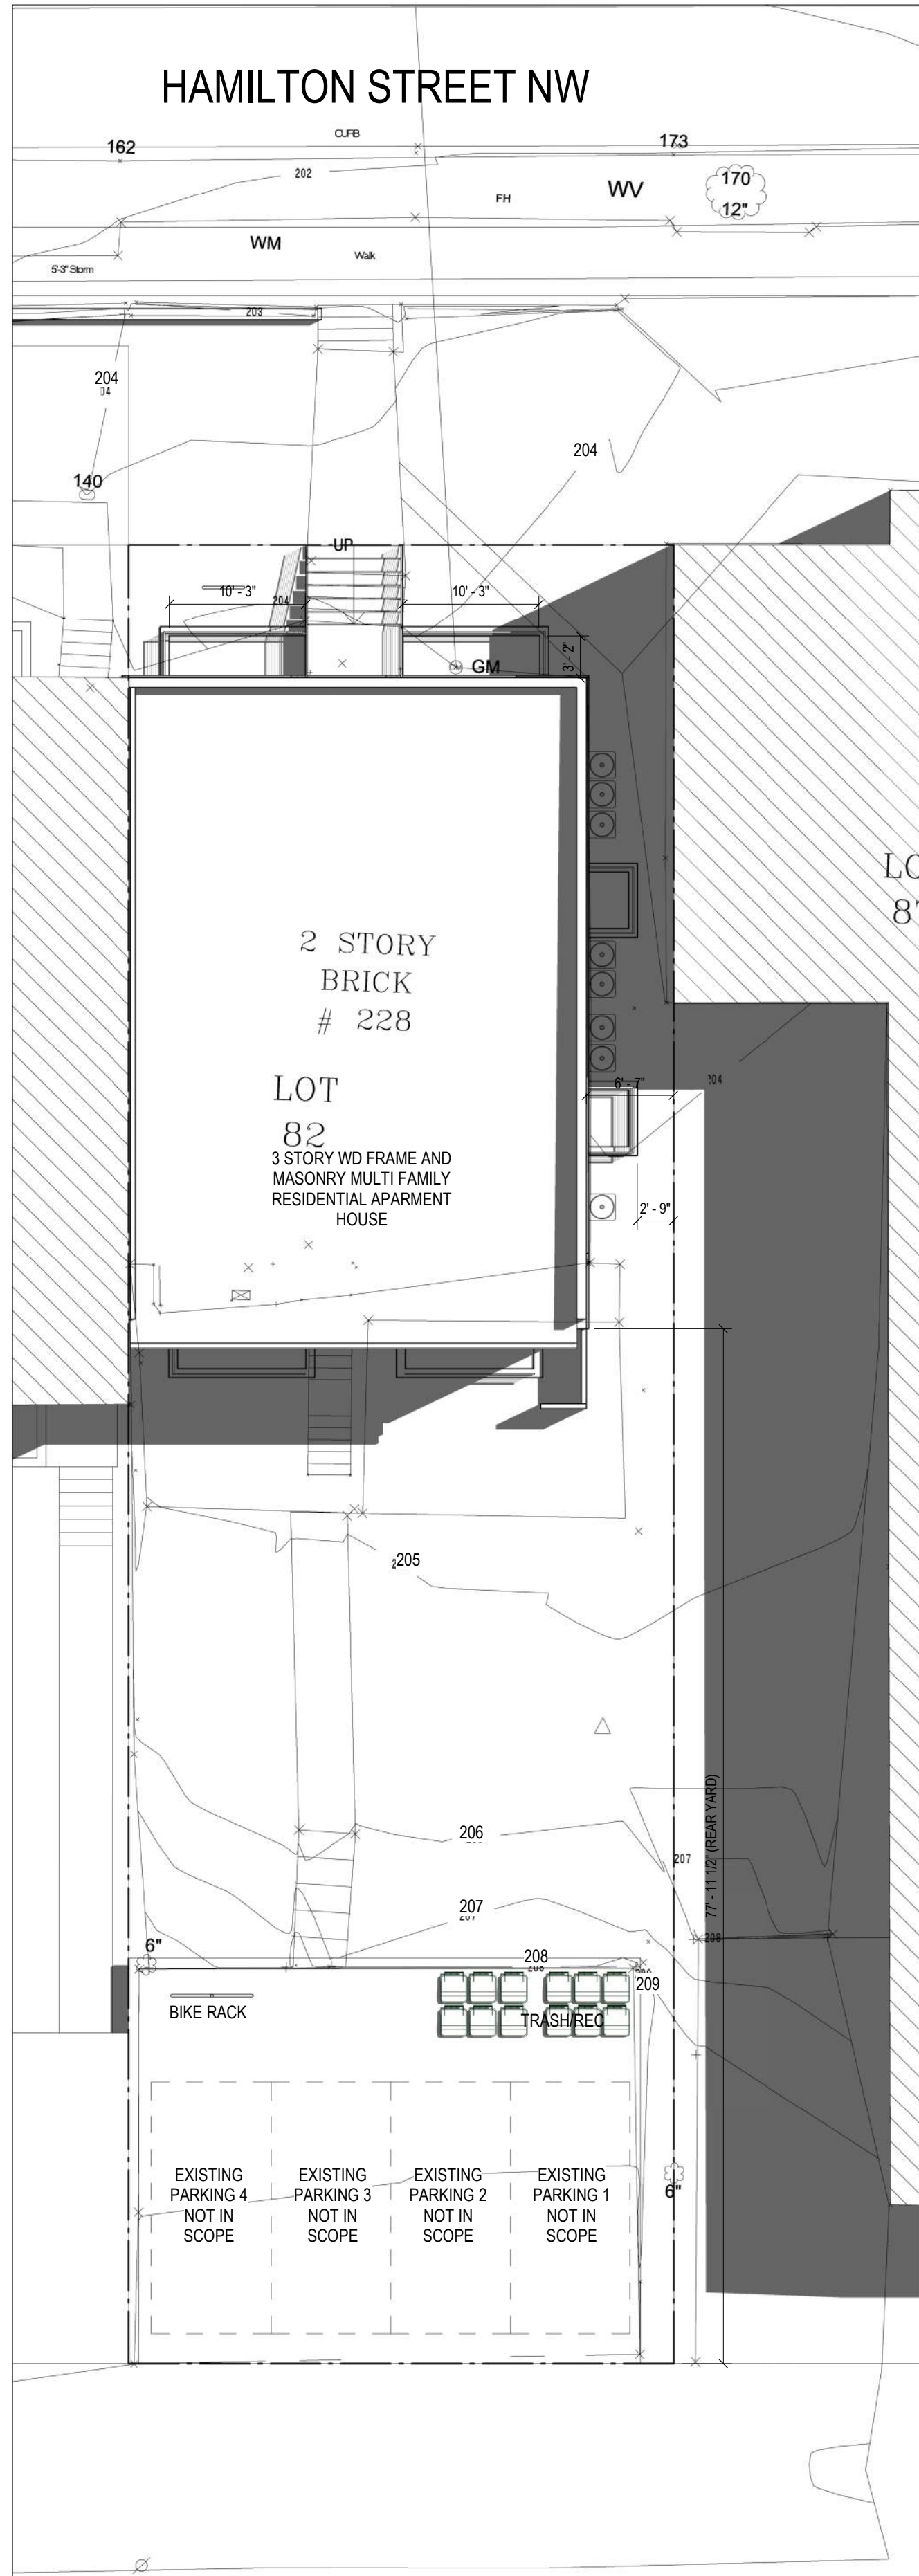

4 PROP - SUM SOL - 2PM
1" = 10'-0"



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SHEET TITLE: SUMMER SOLAR STUDIES

PROJECT NO: 2021.175


DATE ISSUED: 04/05/2022

SCALE: 1" = 10'-0"

A104




2 EXIST - WIN SOL - 10AM
1" = 10'-0"

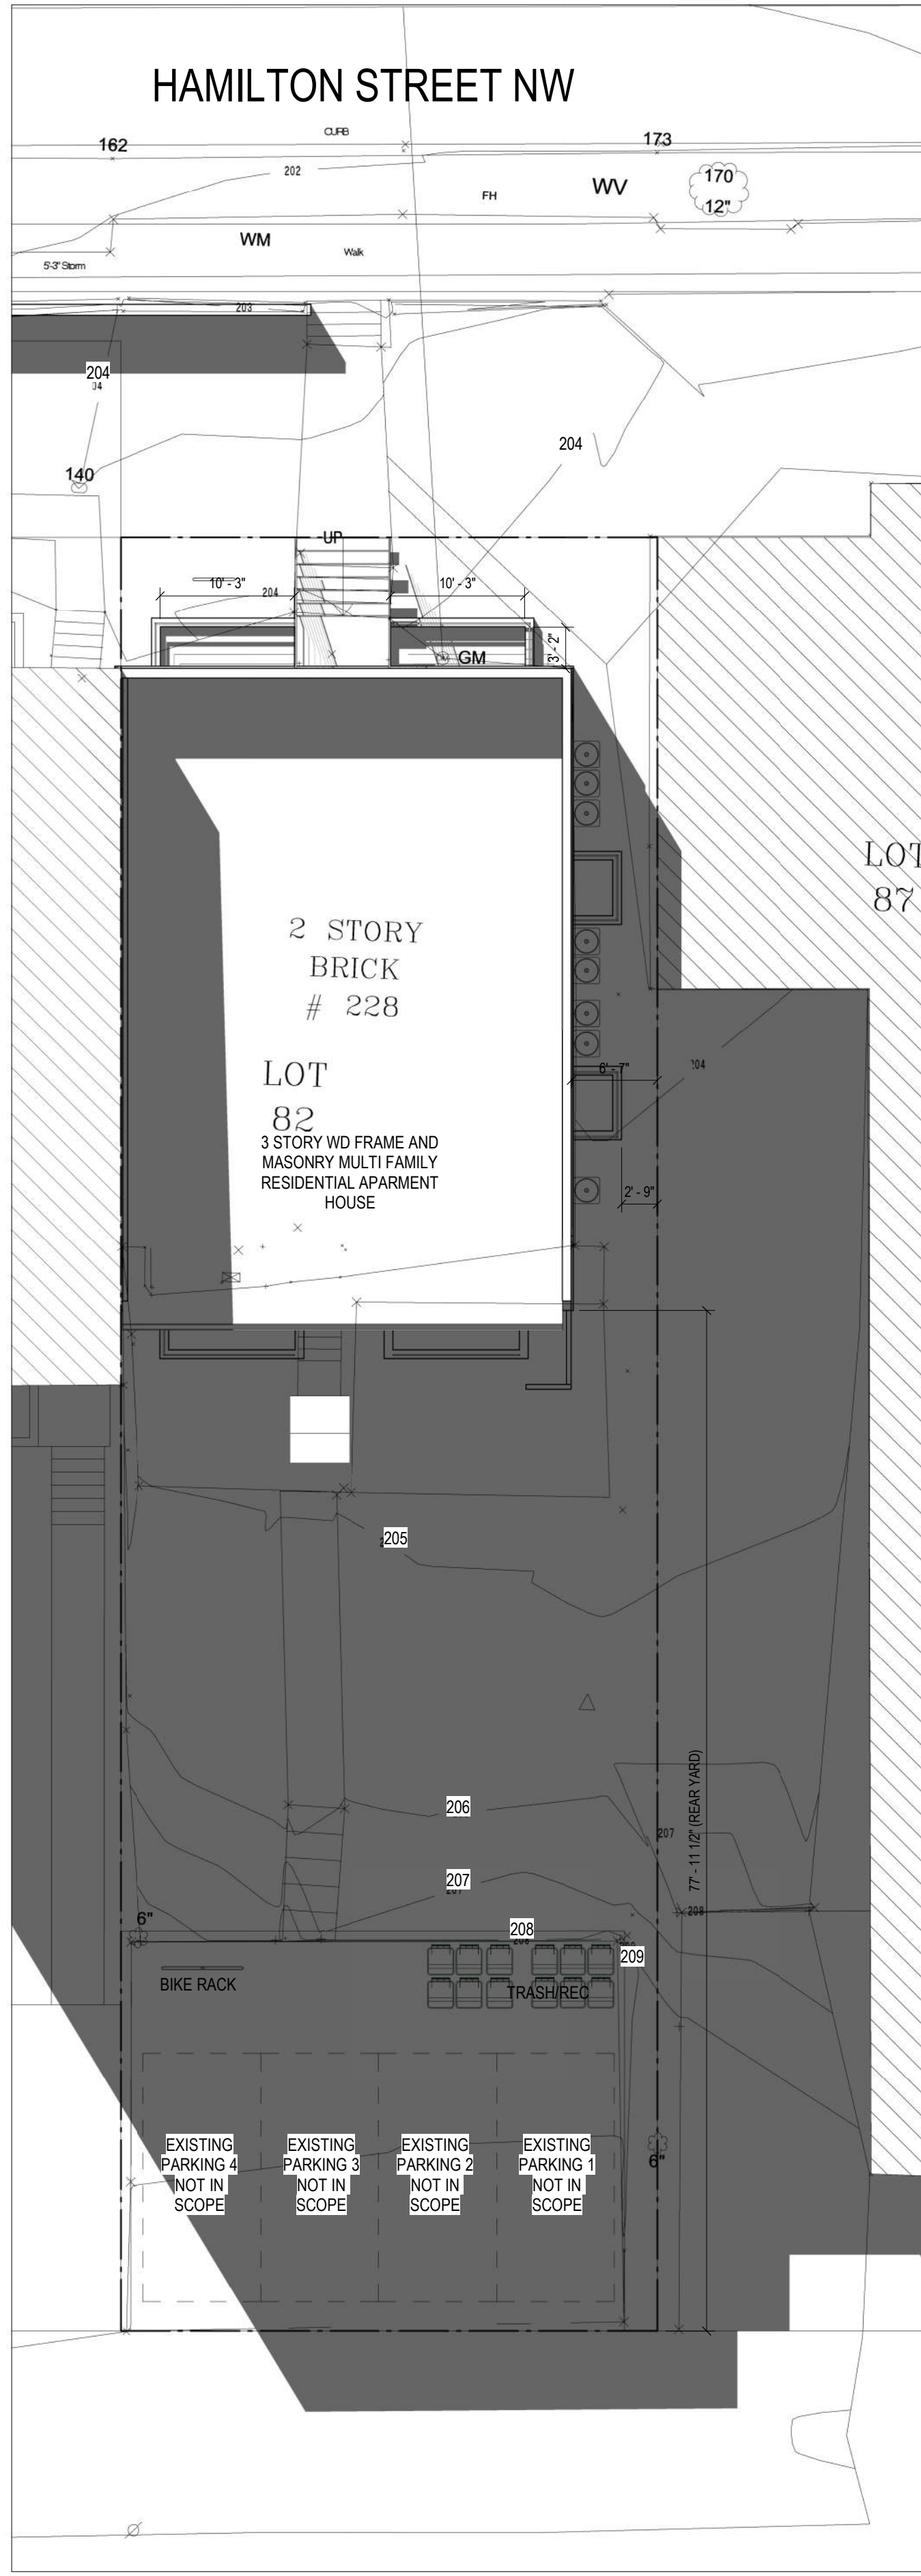

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3 EXIST - WIN SOL - 2PM
1" = 10'-0"



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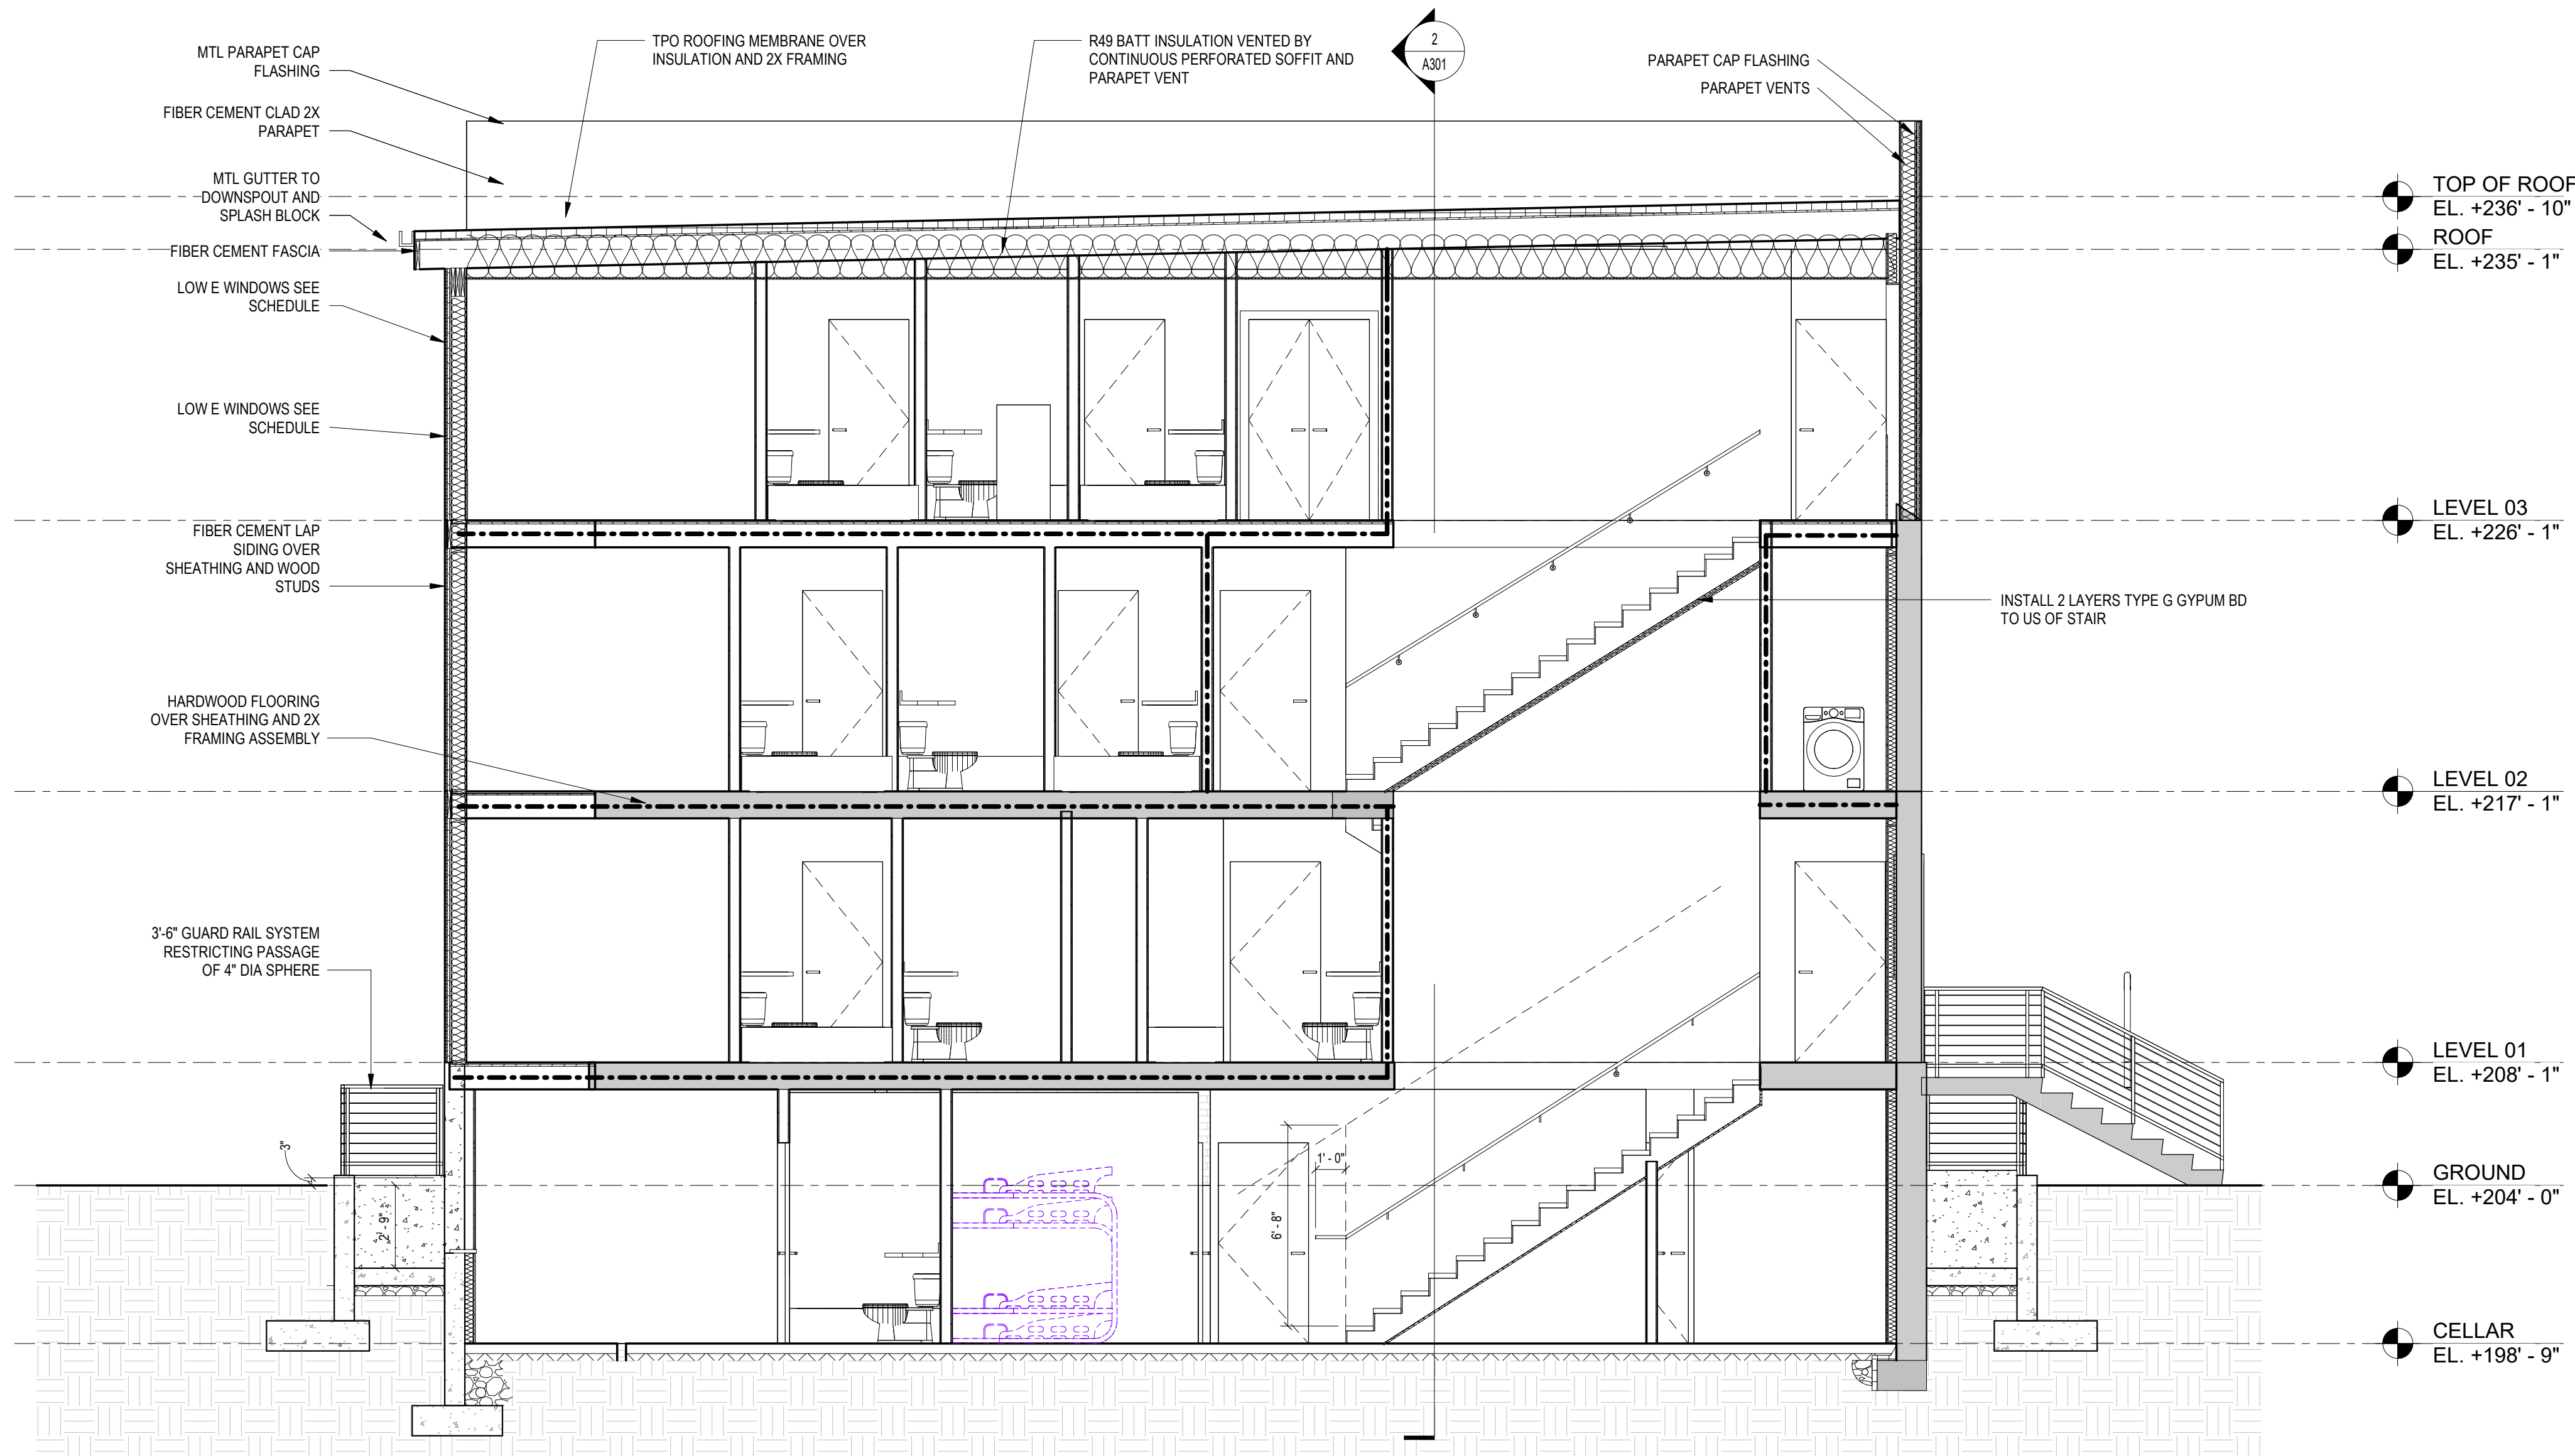
SHEET TITLE: WINTER SOLAR STUDIES

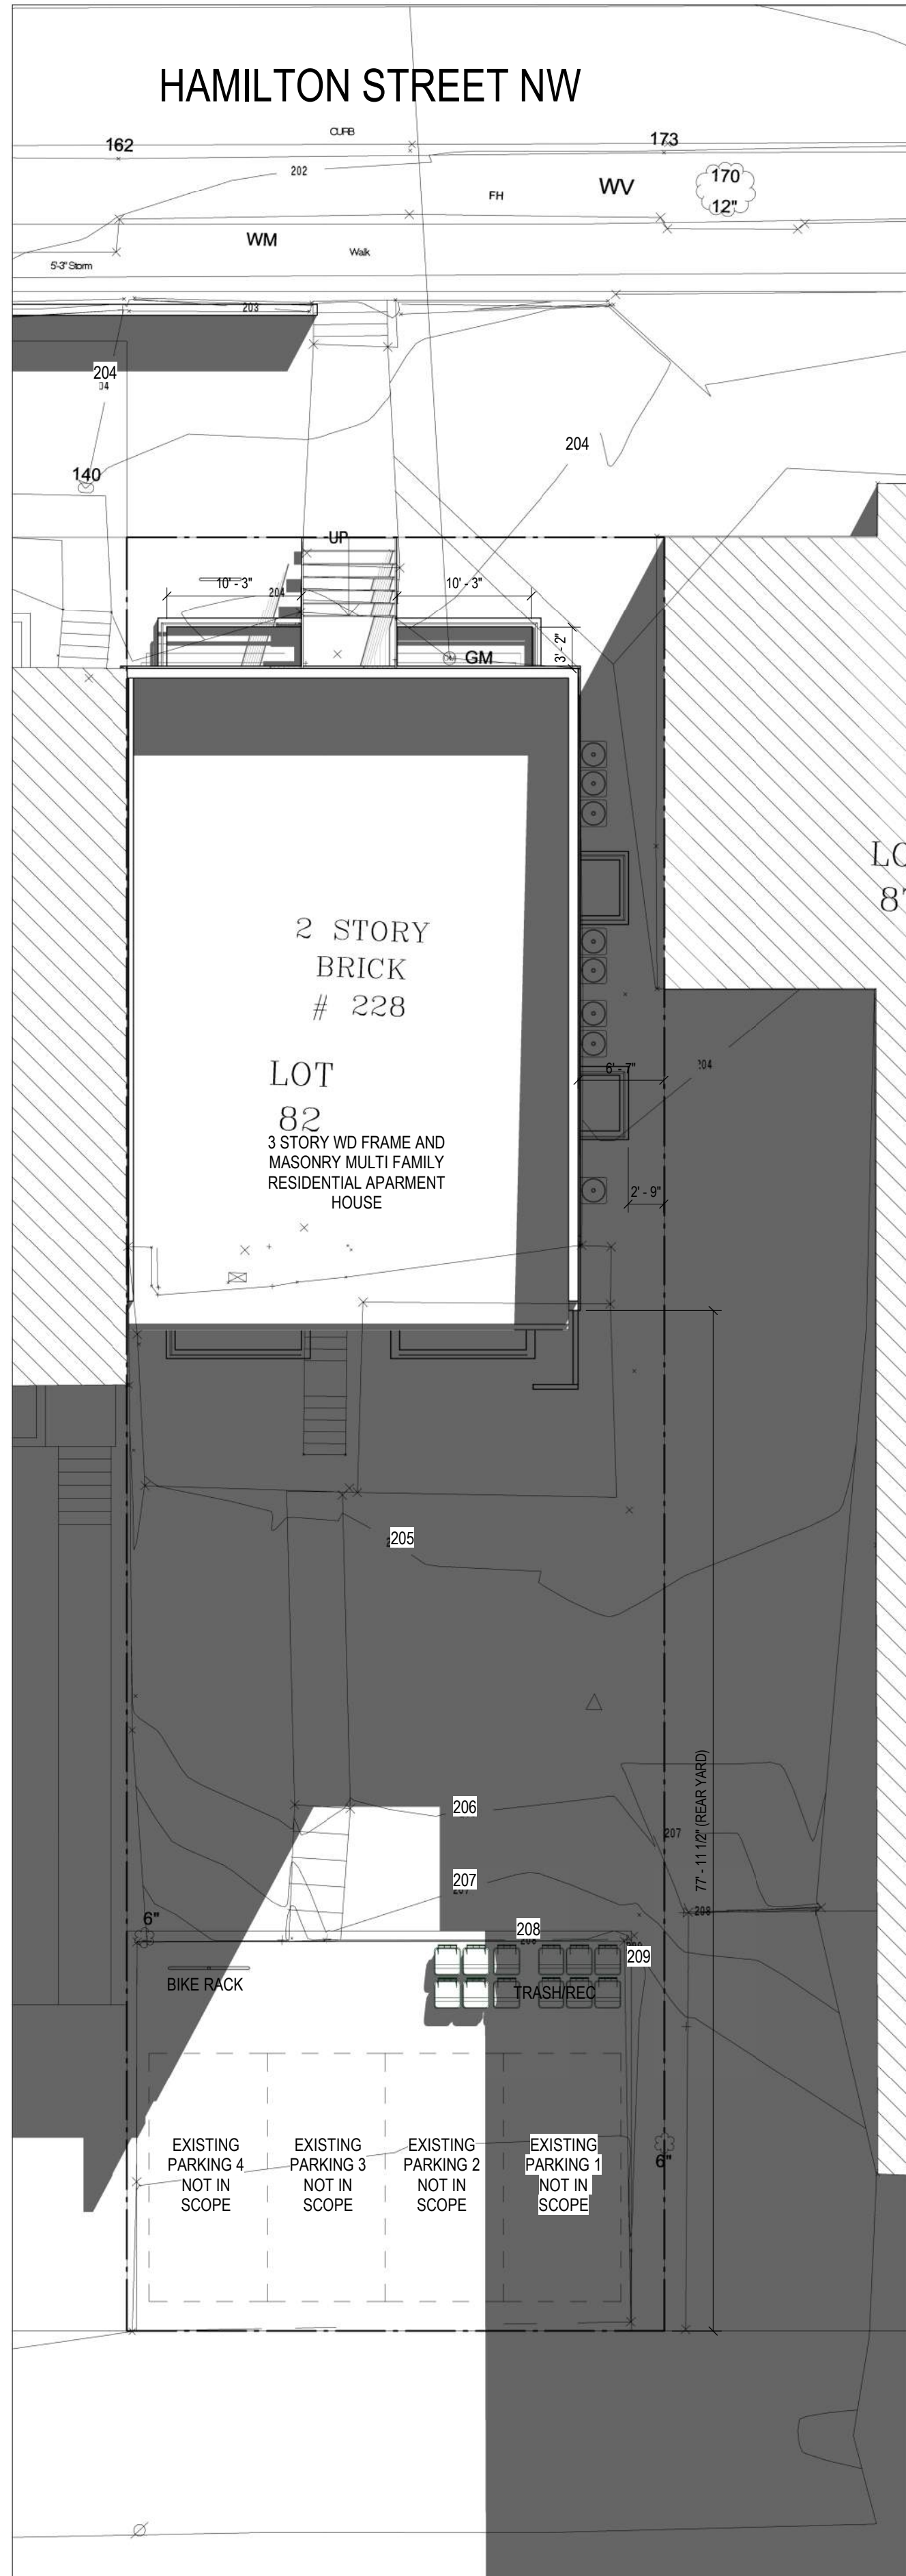PROJECT NO: 2021.175


DATE ISSUED: 04/05/2022

SCALE: 1" = 10'-0"


A105



3 Section 1
1/4" = 1'-0"

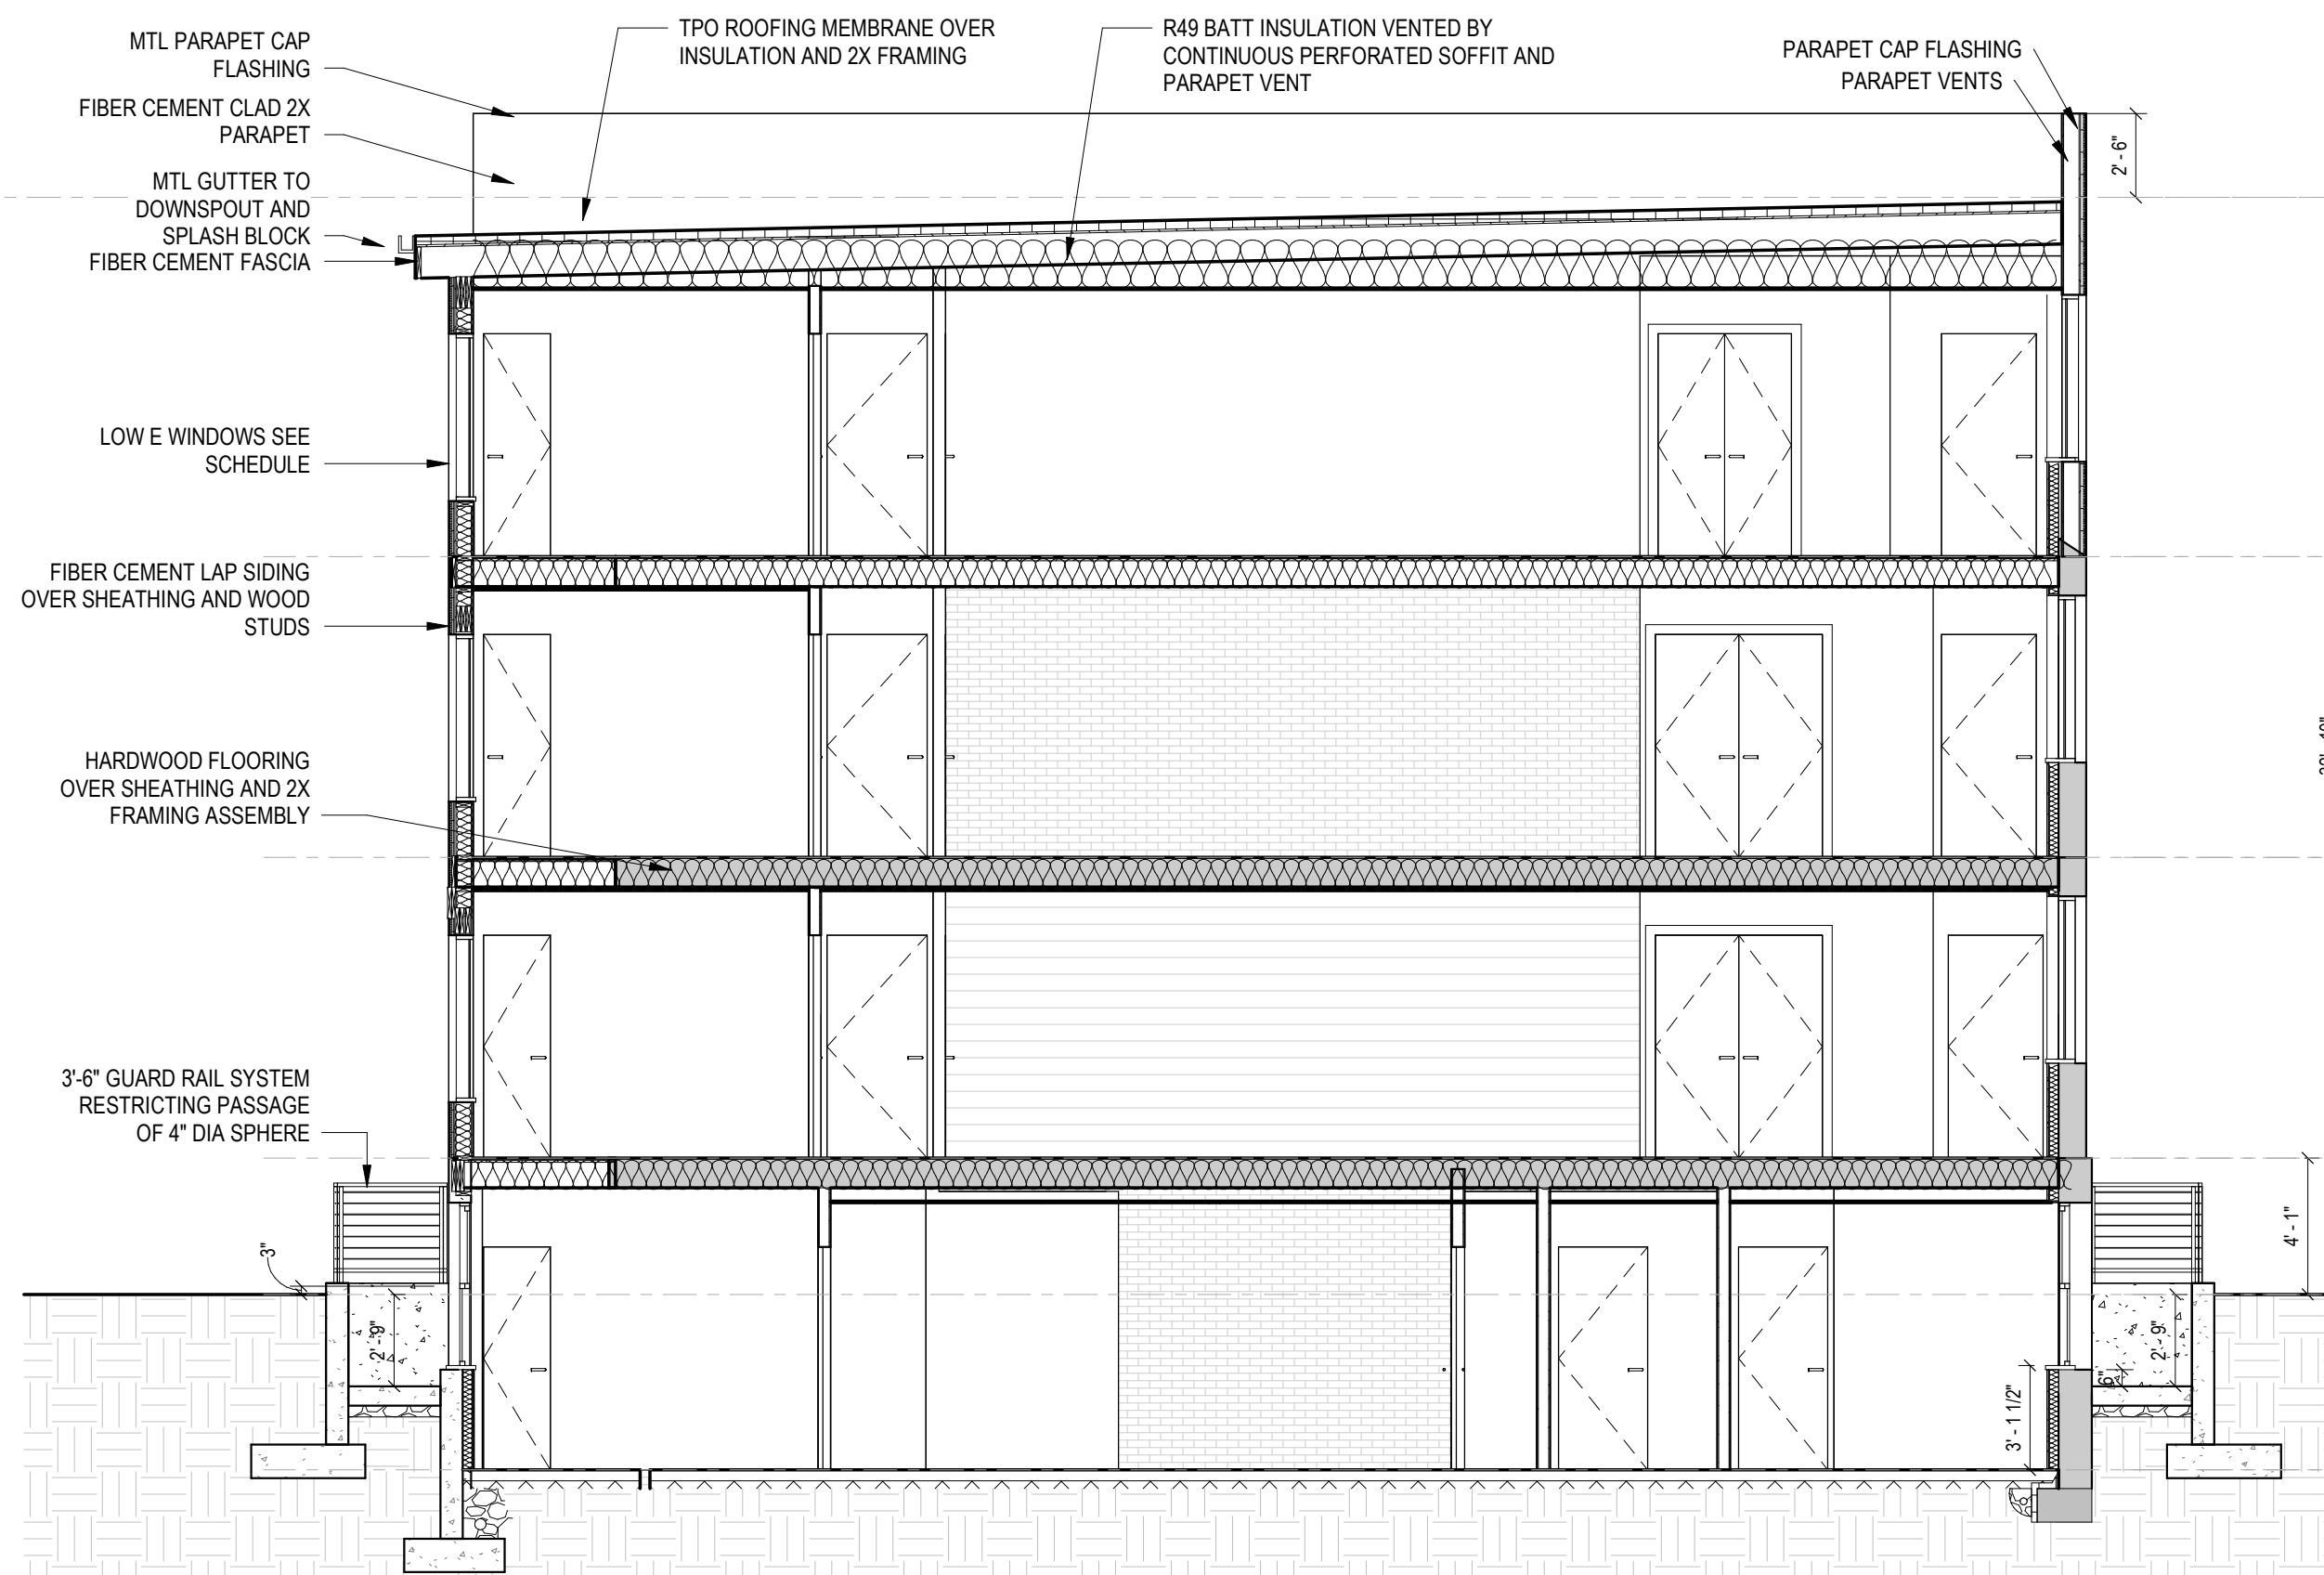

1 BUILDING SECTION 1
3/16" = 1'-0"

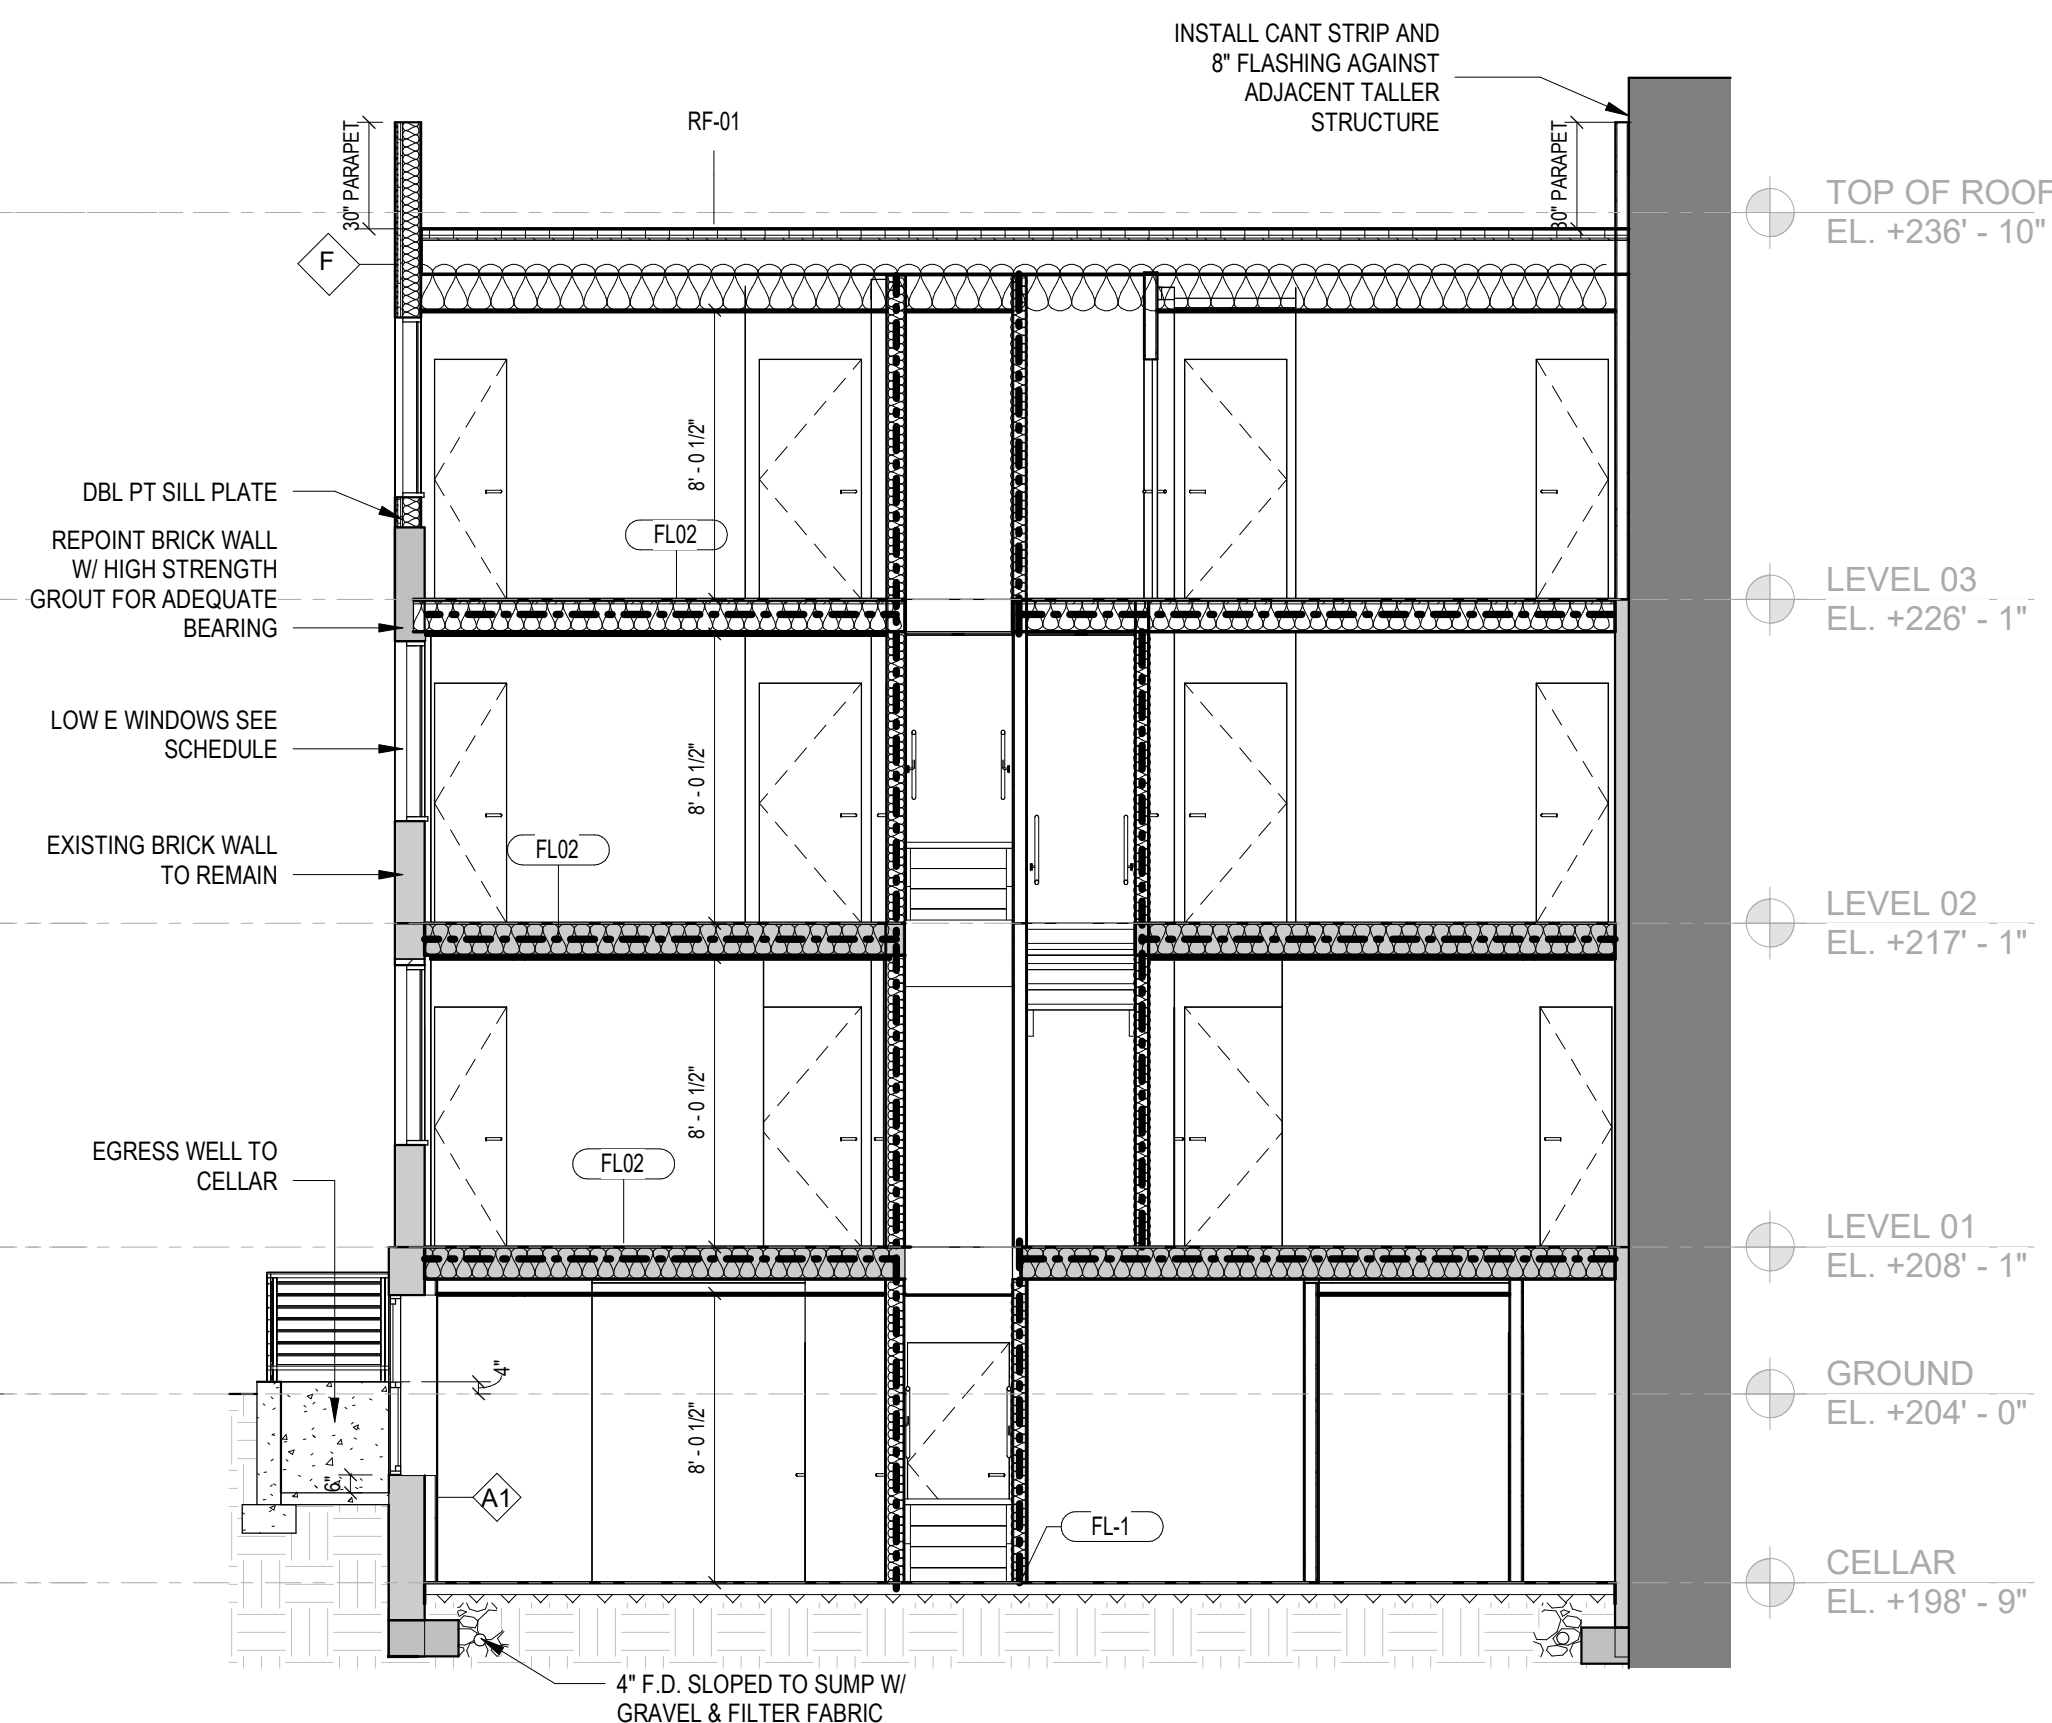

2 BUILDING SECTION 2
3/16" = 1'-0"



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SEAL & SIGNATURE:

I AM RESPONSIBLE FOR DETERMINING THAT THE ARCHITECTURAL DESIGNS INCLUDED IN THIS APPLICATION ARE IN COMPLIANCE WITH ALL LAWS AND REGULATIONS OF THE DISTRICT OF COLUMBIA. I HAVE PERSONALLY PREPARED, OR DIRECTLY SUPERVISED THE DEVELOPMENT OF, THE ARCHITECTURAL DESIGNS INCLUDED IN THIS APPLICATION.

SHEET TITLE: BUILDING SECTIONS
PROJECT NO: 2021.175
DATE ISSUED: 04/05/2022
SCALE: As indicated

A301