
# RESIDENTIAL ADDITION AND RENOVATION BANULESCU RESIDENCE BZA Application

MARCH 2025 100% SET

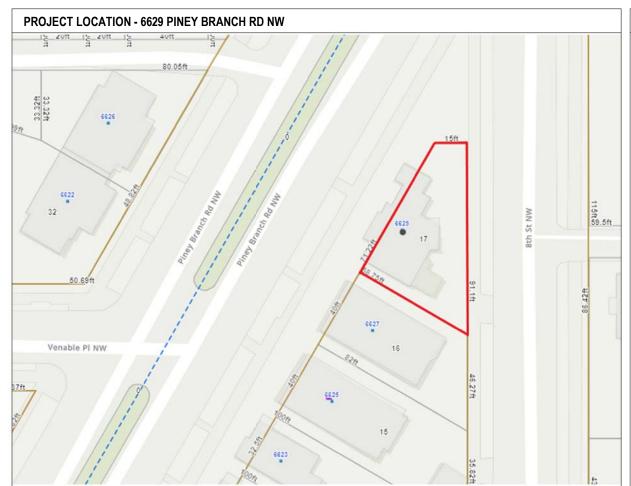

### **PROJECT DESCRIPTION**

The project at the Banulescu residence involves 2 story addition and interior alteration. Alterations include 1 new full bathroom, and renovations to existing laundry, kitchen, and main level bathroom.

The addition consists of a 200 Square foot addition facing 8th street. The addition requires code modification because it exceeds BRL Guidelines.

The existing driveway is to be removed along with the curb cut. No existing trees within the property and on the public way will be removed.

Parking zone is to remain undisturbed except for those areas detailed on the site plan related to the curb cut removal. No existing trees nor their tree boxes are to be altered under the scope of this project. If required by DDOT, an additional tree box can be added in the location of the removed curb cut.


Proposed fence on 8th Street NW to match existing, single concave with posts at 42" height maximum. This fence sits atop a retaining wall with a height variability to compensate for site slope. Total height of fence plus retaining wall does not exceed 42" at any point. Existing fence and proposed to maintain a 50% aperture. See plans and photos for details.

**Structure:** New 2-story, 198 sqft addition. Rearrangement of interior partition walls. **Plumbing:** 1 new full bath. Existing main floor kitchen and bath to have existing plumbing fixtures replaced with new.

**Mechanical:** Add existing ventilation to new addition. new exhaust fan at new bath. **Electrical:** rearrangement of plugs and switched to accommodate new layout. new plugs & switches at addition.

**Exterior Envelope:** 198 sqft addition, exterior doors and windows.

**Building Footprint:** 198 sqft addition. **Change of Use:** No Alteration.

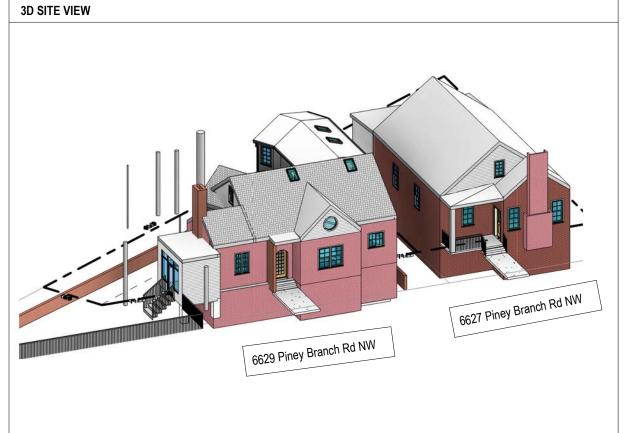

SHEET INDEX		
Sheet Number	Sheet Name	
A-0000	COVERSHEET	
A-0100	ZONING REPORT	
A-0101	ZONING SUMMARY	
A-0102	AERIAL VIEWS - FRONT	
A-0103	AERIAL VIEWS - REAR	
A-0200	PROPOSED FLOOR PLANS	
A-0201	PROPOSED FLOOR PLANS	
A-0203	PROPOSED ELEVATIONS	
A-0204	PROPOSED ELEVATIONS	
A-0205	EXISTING FLOOR PLANS	
A-0206	EXISTING FLOOR PLANS	
A-0300	SUMMER SUN SHADE STUDY - ELEVATION	
A-0301	WINTER SUN SHADE STUDY - ELEVATION	
A-0302	SUMMER SUN SHADE STUDY - PERSPECTIVE	
A-0303	WINTER SUN SHADE STUDY - PERSPECTIVE	



BANULESCU 6629 PINEY BRANCH RD NW WASHINGTON, DC 20012

**RESIDENTIAL RENOVATION & ADDITION** 

Scale

Project number


Date

COVERSHEET

Board of Zoning Adjustment
District of Columbia

CASE 10.2000

EXHIBIT NO.38

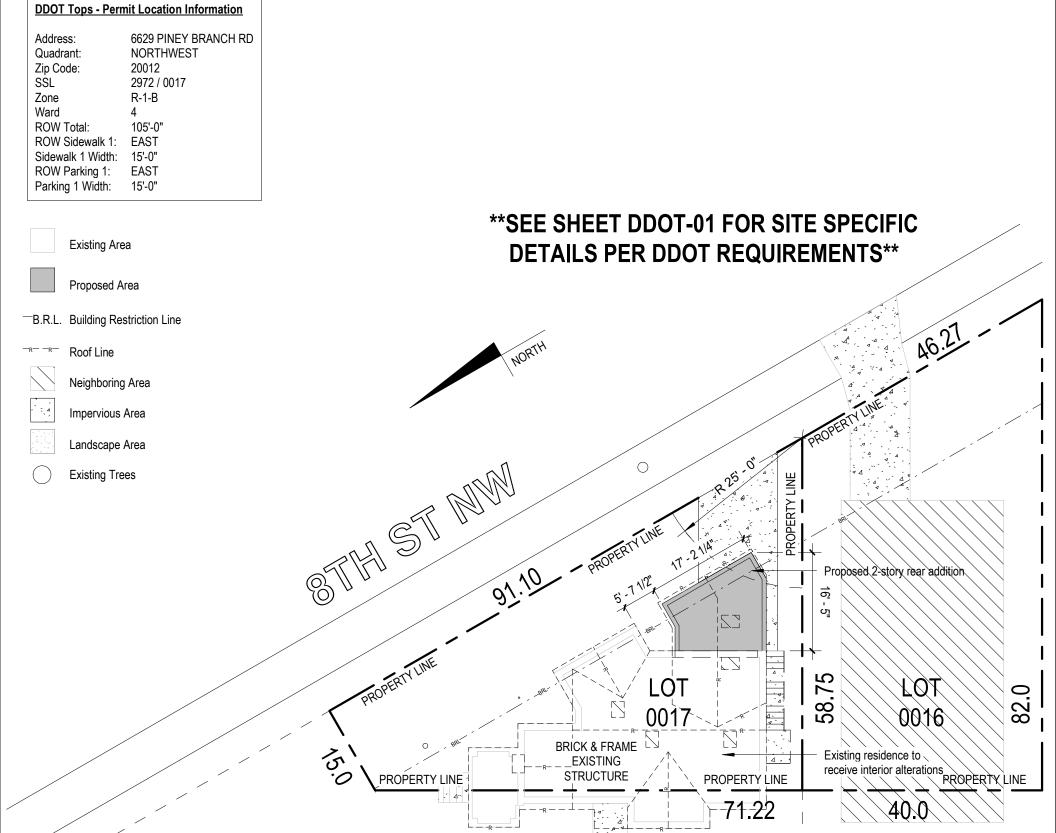

# PINEY BRANCH RD NW



BANULESCU 6629 PINEY BRANCH RD NW WASHINGTON, DC 20012

		ZONING REPORT
Scale	1/16" = 1'-0"	
Project number	230915	A-0100
Date	03/04/2025	

## **BUILDING CODE AND ZONING SUMMARY**

**OWNER INFORMATION** 

NAME: NATALIA BANULESCU-BOGDAN & AIDA CAVALIC
ADDRESS: 6629 PINEY BRANCH RD NW, WASHINGTON DC 20012
EMAIL: NATALITZA@GMAIL.COM & AIDA13@GMAIL.COM

PHONE NUMBER: n/a

**AUTHORITY HAVING JURISDICTION** DISTRICT OF COLUMBIA - DCMR

APPLICABLE BUILDING CODES All DCMR Title 12 Amendments -

2017 DCMR 12A, DC Building Code Amendments 2015 International Building Code (IBC) - 2017 DCMR 12B, DC Residential Code Amendments 2015 International Residential Code (IRC) - 2017 DCMR 12C, DC Electrical Code (IRC) - 2014 National Electrical Code (NEC), NFPA 70 - 2017 DCMR 12D, DC Fuel Gas Code 2015 International Fuel Gas Code (IFGC) - 2017 DCMR 12E, DC Mechanical Code 2015 International Mechanical Code (IMC) -

2017 DCMR 12F, DC Plumbing Code 2015 International Plumbing Code (IPC) -2017 DCMR 12G, DC Property Maintenance Code 2015 International Property Maintenance Code (IPMC) -

2017 DCMR 12H, DC Fire Code 2015 International Fire Code (IFC) -

2017 DCMR 12I, DC Energy Conservation Code

2015 International Energy Conservation Code - Residential Provisions -

2013 ANSI / ASHRAE / IES 90.1

2017 DCMR 12J, DC Existing Building Code -

2015 Existing Building Code

2017 DCMR 12K. DC Green Construction Code -2012 International Green Constructoin Code (IGCC) 2017 DCMR 12I, Energy Conservation Code Supplement of

2017 - Residential Provisions

2015 International Existing Building Code (IEBC)

EXISTING CONSTRUCTION CLASSIFICATION III-B PROPOSED CONSTRUCTION CLASSIFICATION III-B

EXISTING BUILDING OCCUPANCY USE GROUP R-1-B (SINGLE FAMILY DETACHED)
PROPOSED BUILDING OCCUPANCY USE GROUP R-1-B (SINGLE FAMILY DETACHED)

# **GENERAL INFORMATION:** GROSS FLOOR AREA (GFA)

LEVELEXISTING AREA(SF)PROPOSED AREA(SF)BASEMENT + PORCH885969

 BASEMENT + FORCH
 805

 1ST FLOOR + PORCH
 899

 2ND FLOOR
 325

 TOTAL
 2,109

 2,615

FLOOR AREA RATIOEXISTINGPROPOSEDBUILDING USE:SINGLE FAMILYEXISTING TO REMAIN# OF STORIES:1.52STORIES PLUS:BASEMENTEXISTING TO REMAIN# OF DWELLING UNITS:1EXISTING TO REMAIN

AREA COVERAGE:EXISTINGPROPOSEDTOTAL LOT AREA (SQFT):2,775 SQFTEXISTING TO REMAINSIDE YARD SETBACK (LEFT)15'- 6" FTEXISTING TO REMAINSIDE YARD SETBACK (RIGHT)6'- 0" FTEXISTING TO REMAIN

13'- 2.5" FT

BUILDING AREA:EXISTINGPROPOSEDLOT OCCUPANCY:38%41%PERVIOUS SURFACE:12%8%

PERVIOUS SURFACE: 12% 8% GREEN AREA RATIO (GAR): 50% 51%

EXISTING FOOTPRINT AREA OF BUILDING: 1,064 SQFT (Within Property Line)
PROPOSED FOOTPRINT AREA OF BUILDING: 1,139 SQFT (Within Property Line)
FLOORS INVOLVED IN THIS PROJECT: ALL LEVELS (2,546 SQFT)

\*\*TAXABLE ASSESSMENT (2023) \$515,636.00

BUILDING CONSTRUCTION TYPE: TYPE III NON COMBUSTIBLE EXTERIOR WALLS



6316 2nd Street NW, Washington DC 20011

REAR YARD SETBACK

BANULESCU 6629 PINEY BRANCH RD NW WASHINGTON, DC 20012

**RESIDENTIAL RENOVATION & ADDITION** 


12'- 2.5" FT


NIVA/		
NW   012	Scale	1/4" = 1'-0"
711	Project number	230915
11/1		

03/04/2025

A-0101

**ZONING SUMMARY** 

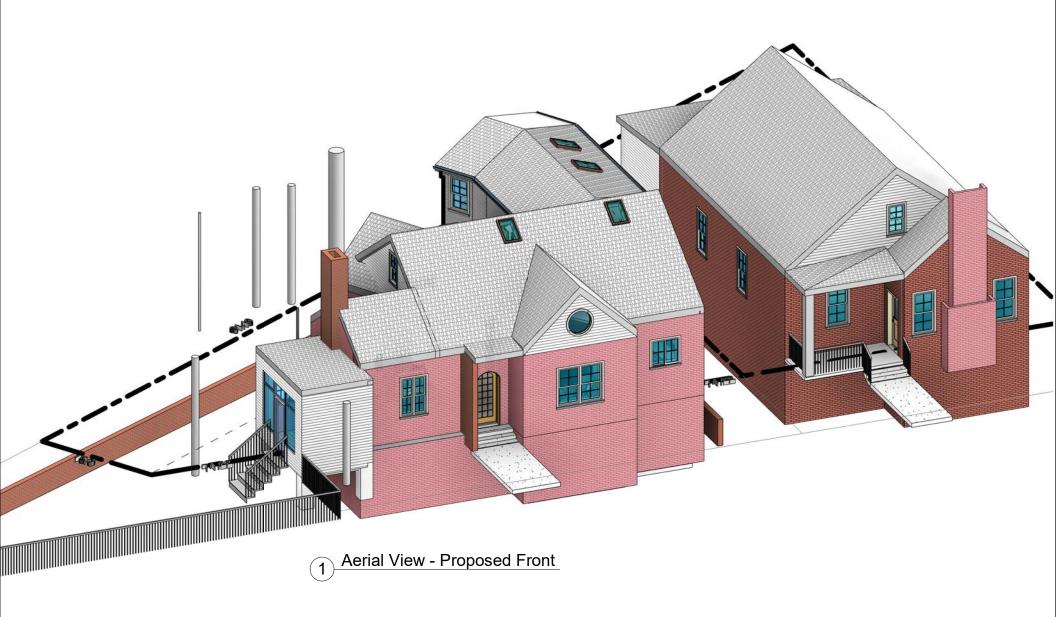

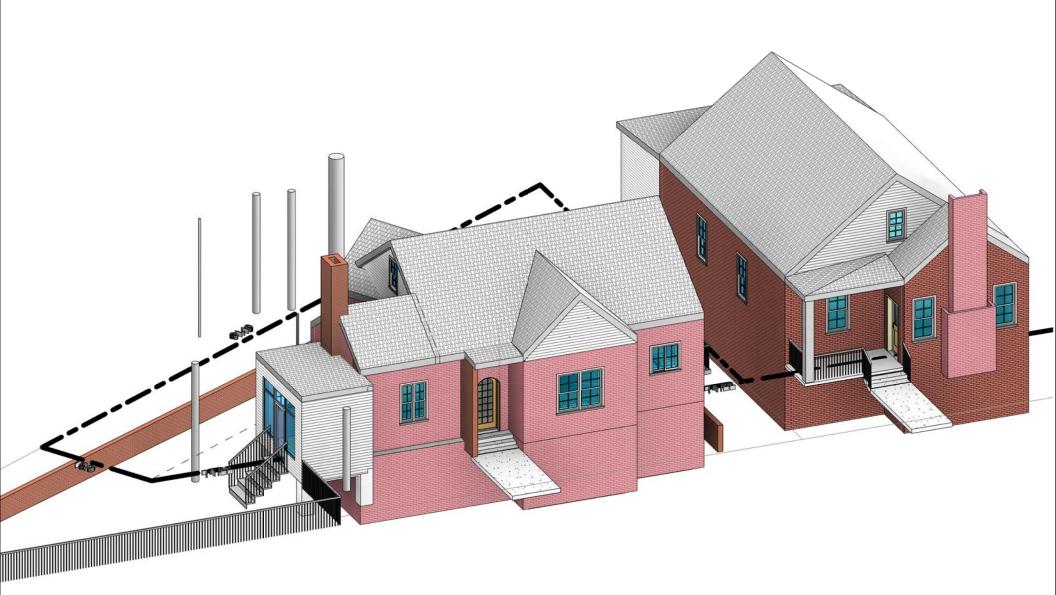



2 Aerial View - Existing Front



BANULESCU 6629 PINEY BRANCH RD NW WASHINGTON, DC 20012


		AERIAL VIEWS - FRONT
Scale		
Project number	230915	A-0102
Date	03/04/2025	

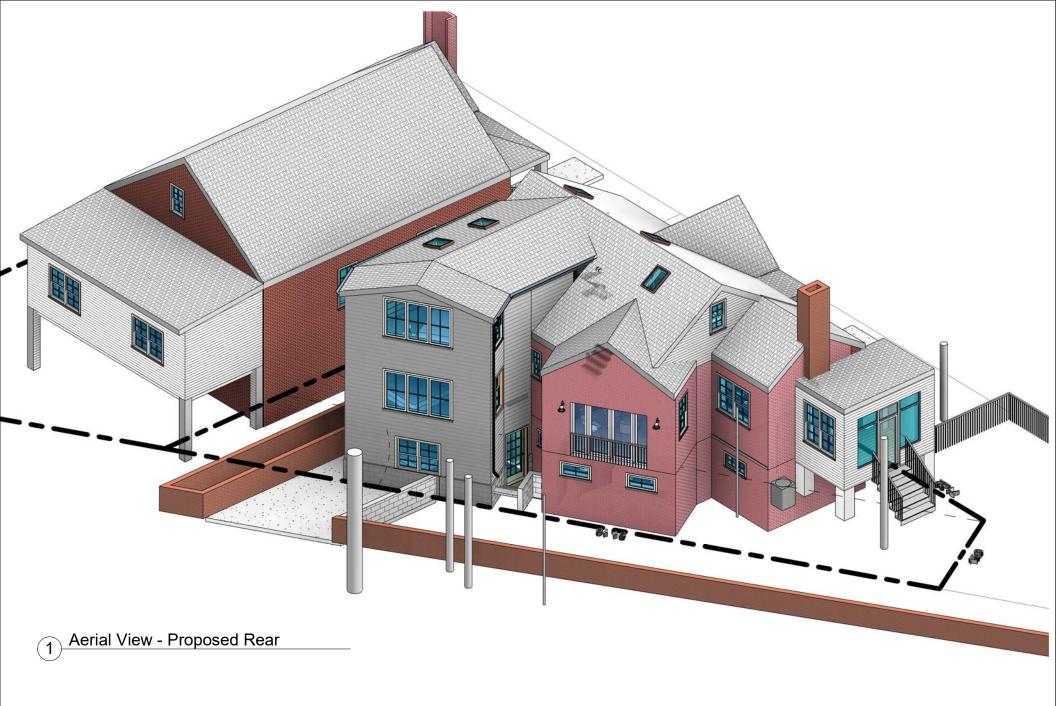

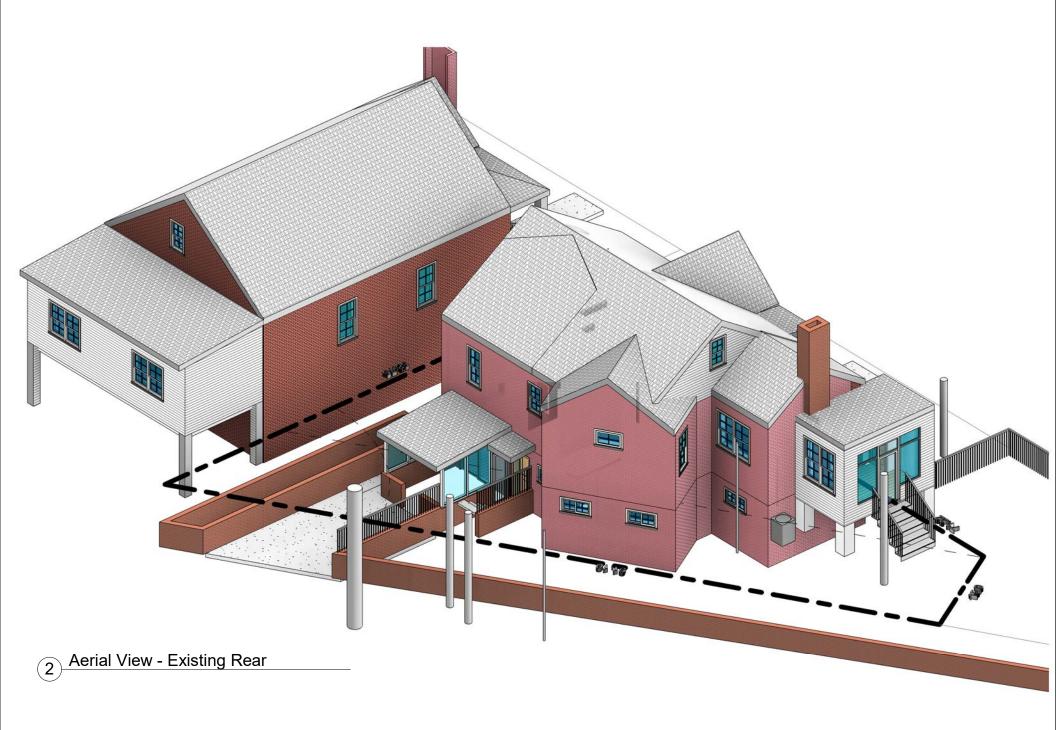





		AERIAL VIEWS - REAR
Scale		
Project number	230915	A-0103
Date	03/04/2025	

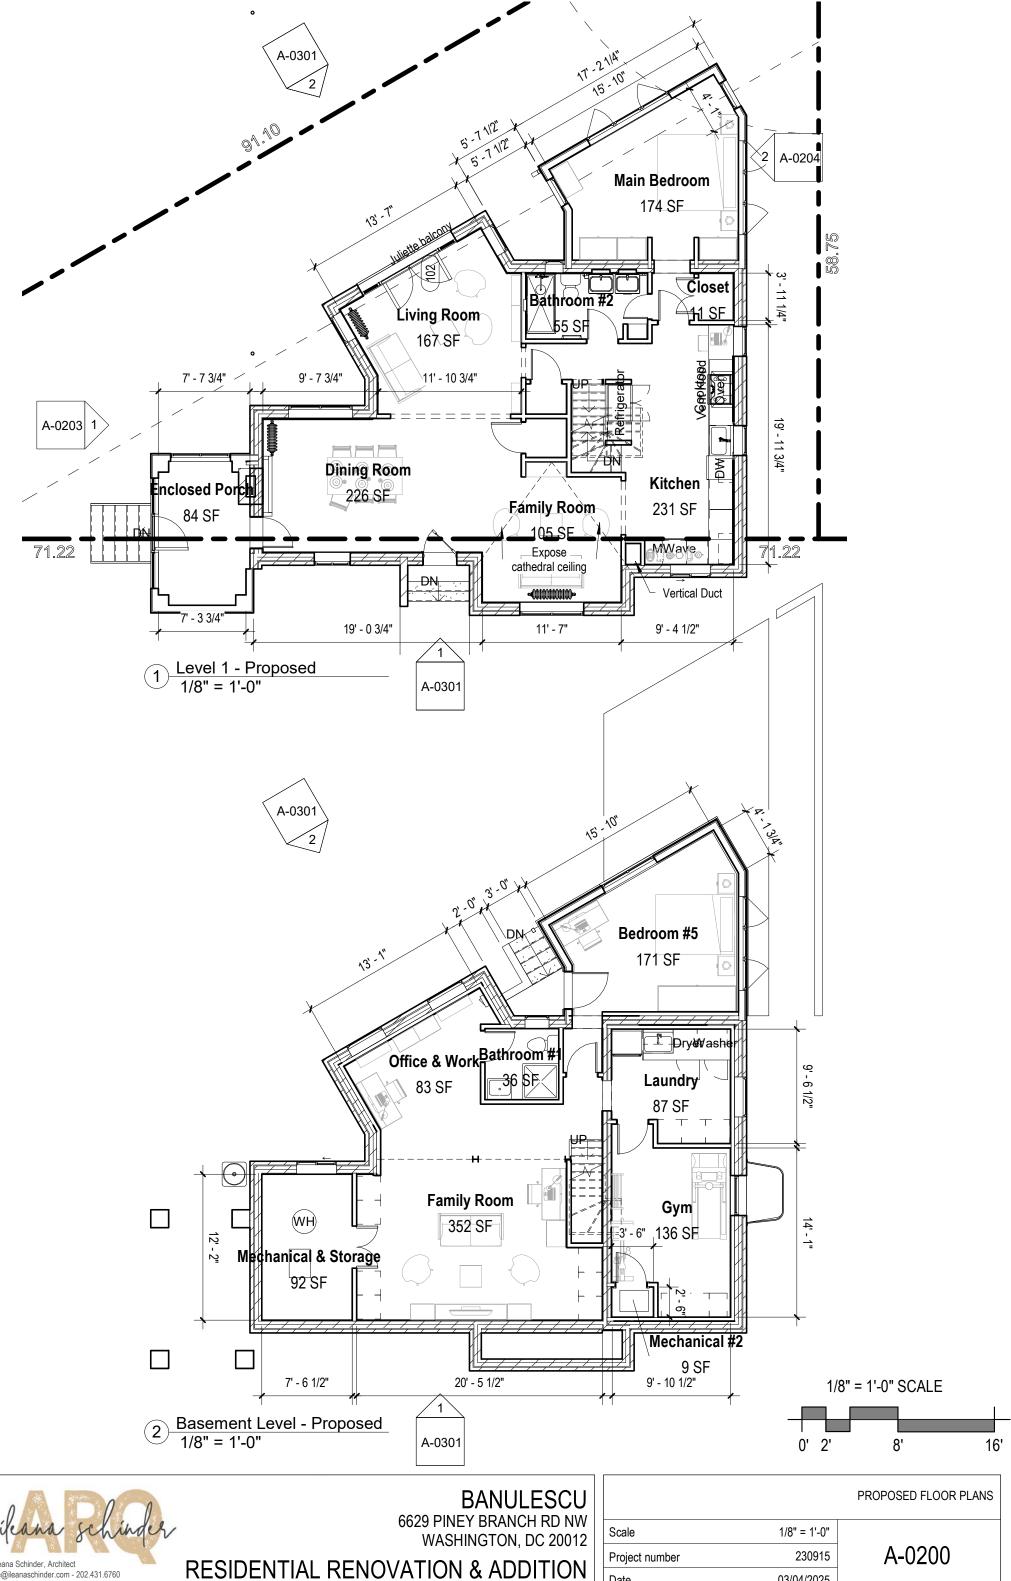


ile@ileanaschinder.com - 202.431.6760 6316 2nd Street NW, Washington DC 20011 Date 03/04/2025 3/4/2025 4:36:25 PM

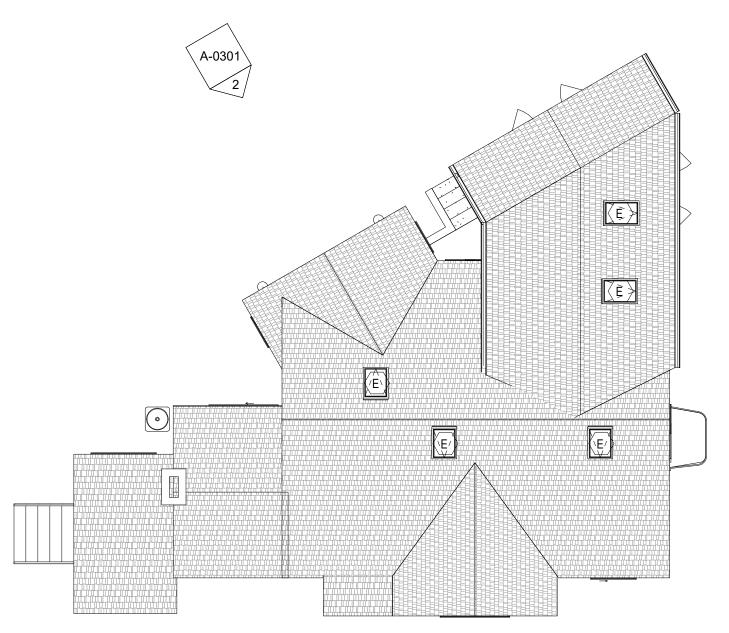

2 Roof Plan 1/8" = 1'-0"

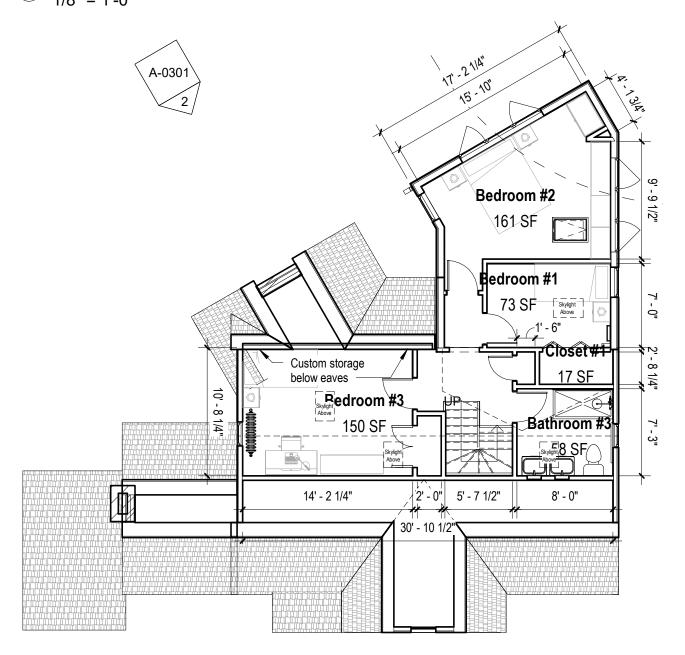

1 Level 2 - Proposed 1/8" = 1'-0"

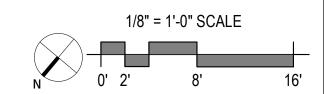



BANULESCU 6629 PINEY BRANCH RD NW WASHINGTON, DC 20012


		PROPOSED FLOOR PLANS
Scale	1/8" = 1'-0"	
Project number	230915	A-0201
Date	03/04/2025	



1 East View - Proposed
1/8" = 1'-0"



Northwest View - Proposed
1/8" = 1'-0"

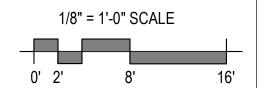



BANULESCU 6629 PINEY BRANCH RD NW WASHINGTON, DC 20012


		PROPOSED ELEVATIONS
Scale	1/8" = 1'-0"	
Project number	230915	A-0203
Date	03/04/2025	



Southeast View - Proposed
1/8" = 1'-0"




West View - Proposed
1/8" = 1'-0"

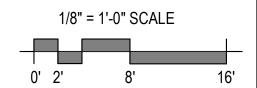




BANULESCU 6629 PINEY BRANCH RD NW WASHINGTON, DC 20012


		PROPOSED ELEVATIONS
Scale	1/8" = 1'-0"	
Project number	230915	A-0204
Date	03/04/2025	

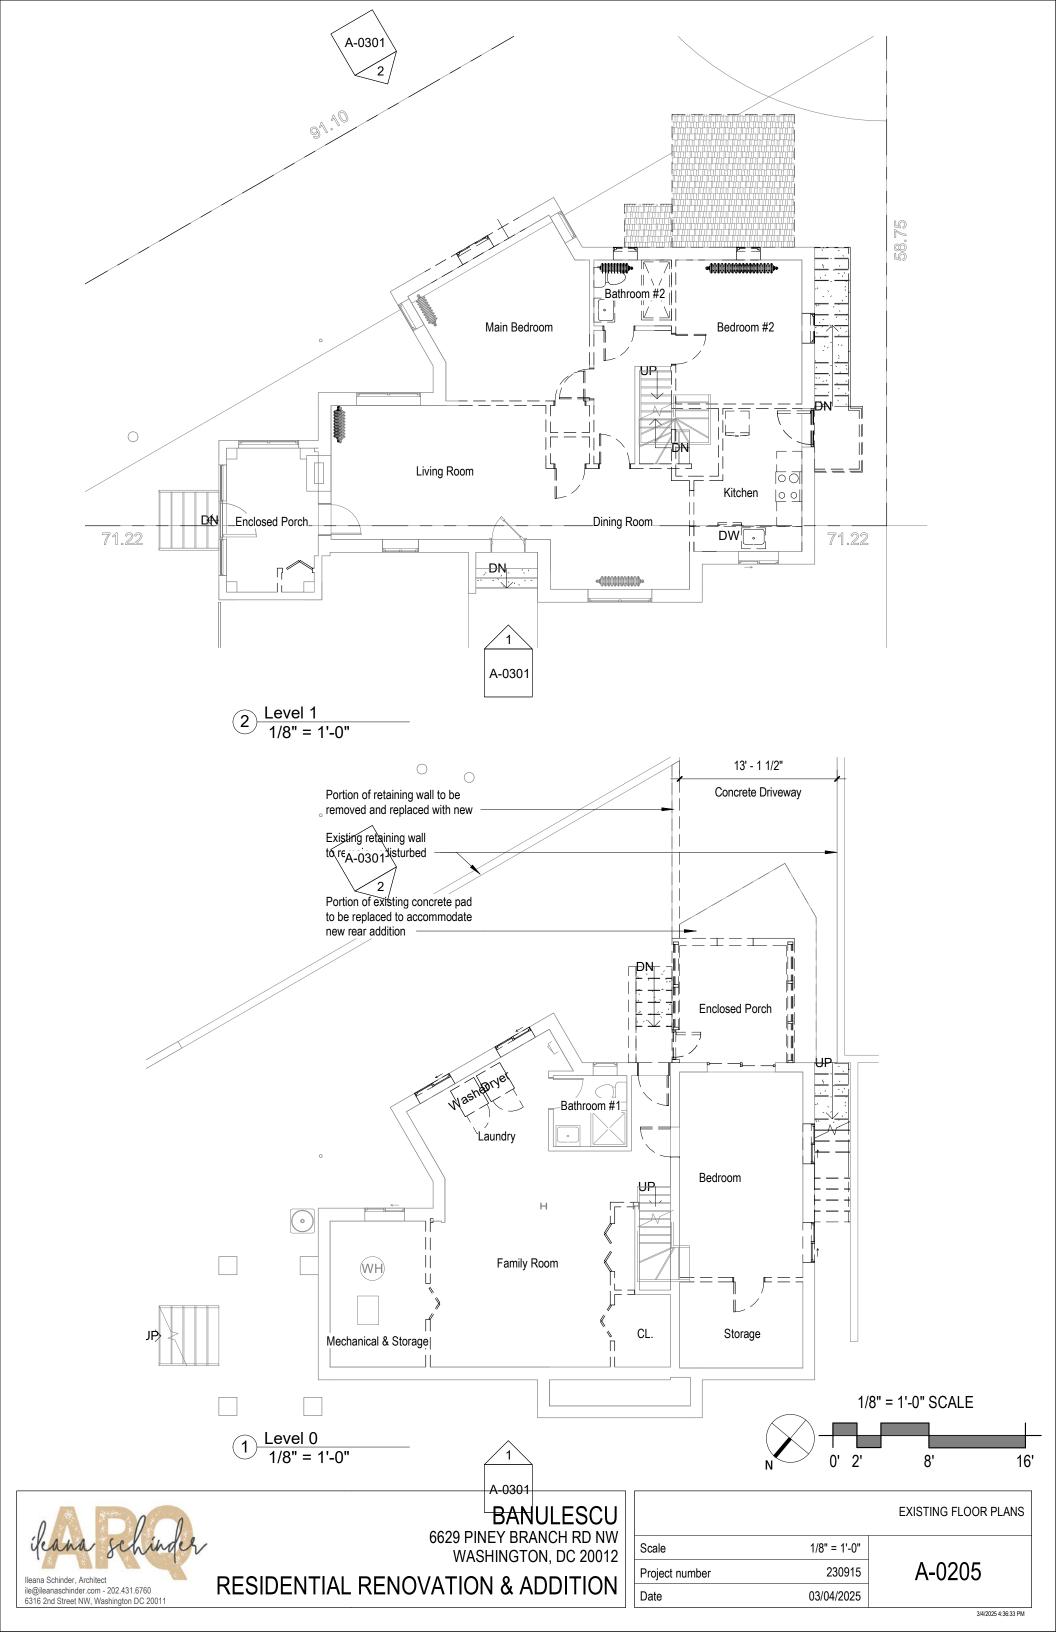




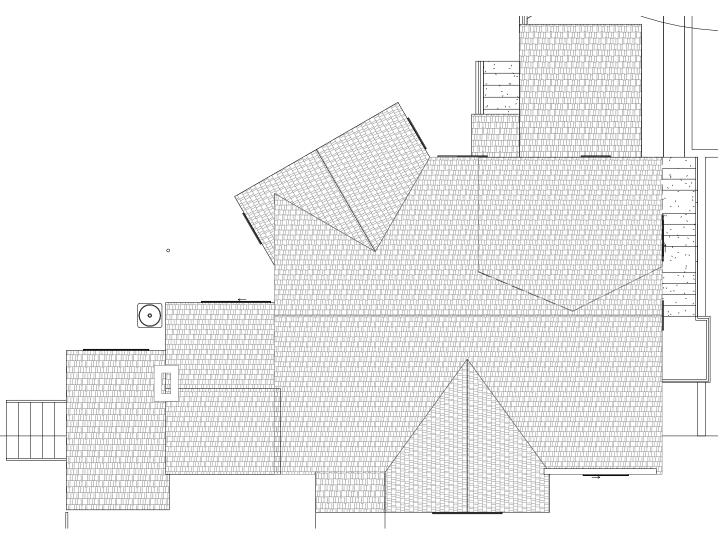




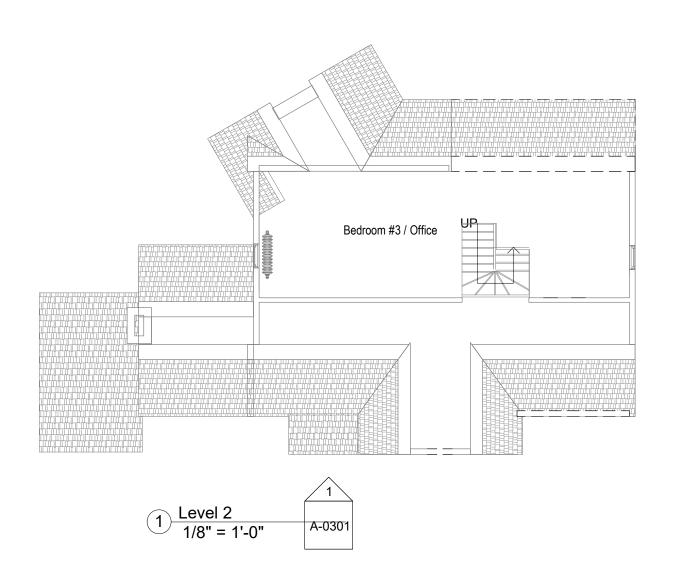

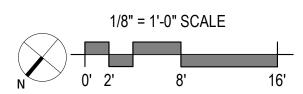



		EXISTING FLOOR PLANS
Scale	1/8" = 1'-0"	
Project number	230915	A-0206
Date	03/04/2025	

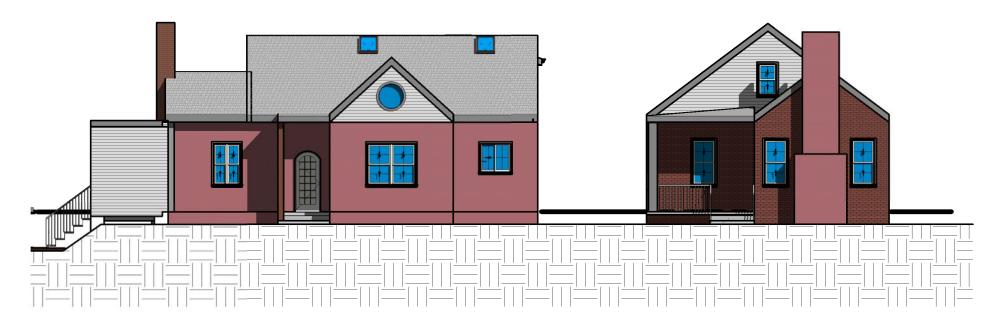

Northeat (Front) View - Summer Solciste 3/32" = 1'-0"



Southeast View - Proposed Summer

Solciste 3/32" = 1'-0"



Southwest View - Existing Summer Solciste 3/32" = 1'-0"




**BANULESCU** 6629 PINEY BRANCH RD NW

WASHINGTON, DC 20012 **RESIDENTIAL RENOVATION & ADDITION** 

SUMMER SUN SHADE STUDY - ELEVATION 3/32" = 1'-0"

Scale Project number 230915 Date 03/04/2025

A-0300

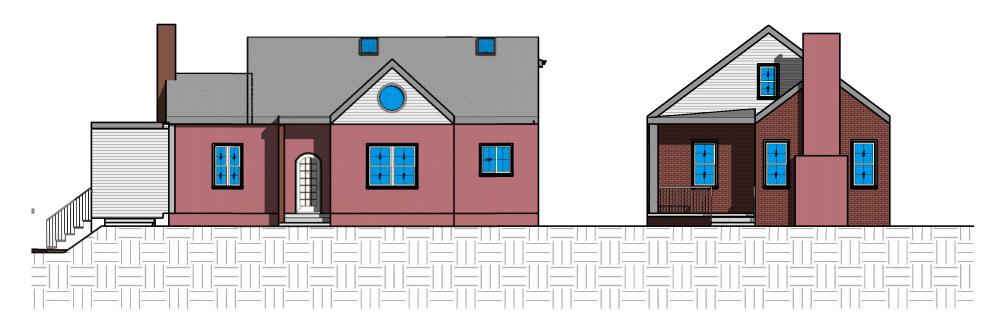

Northeast (Front) View - Winter Solciste 3/32" = 1'-0"



Southeast View - Proposed Winter Solciste 3/32" = 1'-0"



3 Southwest View - Existing Winter Solciste
3/32" = 1'-0"



**BANULESCU** 6629 PINEY BRANCH RD NW WASHINGTON, DC 20012

Project number


Date

**RESIDENTIAL RENOVATION & ADDITION** 

WINTER SUN SHADE STUDY - ELEVATION 3/32" = 1'-0" Scale A-0301

230915

03/04/2025

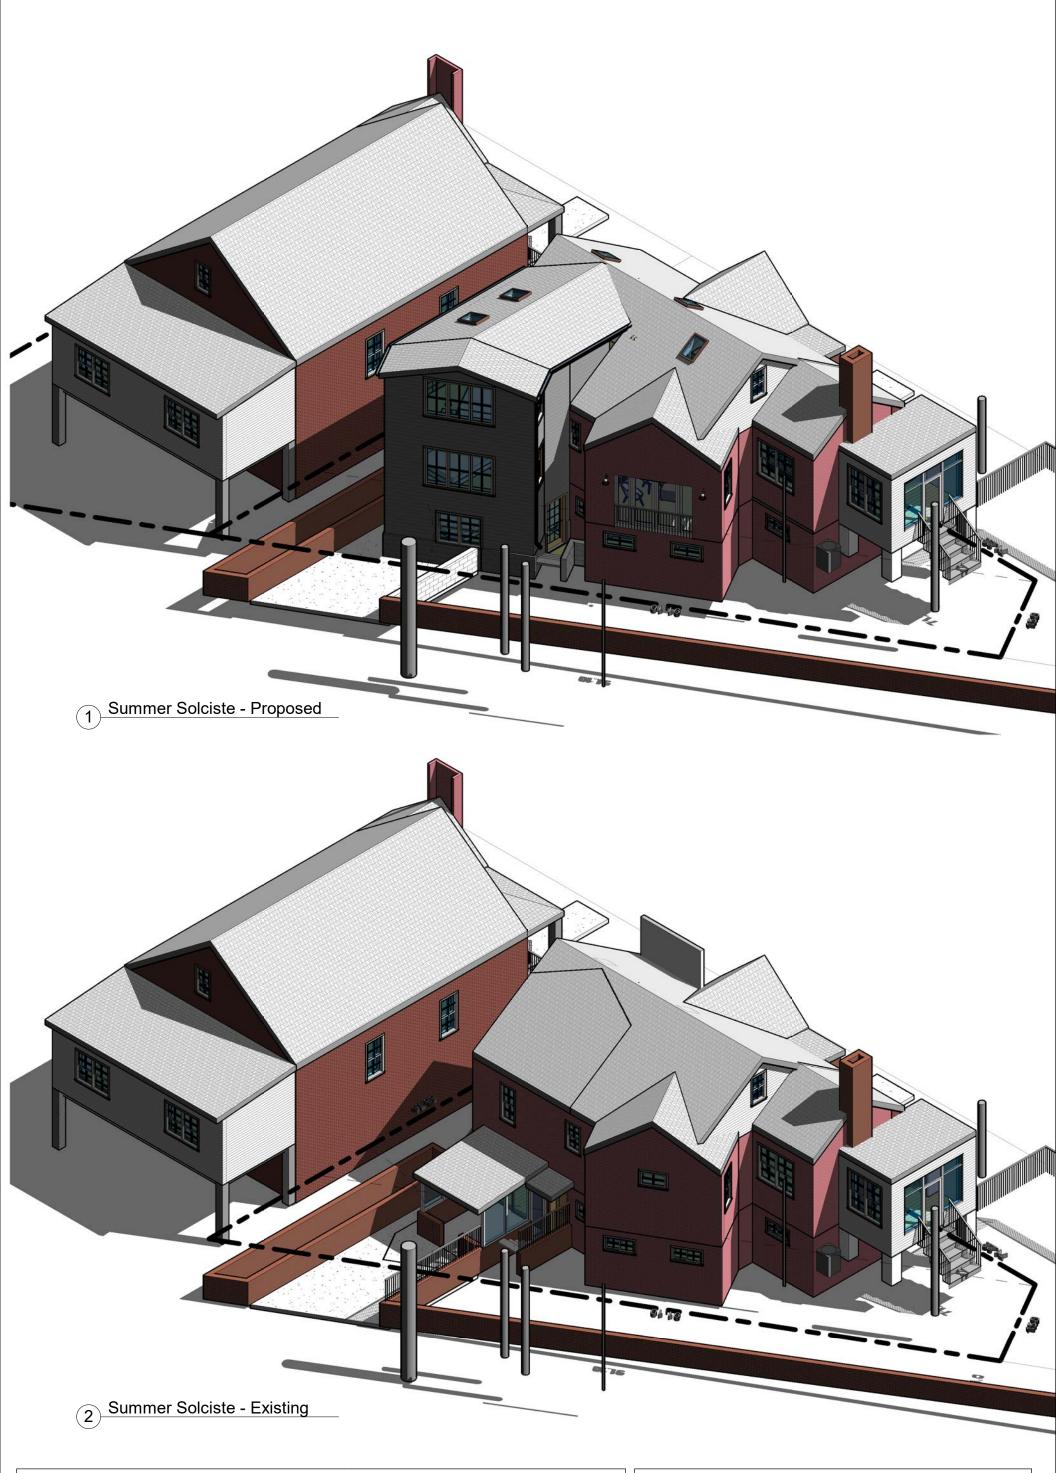



**RESIDENTIAL RENOVATION & ADDITION** 

	SUMMER SUN SHADE STUDY - PERSPECTIVE	
Scale		
Project number	230915	A-0302

03/04/2025

Date







Date

**RESIDENTIAL RENOVATION & ADDITION** 

 WINTER SUN SHADE STUDY - PERSPECTIVE

 Scale
 A-0303

03/04/2025