RESIDENCE 1347

1347 G STREET SE WASHINGTON, DC 20003

ISSUED FOR:

PERMIT

ISSUED DATE: 07 FEBRUARY 2018

ARCHITEC
T:
//3877

David Shove-Brown, AIA, NCARB Ryan Petyak, AIA, NCARB 3333 K Street NW_Suite 60 WASHINGTON, DC 20007 [T] 202.350.4244 [F] 202.350.4245 [W] 3877.DESIGN **CLIENT:**

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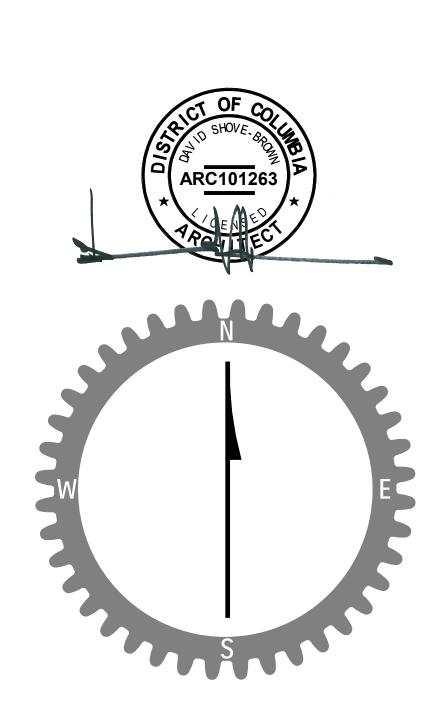
STRUCTURAL ENGINEER:


CRC Design Associates, LLC

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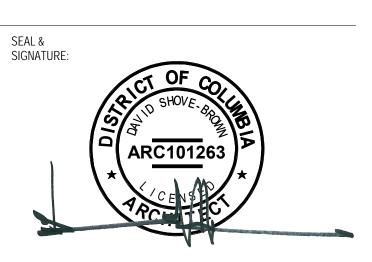
DRAWING DATA

PROJECT: RESIDENCE 1347

ADDRESS: 1347 G ST SE
WASHINGTON, DC 20003

 NO.
 ISSUE
 DATE

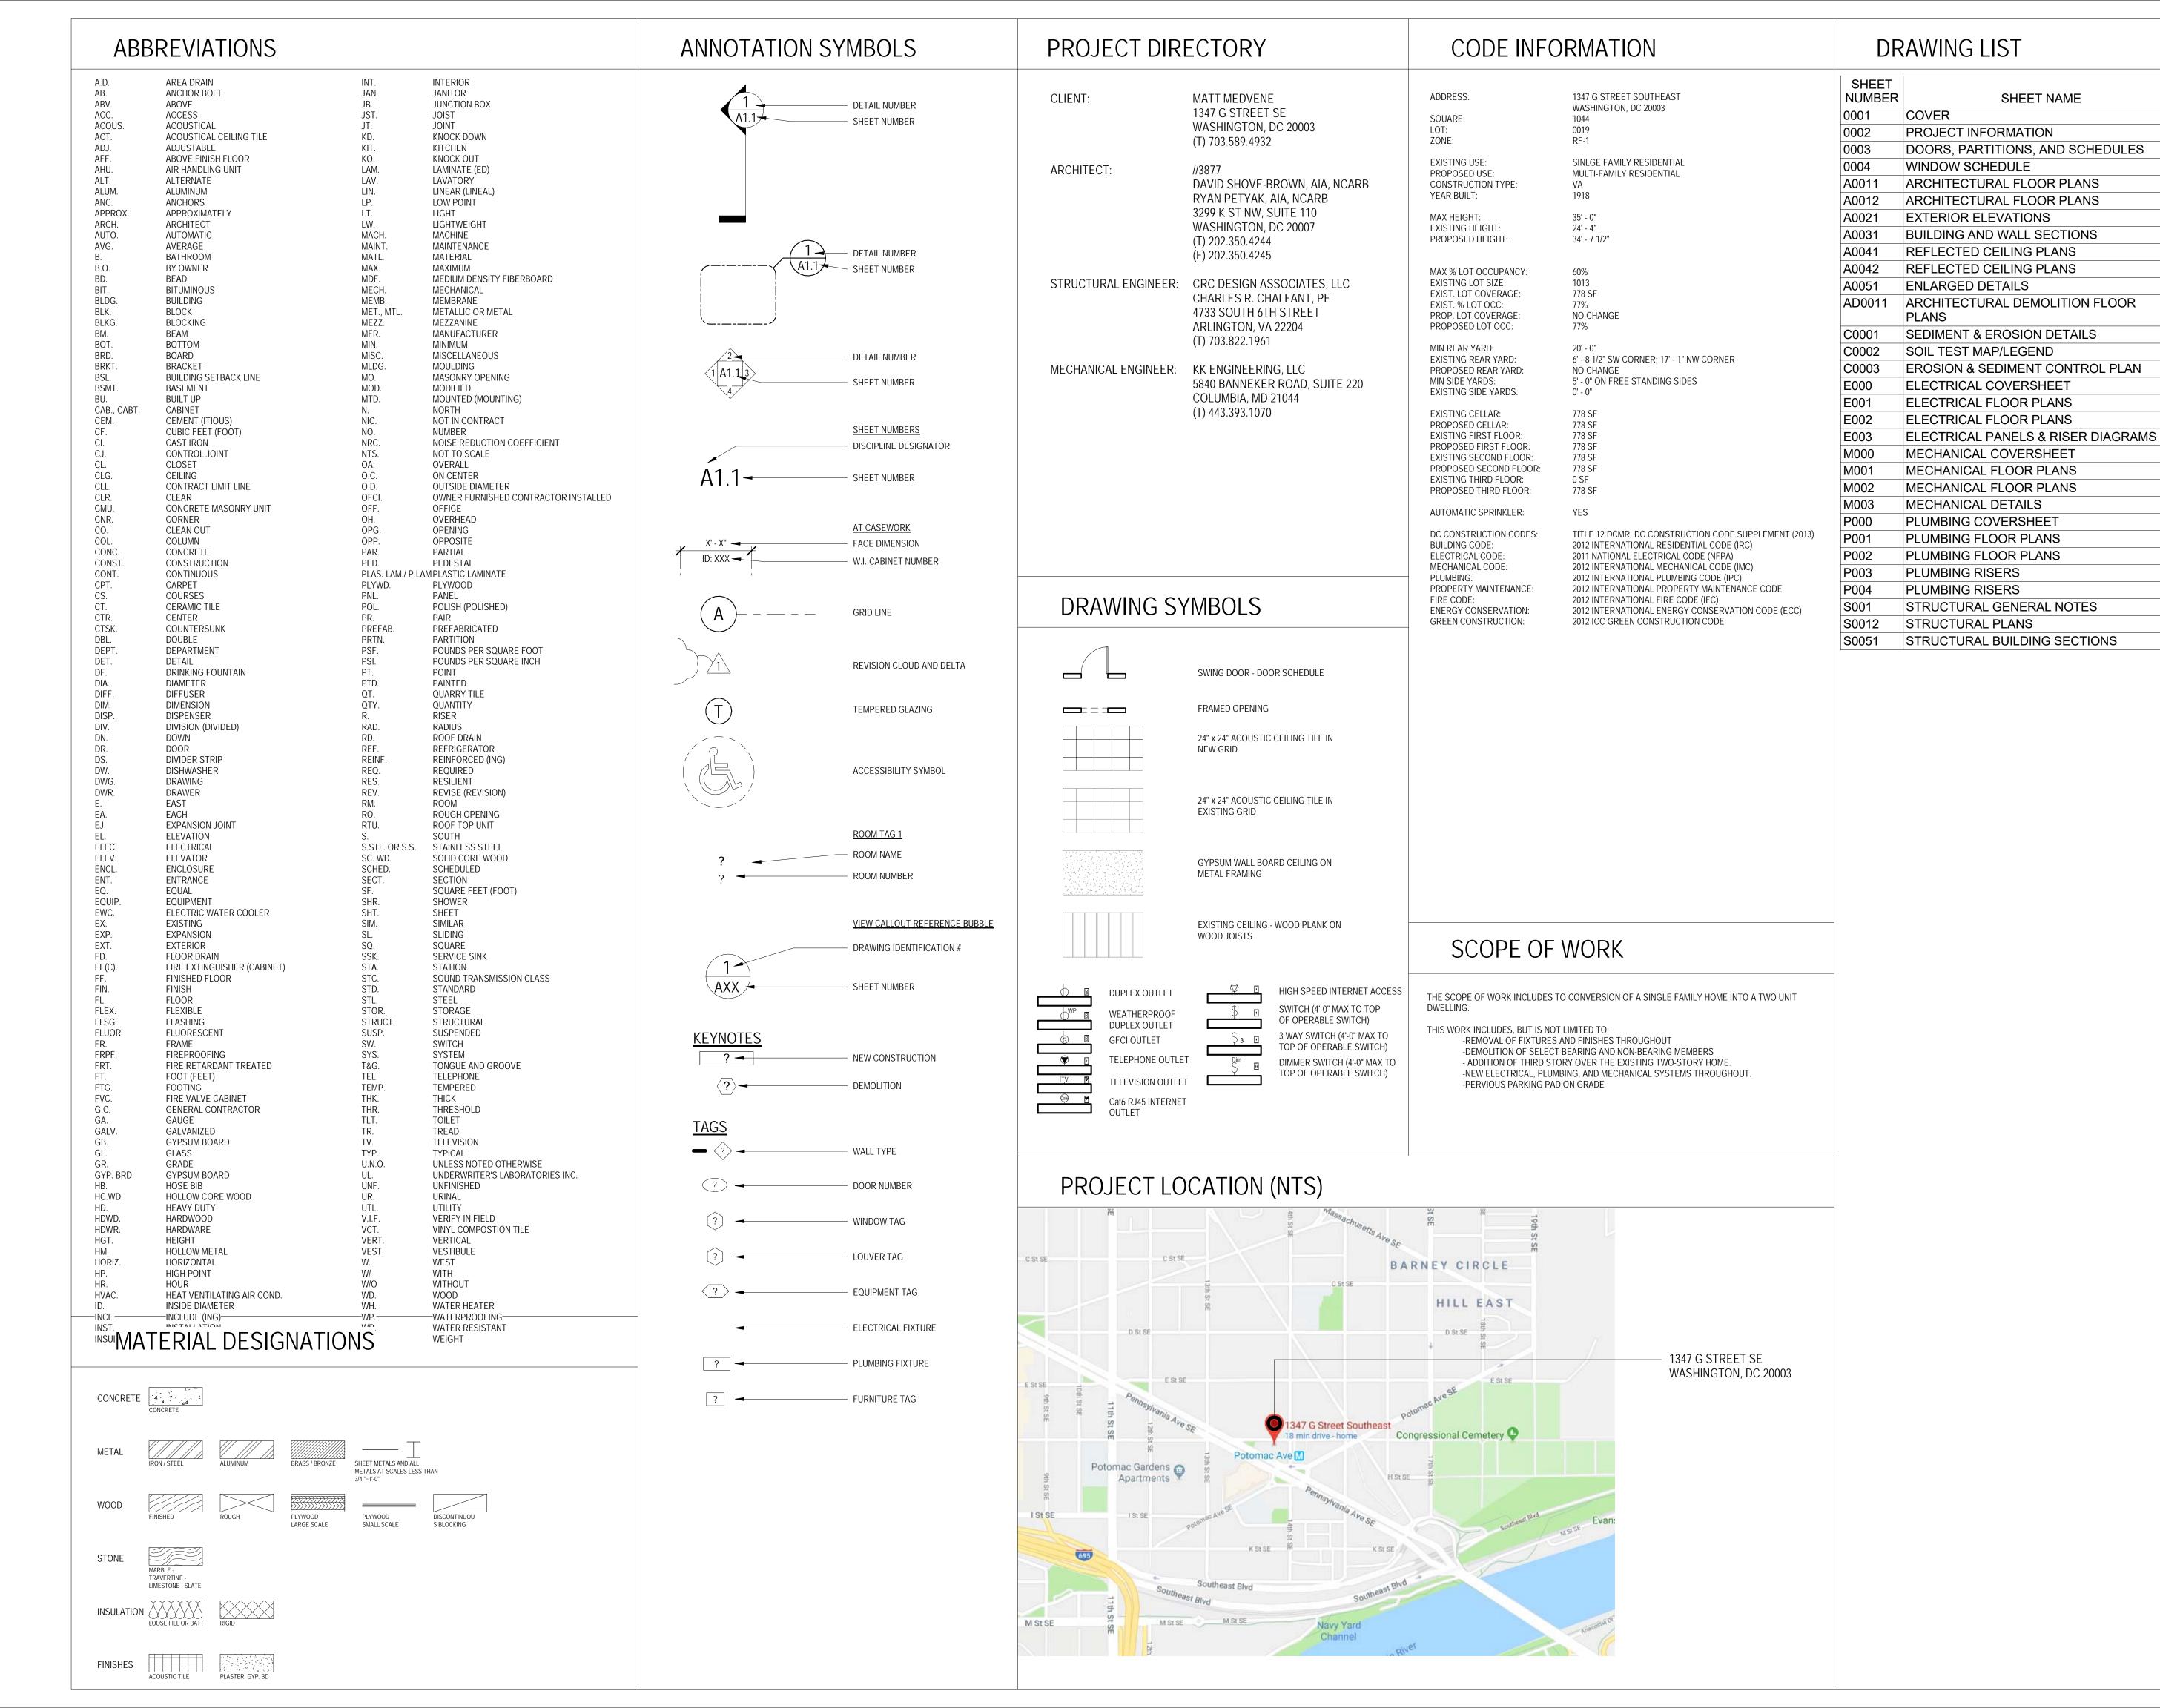 0
 FOR PERMIT
 03/22/2018



SHEET TITLE: PROJECT INFORMATION

PROJECT NO: 2017.157

04/08/16

SCALE: As indicated

0002

MAP LEGEND

Area of Interest (AOI)

Area of Interest (AOI)

Soils
Soil Map Units
Special Point Features

Blowout

Borrow Pit

Clay Spot

Closed Depression

∴ Gravel Pit∴ Gravelly Spot△ Landfill∧ Lava Flow

Marsh or swamp
Mine or Quarry
Miscellaneous Water
Perennial Water

Rock Outcrop

+ Saline Spot

Sandy Spot

Severely Eroded Spot

♦ Sinkhole♦ Slide or SlipØ Sodic Spot■ Spoil Area

Stony Spot

MAI LEGEND

Other

Special Line Features
Gully
Short Steep Slope
Other

Transportation
Rails
Interstate Highways

US Routes

Major Roads

MAP INFORMATION

Map Scale: 1:39,700 if printed on D size (22" × 34") sheet.

The soil surveys that comprise your AOI were mapped at 1:12,000.

Please rely on the bar scale on each map sheet for accurate map measurements.

Source of Map: Natural Resources Conservation Service Web Soil Survey URL: http://websoilsurvey.nrcs.usda.gov Coordinate System: UTM Zone 18N NAD83

This product is generated from the USDA-NRCS certified data as of the version date(s) listed below.

Soil Survey Area: District of Columbia Survey Area Data: Version 5, Sep 14, 2006

Survey Area Data: Version 5, Sep 14, 2006

Date(s) aerial images were photographed: 6/24/2003; 6/21/2005; 6/25/2003; 6/15/2005; 6/23/2005

The orthophoto or other base map on which the soil lines were compiled and digitized probably differs from the background imagery displayed on these maps. As a result, some minor shifting of map unit boundaries may be evident.

Map Unit Symbol	Map Unit Name	Acres in AOI	Percent of AOI	
AsC	Ashe loam, 8 to 15 percent slopes	44.8	0.1	
AsD	Ashe loam, 15 to 40 percent slopes	111.0	0.3	
BdB	Beltsville silt loam, 0 to 8 percent slopes	39.7	0.1	
BeB	Beltsville-Urban land complex, 0 to 8 percent	599.5	1.4	
Deb	slopes	588.5	1.4	
Bg	Bibb sandy loam	148.9	0.3	
BnB	Bourne fine sandy loam, 0 to 8 percent slopes	9.8	0.0	
BnC	Bourne fine sandy loam, 8 to 15 percent slopes	49.8	0.1	
ВрВ	Bourne-Urban land complex, 0 to 8 percent slopes	34.4	0.1	
BrC	Brandywine gravelly loam, 8 to 15 percent slopes	31.9	0.1	
BrD	Brandywine gravelly loam, 15 to 40 percent slopes	226.6	0.5	
BtB	Brandywine-Urban land complex, 0 to 8 percent slopes	132.2	0.3	
BtC	Brandywine-Urban land complex, 8 to 15 percent slopes	481.0	1.1	
BtD	Brandywine-Urban land complex, 15 to 40 percent slopes	119.5	0.3	
CcB	Chillum silt loam, 0 to 8 percent slopes	28.7	0.1	
CoC	Chillum silt loam, 8 to 15 percent slopes	126.8	0.3	
CcD	Chillum silt loam, 15 to 40 percent slopes	83.0	0.2	
CdB	Chillum-Urban land complex, 0 to 8 percent slopes	470.2	1.1	
CdC	Chillum-Urban land complex, 8 to 15 percent slopes	1,021.7	2.3	
CdD	Chillum-Urban land complex, 15 to 40 percent slopes	130.5	0.3	
CeB	Christiana silt loam, 0 to 8 percent slopes	55.2	0.1	
CeC	Christiana silt loam, 8 to 15 percent slopes	186.2	0.4	
CeD	Christiana silt loam, 15 to 40 percent slopes	186.8	0.4	
CfB	Christiana-Urban land complex, 0 to 8 percent slopes	456.9	1.0	
CfC	Christiana-Urban land complex, 8 to 15 percent slopes	1,509.2	3.4	
CfD	Christiana-Urban land complex, 15 to 40 percent slopes	214.7	0.5	
Ck	Codorus silt loam	187.3	0.4	
Cn	Codorus-Urban land complex	90.7	0.2	

District of Columbia (DC001)				
Map Unit Symbol	Map Unit Name	Acres in AOI	Percent of AOI	
CwB	Croom very gravelly sandy loam, 0 to 8 percent slopes	10.3	0.09	
CwC	Croom very gravelly sandy loam, 8 to 15 percent slopes	90.6	0.2	
CwD	Croom very gravelly sandy loam, 15 to 40 percent slopes	148.5	0.39	
CxB	Croom-Urban land complex, 0 to 8 percent slopes	68.1	0.2	
CxC	Croom-Urban land complex, 8 to 15 percent slopes	280.9	0.6	
CxD	Croom-Urban land complex, 15 to 25 percent slopes	44.5	0.1	
Dn	Dunning soils	48.9	0.1	
Fa	Fallsington sandy loam	20.5	0.0	
FB	Fluvaquents, bouldery	64.9	0.1	
FD	Fluvaquents, ponded	54.8	0.1	
FF	Fluvaquents-Udifluvents complex, frequently flooded	43.5	0.1	
FH	Fluvaquents-Udifluvents-Urban land complex	87.8	0.2	
GeB	Galestown-Urban land complex, 0 to 8 percent slopes	591.2	1.3	
GfB	Galestown and Rumford soils, 0 to 8 percent slopes	62.3	0.1	
GfC	Galestown and Rumford soils, 8 to 15 percent slopes	13.3	0.0	
GgB	Glenelg loam, 0 to 8 percent slopes	29.4	0.1	
GgC	Glenelg loam, 8 to 15 percent slopes	169.0	0.4	
GgD	Glenelg loam, 15 to 25 percent slopes	40.6	0.1	
GhB	Glenelg-Urban land complex, 0 to 8 percent slopes	190.2	0.4	
GhC	Glenelg-Urban land complex, 8 to 15 percent slopes	446.8	1.0	
GhD	Glenelg-Urban land complex, 15 to 25 percent slopes	29.7	0.1	
GIB	Glenelg variant silt loam, 0 to 8 percent slopes	39.8	0.1	
GmB	Glenelg variant-Urban land complex, 0 to 8 percent slopes	263.6	0.6	
lk	luka sandy loam	233.2	0.5	
lp	luka-Urban land complex	239.2	0.5	
JtB	Joppa gravelly sandy loam, 0 to 8 percent slopes	10.5	0.0	
JtC	Joppa gravelly sandy loam, 8 to 15 percent slopes	57.2	0.1	
JtD	Joppa gravelly sandy loam, 15 to 40 percent slopes	126.8	0.3	
JuB	Joppa-Urban land complex, 0 to 8 percent slopes	46.0	0.1	

Map Unit Symbol	Map Unit Name	Acres in AOI	Percent of AOI
JuC	Joppa-Urban land complex, 8 to 15 percent slopes	63.0	0.19
JuD	Joppa-Urban land complex, 15 to 25 percent slopes	28.1	0.19
KeB	Keyport fine sandy loam, 0 to 8 percent slopes	87.9	0.29
KeC	Keyport fine sandy loam, 8 to 15 percent slopes	29.6	0.19
KmB	Keyport-Urban land complex, 0 to 8 percent slopes	325.6	0.79
KmC	Keyport-Urban land complex, 8 to 15 percent slopes	100.8	0.29
Ld	Lindside loam	143.3	0.39
Lp	Lindside silt loam, bedrock substratum	107.3	0.29
MbC	Manor loam, 8 to 15 percent slopes	212.1	0.59
MbD	Manor loam, 15 to 40 percent slopes	1,099.2	2.59
McC	Manor channery loam, 8 to 15 percent slopes	44.7	0.19
MdB	Manor-Urban land complex, 0 to 8 percent slopes	675.8	1.59
MdC	Manor-Urban land complex, 8 to 15 percent slopes	1,440.2	3.35
MdD	Manor-Urban land complex, 15 to 40 percent slopes	398.1	0.99
MgB	Matapeake silt loam, 0 to 8 percent slopes	18.4	0.09
MgC	Matapeake silt loam, 8 to 15 percent slopes	9.4	0.09
MhB	Matapeake-Urban land complex, 0 to 8 percent slopes	170.9	0.49
Мр	Melvin silt loam	219.7	0.59
MvB	Muirkirk variant complex, 0 to 8 percent slopes	45.5	0.19
MvC	Muirkirk variant complex, 8 to 15 percent slopes	183.2	0.49
MvD	Muirkirk variant complex, 15 to 40 percent slopes	521.8	1.25
NeC	Neshaminy silt loam, 8 to 15 percent slopes	22.1	0.19
NeD	Neshaminy silt loam, 15 to 40 percent slopes	118.0	0.39
NuC	Neshaminy-Urban land complex, 8 to 15 percent slopes	69.1	0.2
NuD	Neshaminy-Urban land complex, 15 to 40 percent slopes	23.1	0.19
Qu	Quarry	1.9	0.0
SaB	Sassafras sandy loam, 0 to 8 percent slopes	24.2	0.19
SaC	Sassafras sandy loam, 8 to 15 percent slopes	46.5	0.19
ScB	Sassafras gravelly sandy loam, 0 to 8 percent slopes	80.1	0.29
ScC	Sassafras gravelly sandy loam, 8 to 15 percent slopes	181.0	0.49
ScD	Sassafras gravelly sandy loam, 15 to 40 percent slopes	151.2	0.35

Map Unit Symbol	Map Unit Name	Acres in AOI	Percent of AOI
SgB	Sassafras-Urban land complex, 0 to 8 percent slopes	926.1	2.19
SgC	Sassafras-Urban land complex, 8 to 15 percent slopes	1,128.1	2.69
SgD	Sassafras-Urban land complex, 15 to 40 percent slopes	80.7	0.25
SmB	Sunnyside fine sandy loam, 0 to 8 percent slopes	48.8	0.19
SmC	Sunnyside fine sandy loam, 8 to 15 percent slopes	75.5	0.25
SmD	Sunnyside fine sandy loam, 15 to 40 percent slopes	58.4	0.19
SpB	Sunnyside-Urban land complex, 0 to 8 percent slopes	160.4	0.49
SpC	Sunnyside-Urban land complex, 8 to 15 percent slopes	381.3	0.99
SpD	Sunnyside-Urban land complex, 15 to 25 percent slopes	96.6	0.25
U1	Udorthents	2,548.2	5.89
U2	Udorthents, gravelly	75.5	0.29
U3	Udorthents, sandy	202.9	0.5
U4	Udorthents, loamy	149.6	0.3
U5	Udorthents, clayey	153.9	0.4
U6	Udorthents, smoothed	604.9	1.45
U7	Udorthents, gravelly, smoothed	285.4	0.79
U8	Udorthents, sandy, smoothed	271.3	0.6
U9	Udorthents, loamy, smoothed	129.0	0.3
U10	Udorthents, clayey, smoothed	482.6	1.1
U11B	Udorthents, deep, 0 to 8 percent slopes	262.5	0.6
U11C	Udorthents, deep, 8 to 15 percent slopes	45.5	0.19
U11D	Udorthents, deep, 15 to 25 percent slopes	32.2	0.19
UA	Udifluvents, sandy	62.2	0.19
Ub	Urban land	6,702.6	15.3
UcB	Urban land-Beltsville complex, 0 to 8 percent slopes	302.5	0.79
UdB	Urban land-Brandywine complex, 0 to 8 percent slopes	95.0	0.2
UeB	Urban land-Chillum complex, 0 to 8 percent slopes	1,231.8	2.89
UeC	Urban land-Chillum complex, 8 to 15 percent slopes	561.9	1.39
UfB	Urban land-Christiana complex, 0 to 8 percent slopes	87.4	0.29
UfC	Urban land-Christiana complex, 8 to 15 percent slopes	478.6	1.1

District of Columbia (DC001)			
Map Unit Symbol	Map Unit Name	Acres in AOI	Percent of AOI
UkC	Urban land-Croom complex, 8 to 15 percent slopes	79.9	0.2%
UmB	Urban land-Galestown complex, 0 to 8 percent slopes	248.7	0.6%
UoC	Urban land-Joppa complex, 0 to 15 percent slopes	174.6	0.4%
UpB	Urban land-Keyport complex, 0 to 8 percent slopes	163.9	0.4%
UsB	Urban land-Manor complex, 0 to 8 percent slopes	137.0	0.3%
UsC	Urban land-Manor complex, 8 to 15 percent slopes	226.5	0.5%
UxB	Urban land-Sassafras complex, 0 to 8 percent slopes	1,867.0	4.3%
UxC	Urban land-Sassafras complex, 8 to 15 percent slopes	940.7	2.1%
UyC	Urban land-Sunnyside complex, 8 to 15 percent slopes	117.8	0.3%
UzB	Urban land-Woodstown complex, 0 to 8 percent slopes	189.3	0.4%
w	Water	4,669.3	10.6%
WoB	Woodstown sandy loam, 0 to 8 percent slopes	82.4	0.2%
WpB	Woodstown-Urban land complex, 0 to 8 percent slopes	288.0	0.7%
Totals for Area of Interest		43.877.7	100.0%

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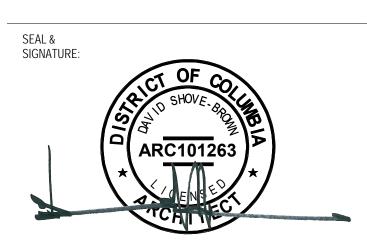
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DRAWING DATA

PROJECT: RESIDENCE1347

ADDRESS: 1347 G ST SE
WASHINGTON, DC 20003

NO.	ISSUE	DATE
0	FOR PERMIT	03/22/2018




SHEET TITLE: SOIL TEST MAP/LEGEND

PROJECT NO: 2017.1!

TE 04/08/16

SCALE: As indicated

C0002

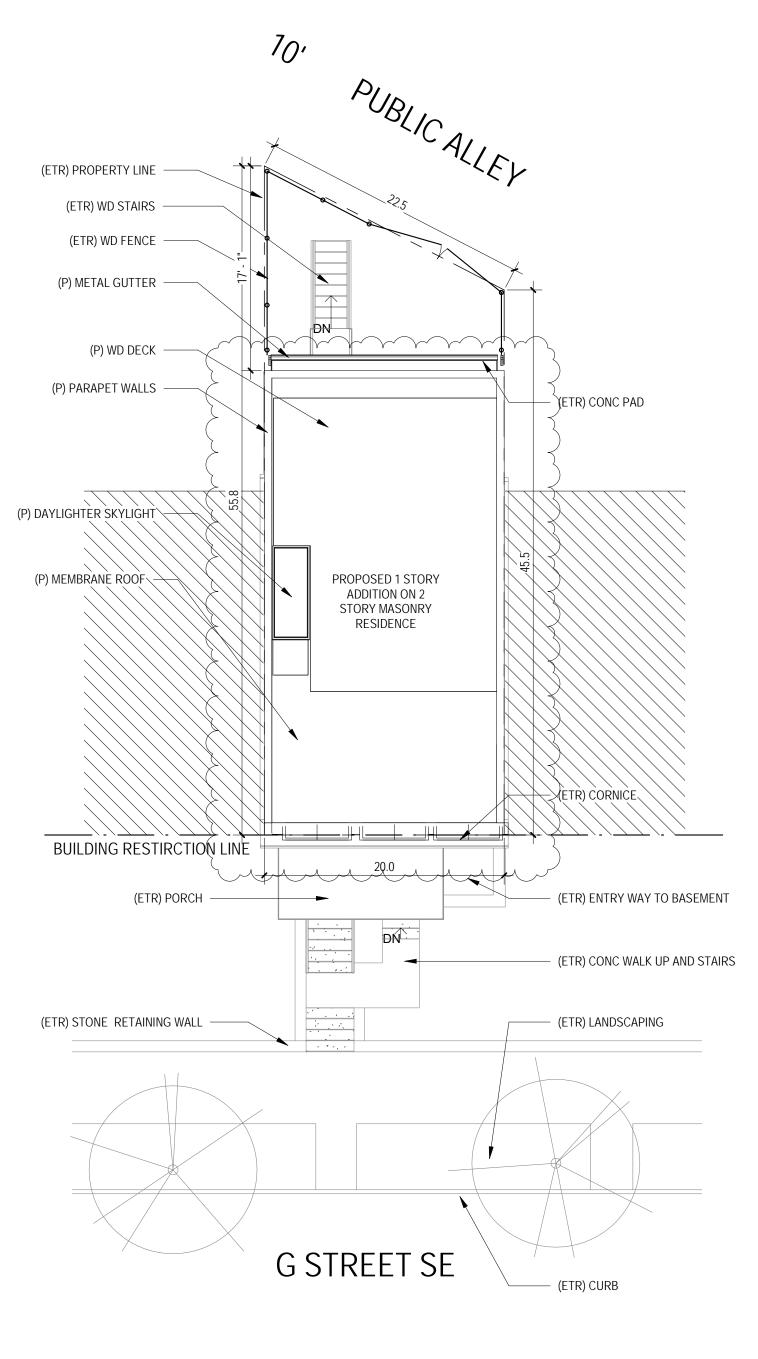


1 PROPOSED - SITE 1/8" = 1'-0"


EROSION & SEDIMENT CONTROL GENERAL NOTES

- 1. FOLLOWING INITIAL LAND DISTURBANCE OR RE-DISTURBANCE, PERMANENT OR INTERIM STABILIZATION MUST BE COMPLETED WITHIN SEVEN (7) CALENDAR DAYS FOR THE SURFACES OF ALL PERIMETER CONTROLS, DIKES, SWALES, DITCHES, PERIMETER SLOPES, AND SLOPES GREATER THAN THREE (3) HORIZONTAL TO ONE (1) VERTICAL (3:1); AND FOURTEEN (14) DAYS FOR ALL OTHER DISTURBED OR GRADED AREAS ON THE PROJECT SITE. THESE REQUIREMENTS DO NOT APPLY TO AREAS SHOWN ON THE PLAN THAT ARE USED FOR MATERIAL STORAGE OTHER THAN STOCKPILING, OR FOR THOSE AREAS ON THE PLAN WHERE ACTUAL CONSTRUCTION ACTIVITIES ARE BEING PERFORMED. MAINTENANCE SHALL BE PERFORMED AS NECESSARY SO THAT STABILIZED AREAS CONTINUOUSLY MEET THE APPROPRIATE REQUIREMENTS OF THE DISTRICT OF COLUMBIA STANDARDS AND SPECIFICATIONS FOR SOIL EROSION AND SEDIMENT CONTROL (ESC). [21 DCMR § 542.9 (0)]

 2. ESC MEASURES SHALL BE IN PLACE BEFORE AND DURING LAND DISTURBANCE. [21 DCMR § 543.6]
- 3. CONTACT DDOE INSPECTION (202) 535-2977 TO SCHEDULE A PRECONSTRUCTION MEETING AT LEAST THREE (3) USINESS DAYS BEFORE THE COMMENCEMENT OF A LAND-DISTURBING ACTIVITY.[21 DCMR § 503.7A)]
- 4. A COPY OF THE APPROVED PLAN SET WILL BE MAINTAINED AT THE CONSTRUCTION SITE FROM THE DATE THAT ONSTRUCTION ACTIVITIES BEGIN TO THE DATE OF FINAL STABILIZATION AND WILL BE AVAILABLE FOR DODE INSPECTORS [21 DCMR § 542 15]
- STABILIZATION AND WILL BE AVAILABLE FOR DDOE NSPECTORS.[21 DCMR § 542.15]

 5. ESC MEASURES SHALL BE IN PLACE TO STABILIZE AN EXPOSED AREA AS SOON AS PRACTICABLE AFTER CONSTRUCTION ACTIVITY HAS TEMPORARILY OR PERMANENTLY CEASED BUT NO LATER THAN FOURTEEN (14) DAYS FOLLOWING CESSATION, EXCEPT THAT TEMPORARY OR PERMANENT STABILIZATION SHALL BE IN PLACE AT THE END OF EACH DAY OF UNDERGROUND UTILITY WORK THAT IS NOT CONTAINED WITHIN A LARGER DEVELOPMENT SITE. [21 DCMR § 543.7]
- 6. STOCKPILED MATERIAL BEING ACTIVELY USED DURING A PHASE OF CONSTRUCTION SHALL BE PROTECTED AGAINST EROSION BY ESTABLISHING AND MAINTAINING PERIMETER CONTROLS AROUND THE STOCKPILE. [21 DCMR § 543.16 (A)]
- 7. STOCKPILED MATERIAL NOT BEING ACTIVELY USED OR ADDED TO SHALL BE STABILIZED WITH MULCH, TEMPORARY VEGETATION, HYDRO-SEED OR PLASTIC WITHIN FIFTEEN (15) CALENDAR DAYS AFTER ITS LAST USE OR ADDITION. [21 DCMR § 543.16(B)]
- 8. PROTECT BEST MANAGEMENT PRACTICES FROM SEDIMENTATION AND OTHER DAMAGE DURING CONSTRUCTION FOR PROPER POST CONSTRUCTION OPERATION. [21 DCMR § 543.5]
- REQUEST A DDOE INSPECTOR'S APPROVAL AFTER THE INSTALLATION OF PERIMETER EROSION AND SEDIMENT CONTROLS, BUT BEFORE PROCEEDING WITH ANY OTHER EARTH DISTURBANCE OR GRADING. [21 DCMR §542.12 (A)]
- 10. REQUEST A DDOE INSPECTOR'S APPROVAL AFTER FINAL STABILIZATION OF THE SITE AND BEFORE THE REMOVAL OF EROSION AND SEDIMENT CONTROLS. [21 DCMR § 542.12 (B)]
- 11. FINAL STABILIZATION MEANS THAT ALL LAND-DISTURBING ACTIVITIES AT THE SITE HAVE BEEN COMPLETED AND EITHER OF THE FOLLOWING TWO CRITERIA HAVE BEEN MET: (1) A UNIFORM (FOR EXAMPLE, EVENLY DISTRIBUTED, WITHOUT LARGE BARE AREAS) PERENNIAL VEGETATIVE COVER WITH A DENSITY OF SEVENTY PERCENT (70%) OF THE NATIVE BACKGROUND VEGETATIVE COVER FOR THE AREA HAS BEEN ESTABLISHED ON ALL UNPAVED AREAS AND AREAS NOT COVERED BY PERMANENT STRUCTURES, OR (2) EQUIVALENT PERMANENT STABILIZATION MEASURES HAVE BEEN EMPLOYED (SUCH AS THE USE OF RIPRAP, GABIONS, OR GEOTEXTILES). [21 DCMR § 542.12 (B.1, B.2)]
- 12. FOLLOW THE REQUIREMENTS OF THE UNITED STATES ENVIRONMENTAL PROTECTION AGENCY APPROVED STORMWATER POLLUTION PREVENTION PLAN (SWPPP) AND MAINTAIN A LEGIBLE COPY OF THIS SWPPP ON SITE. [21 DCMR § 543.10 (B)]
- POST A SIGN THAT NOTIFIES THE PUBLIC TO CONTACT DDOE IN THE EVENT OF EROSION OR OTHER POLLUTION. THE SIGN WILL BE PLACED AT EACH ENTRANCE TO THE SITE OR AS DIRECTED BY THE DDOE INSPECTOR. EACH SIGN WILL BE NO LESS THAN 18X24 INCHES IN SIZE AND MADE OF MATERIALS THAT WILL WITHSTAND WEATHER FOR THE DURATION OF THE PROJECT. LETTERING WILL BE AT LEAST 1 INCH IN HEIGHT AND EASILY READABLE BY THE PUBLIC FROM A DISTANCE OF TWELVE FEET (12 FT). THE SIGN MUST DIRECT THE PUBLIC, IN SUBSTANTIALLY THE FOLLOWING FORM: "TO REPORT EROSION, RUNOFF, OR STORMWATER POLLUTION" AND WILL PROVIDE THE CONSTRUCTION SITE ADDRESS, DDOE'S TELEPHONE NUMBER (202-535-2977), DDOE'S E-MAIL ADDRESS (IEB.SCHEDULING@DC.GOV), AND THE 311 MOBILE APP HEADING ("CONSTRUCTIONEROSIONRUNOFF").[21 DCMR § 543.22]

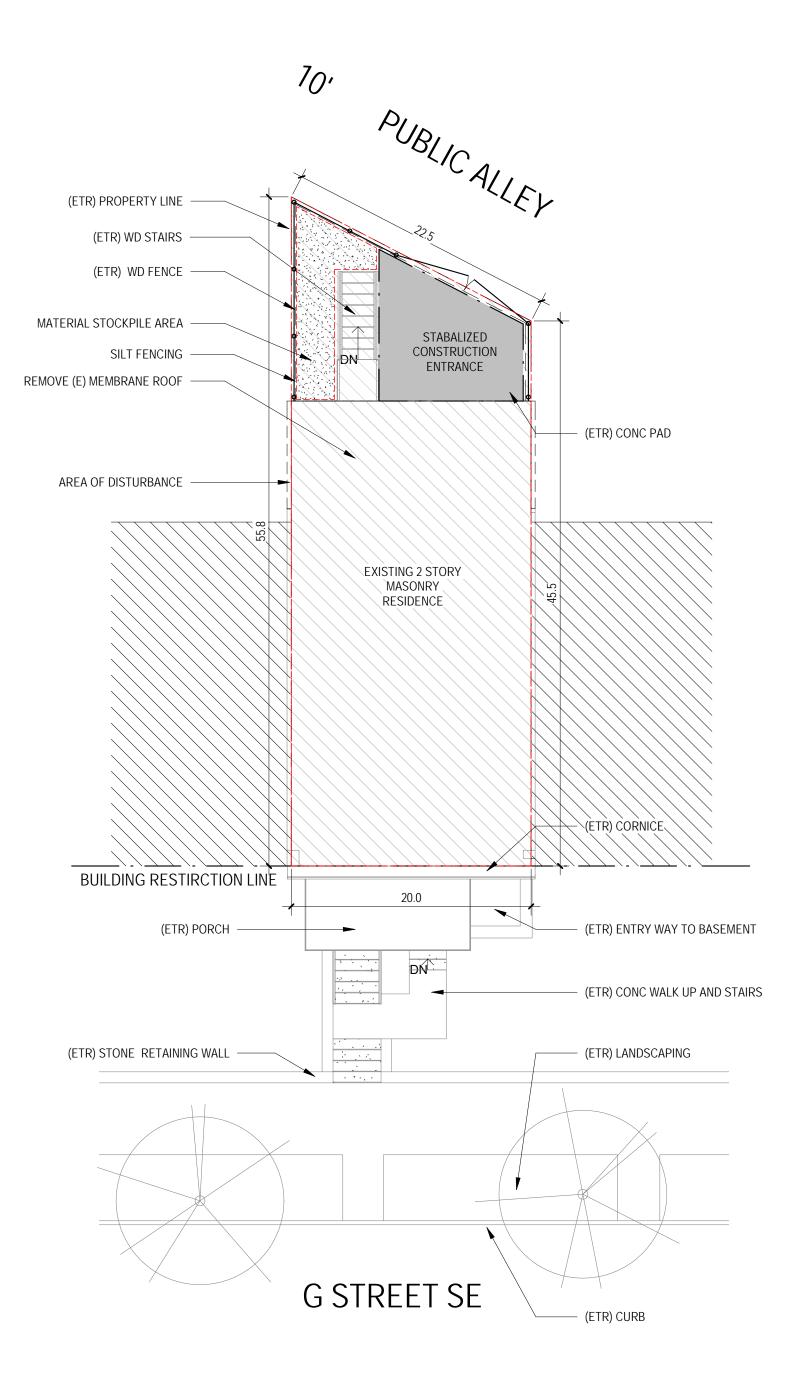

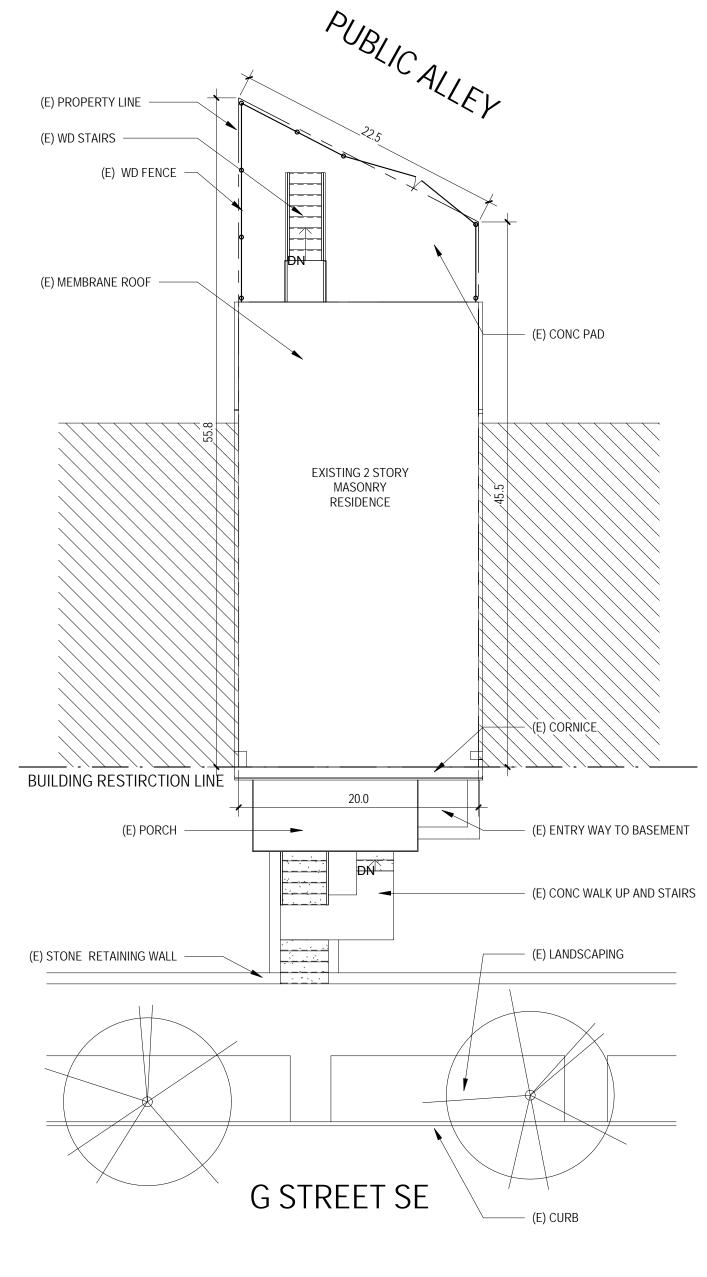

2 EROSION & SEDIMENT CONTROL PLAN 1/8" = 1'-0"


3 EXISTING - SITE

SEQUENCE OF CONSTRUCTION & GENERAL NOTES

SEDIMENT TRAPS OR BASINS AND OTHER EROSION AND SEDIMENT CONTROL SHALL BE INSTALLED NO LATER THAN THE FIRST PHASE OF LAND GRADING. SEDIMENT TRAPS OR BASINS AND OTHER ESCS SHALL BE, INSTALLED AS SOON AS NEW SITE-RELATED RUNOFF IS DETECTED AND EMPLOYED AT ALL TIMES TO PROTECT INLETS OR STORM SEWERS BELOW SILT-PRODUCING AREAS. NO LATER THAN THE FIRST DAY OF CONSTRUCTION INSTALL SITE ACCESS MEASURES TO MINIMIZE OFF-SITE VEHICLE TRACKING OF SEDIMENTS. EACH CONSTRUCTION ENTRANCE MUST BE STABILIZED AND INCLUDE EACH ADDITIONAL MEASURE REQUIRED TO KEEP SEDIMENT FROM BEING CARRIED, ONTO PUBLIC STREETS BY CONSTRUCTION VEHICLES, AND WASHED INTO A STORM DRAIN OR WATER WAYS. REMOVE OFF-SITE ACCUMULATION OF SEDIMENT DAILY DURING CONSTRUCTION AND IMMEDIATELY AT THE REQUEST OF A DOEE INSPECTOR. PERFORM ROUTINE MAINTENANCE TO PREVENT ANY NEW DESTABILIZED AREAS. FILTER WATER PUMPED FROM EXCAVATIONS PRIOR TO DISCHARGING TO THE STORM SEWER SYSTEM. USE MULCH AND MATTING ON EXCAVATED MATERIALS. EROSION SHALL BE CONTROLLED BY THE INSTALLATION OF GUTTERS AND DOWNSPOUTS AS SOON AS PRACTICABLE. MEASURES SHALL BE TAKEN TO ACHIEVE A NON-ERODING VELOCITY FOR STORMWATER EXITING FROM A ROOF OR DOWNSPOUT OR TO TEMPORARILY PIPE THAT STORMWATER DIRECTLY TO A STORM DRAIN. THE SITE WORK SHALL MAXIMIZE THE PRESERVATION OF NATURAL VEGETATION AND LIMIT THE REMOVAL OF VEGETATION TO WHAT IS NECESSARY FOR CONSTRUCTION OR LANDSCAPING ACTIVITY.

INDENTIFY THE LIMIT OF DISTURBANCE THROUGHOUT THE SITE.
 LOCATE AND INSTALL INLET PROTECTION AT ALL APPLICABLE DOWNSTREAM INLETS.
 INSTALL A STABILIZED CONSTRUCTION ENTRANCE AS NOTED AND ON PLANS.
 INSTALL SILT FENCE AS NOTED ON PLANS.

5. IDENTIFY MATERIAL STOCKPILE AREA AS NOTED ON PLANS.6. EXCAVATE AS REQUIRED.7. FOLLOW DEWATERING AND DUST CONTROL MEASURES AS REQUIRED.

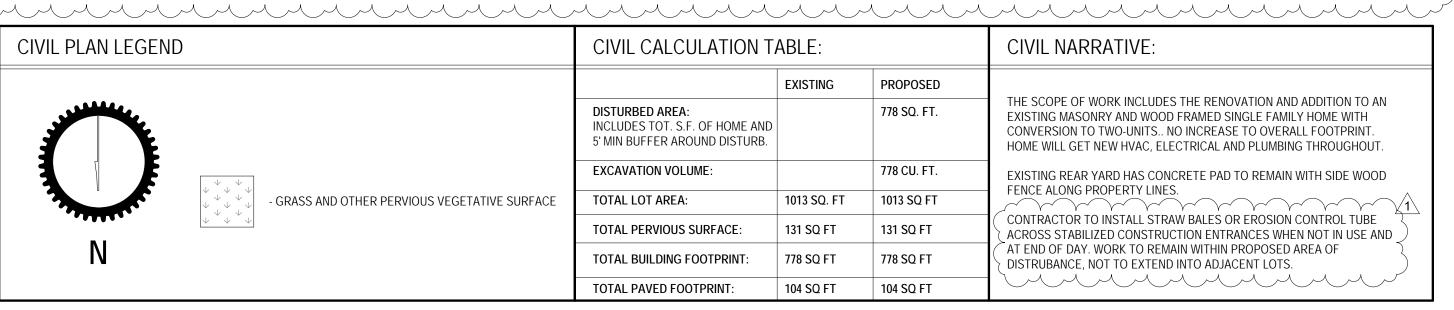

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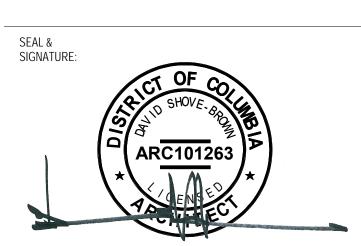
NO. ISSUE DATE

03/22/2018

8/29/2018

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1 PERMIT COMMENT RESPOSNE




SHEET TITLE: EROSION & SEDIMENT CONTROL PLAN

PROJECT NO: 2017.157

F 04/08/16

SCALE: 1/8" = 1'-0"

C0003

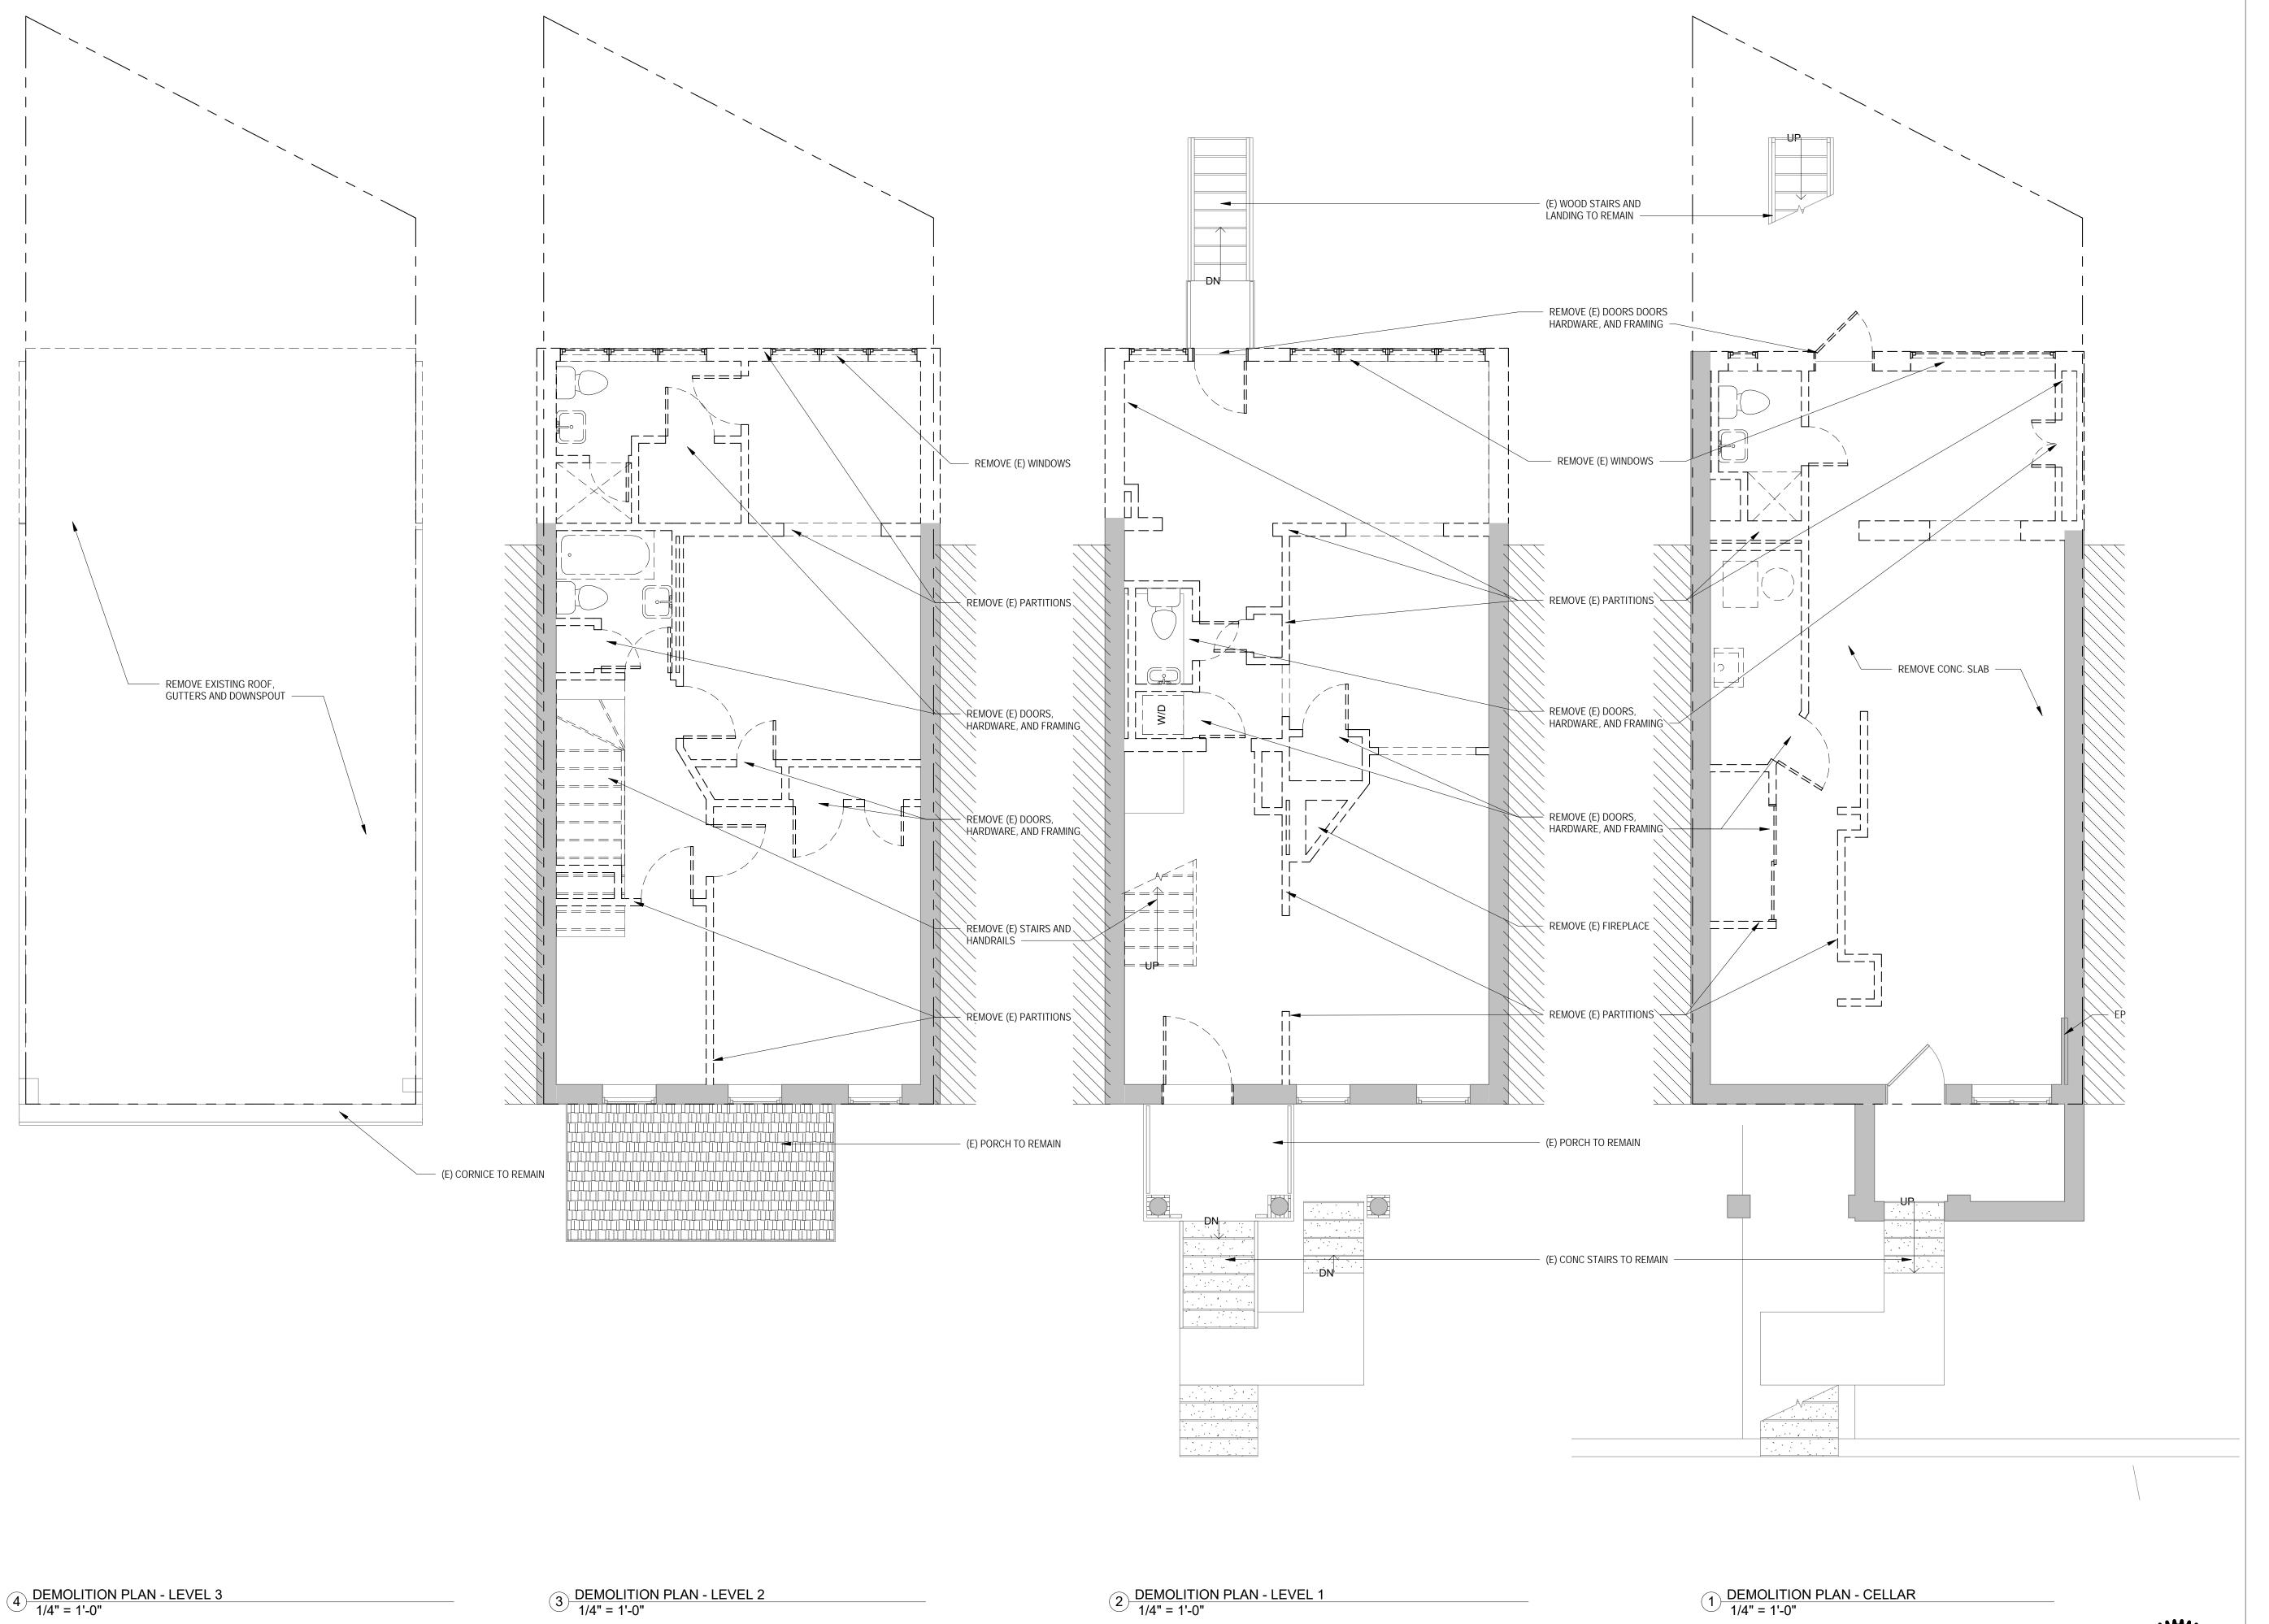

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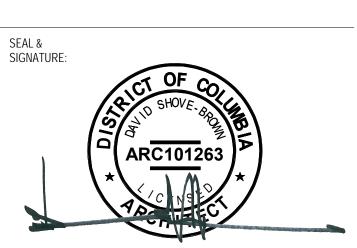
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PROJECT: RESIDENCE1347
ADDRESS: 1347 G ST SE

 NO.
 ISSUE
 DATE

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 FOR PERMIT
 03/22/2018





SHEET TITLE: ARCHITECTURAL DEMOLITION FLOOR
PLANS
PROJECT NO: 2017.157

DATE 04/14/16

SCALE: 1/4" = 1'-0"

AD0011

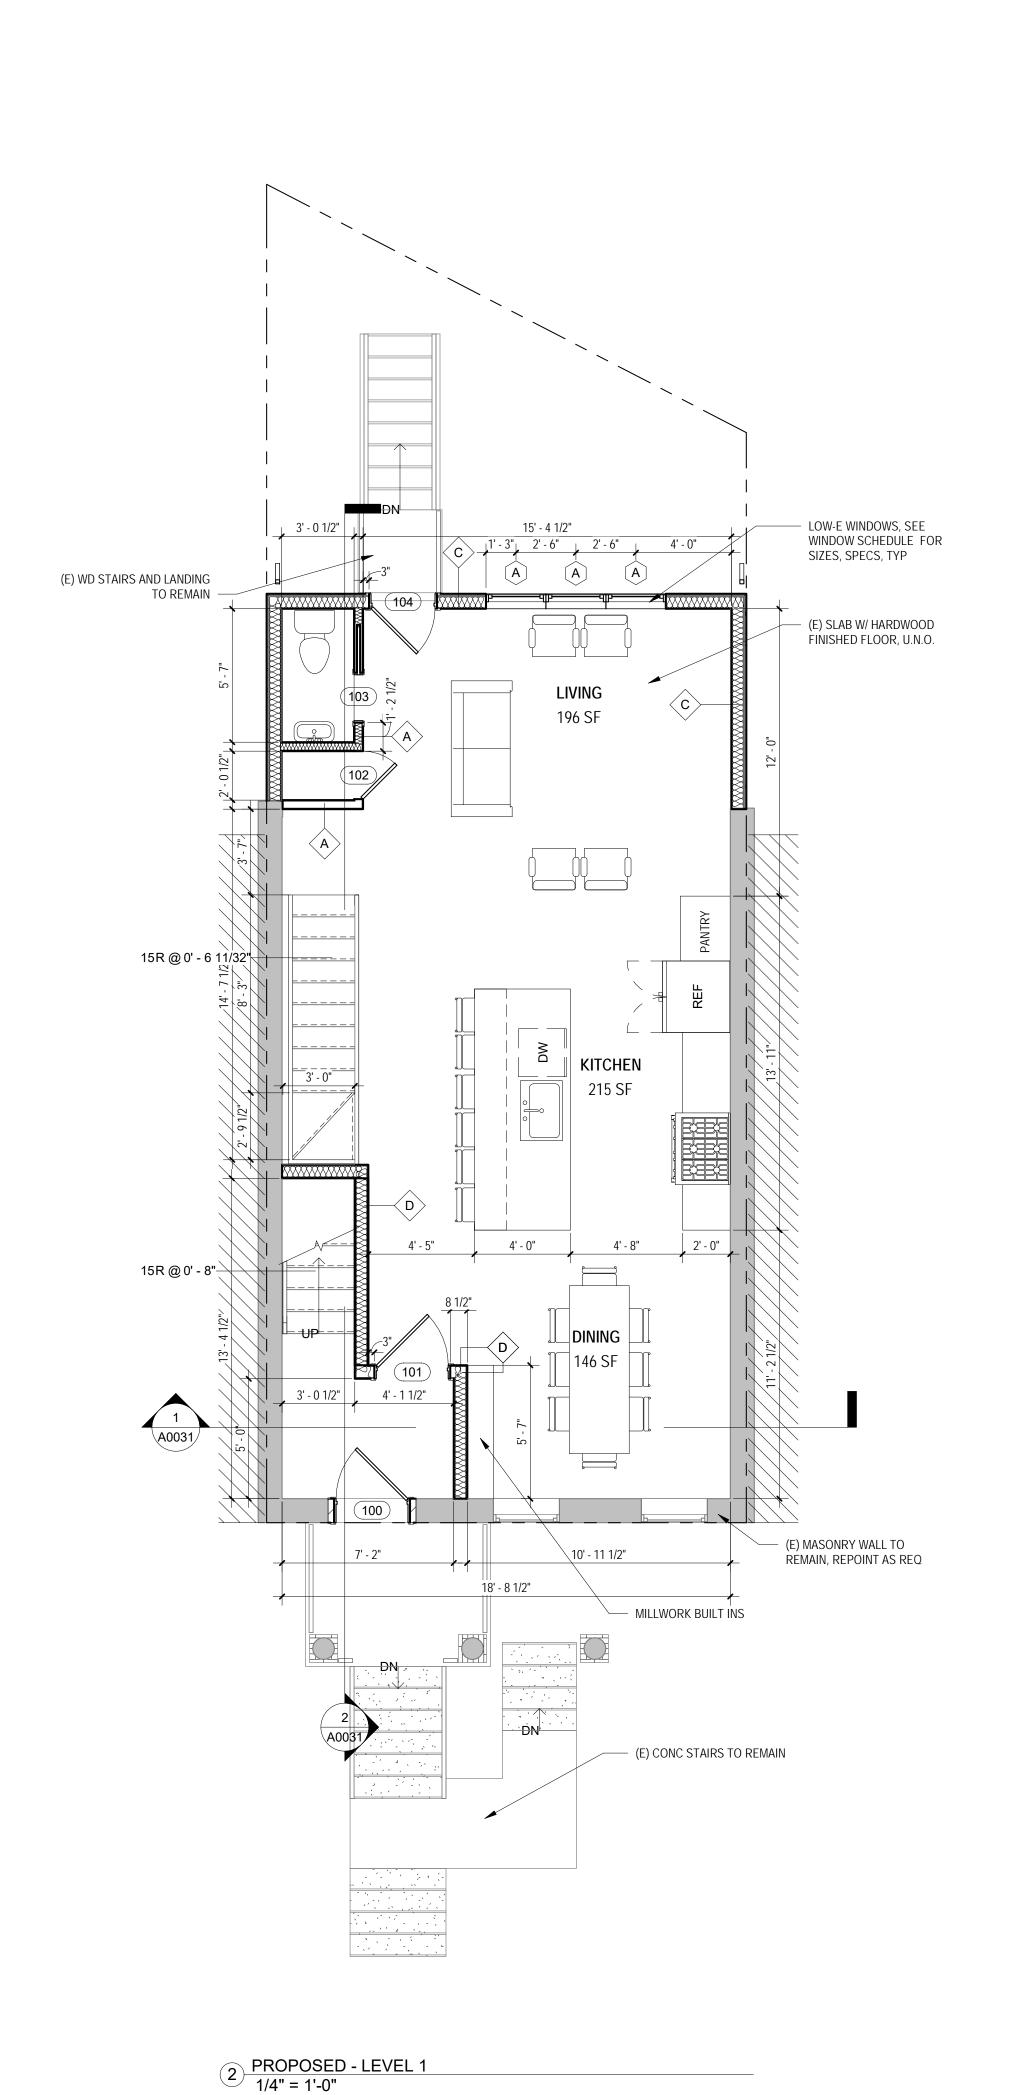

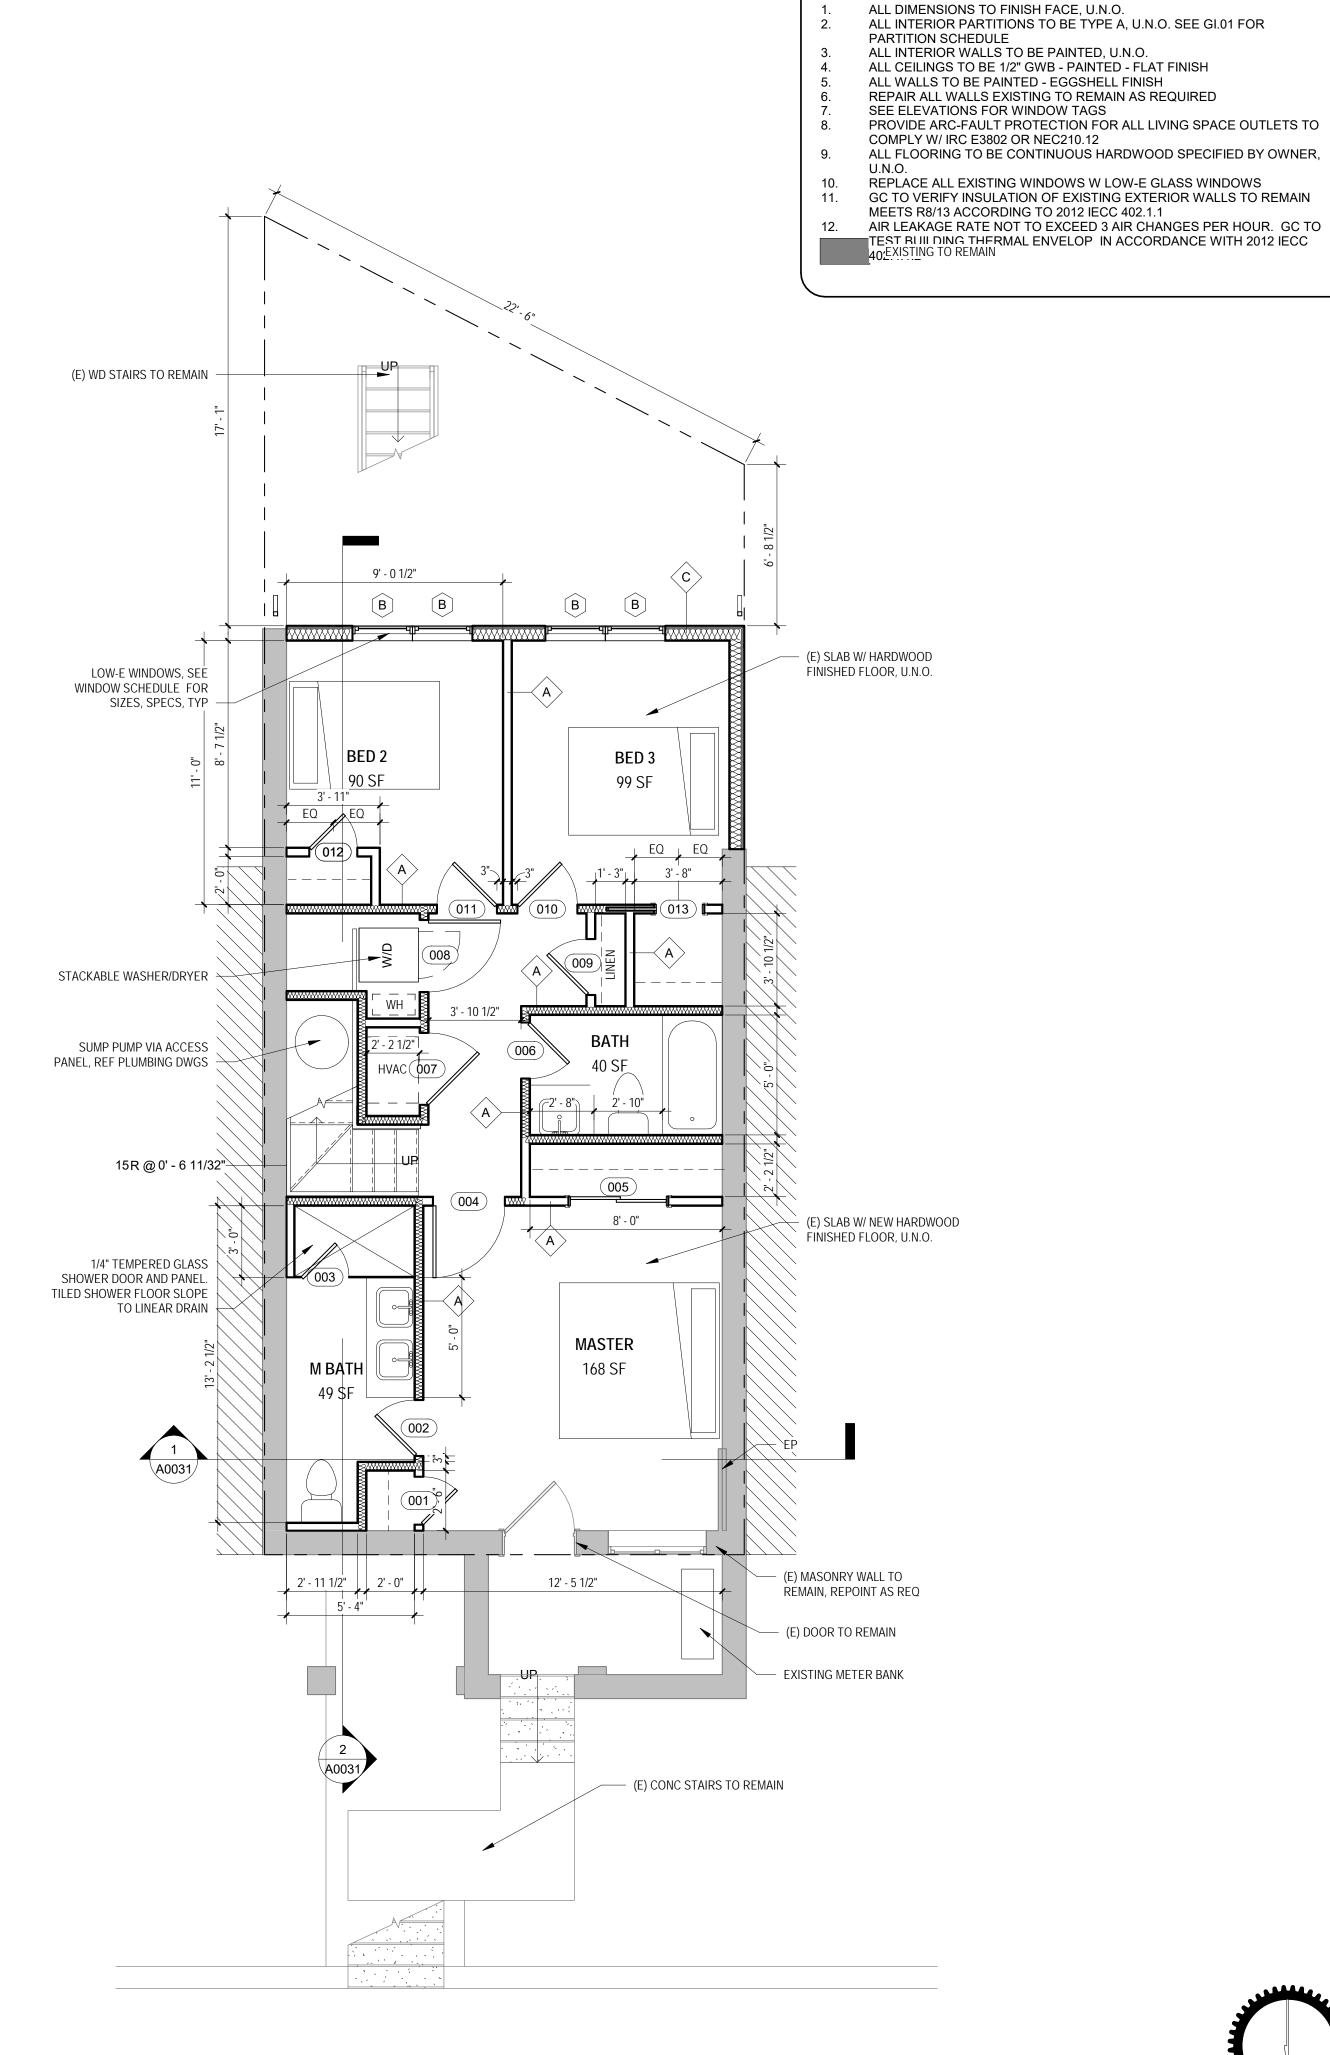

CONSTRUCTION GENERAL NOTES



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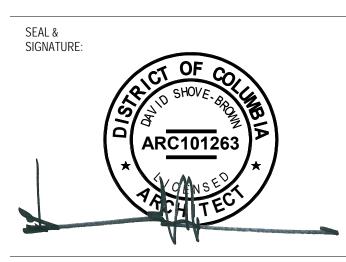
PROJECT: RESIDENCE 1347

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 1
 PERMIT COMMENT RESPOSNE
 8/29/2018




SHEET TITLE: ARCHITECTURAL FLOOR PLANS


PROJECT NO: 2017.157

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SCALE: As indicated


A0011



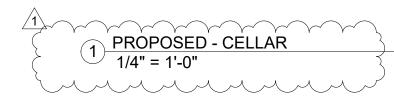

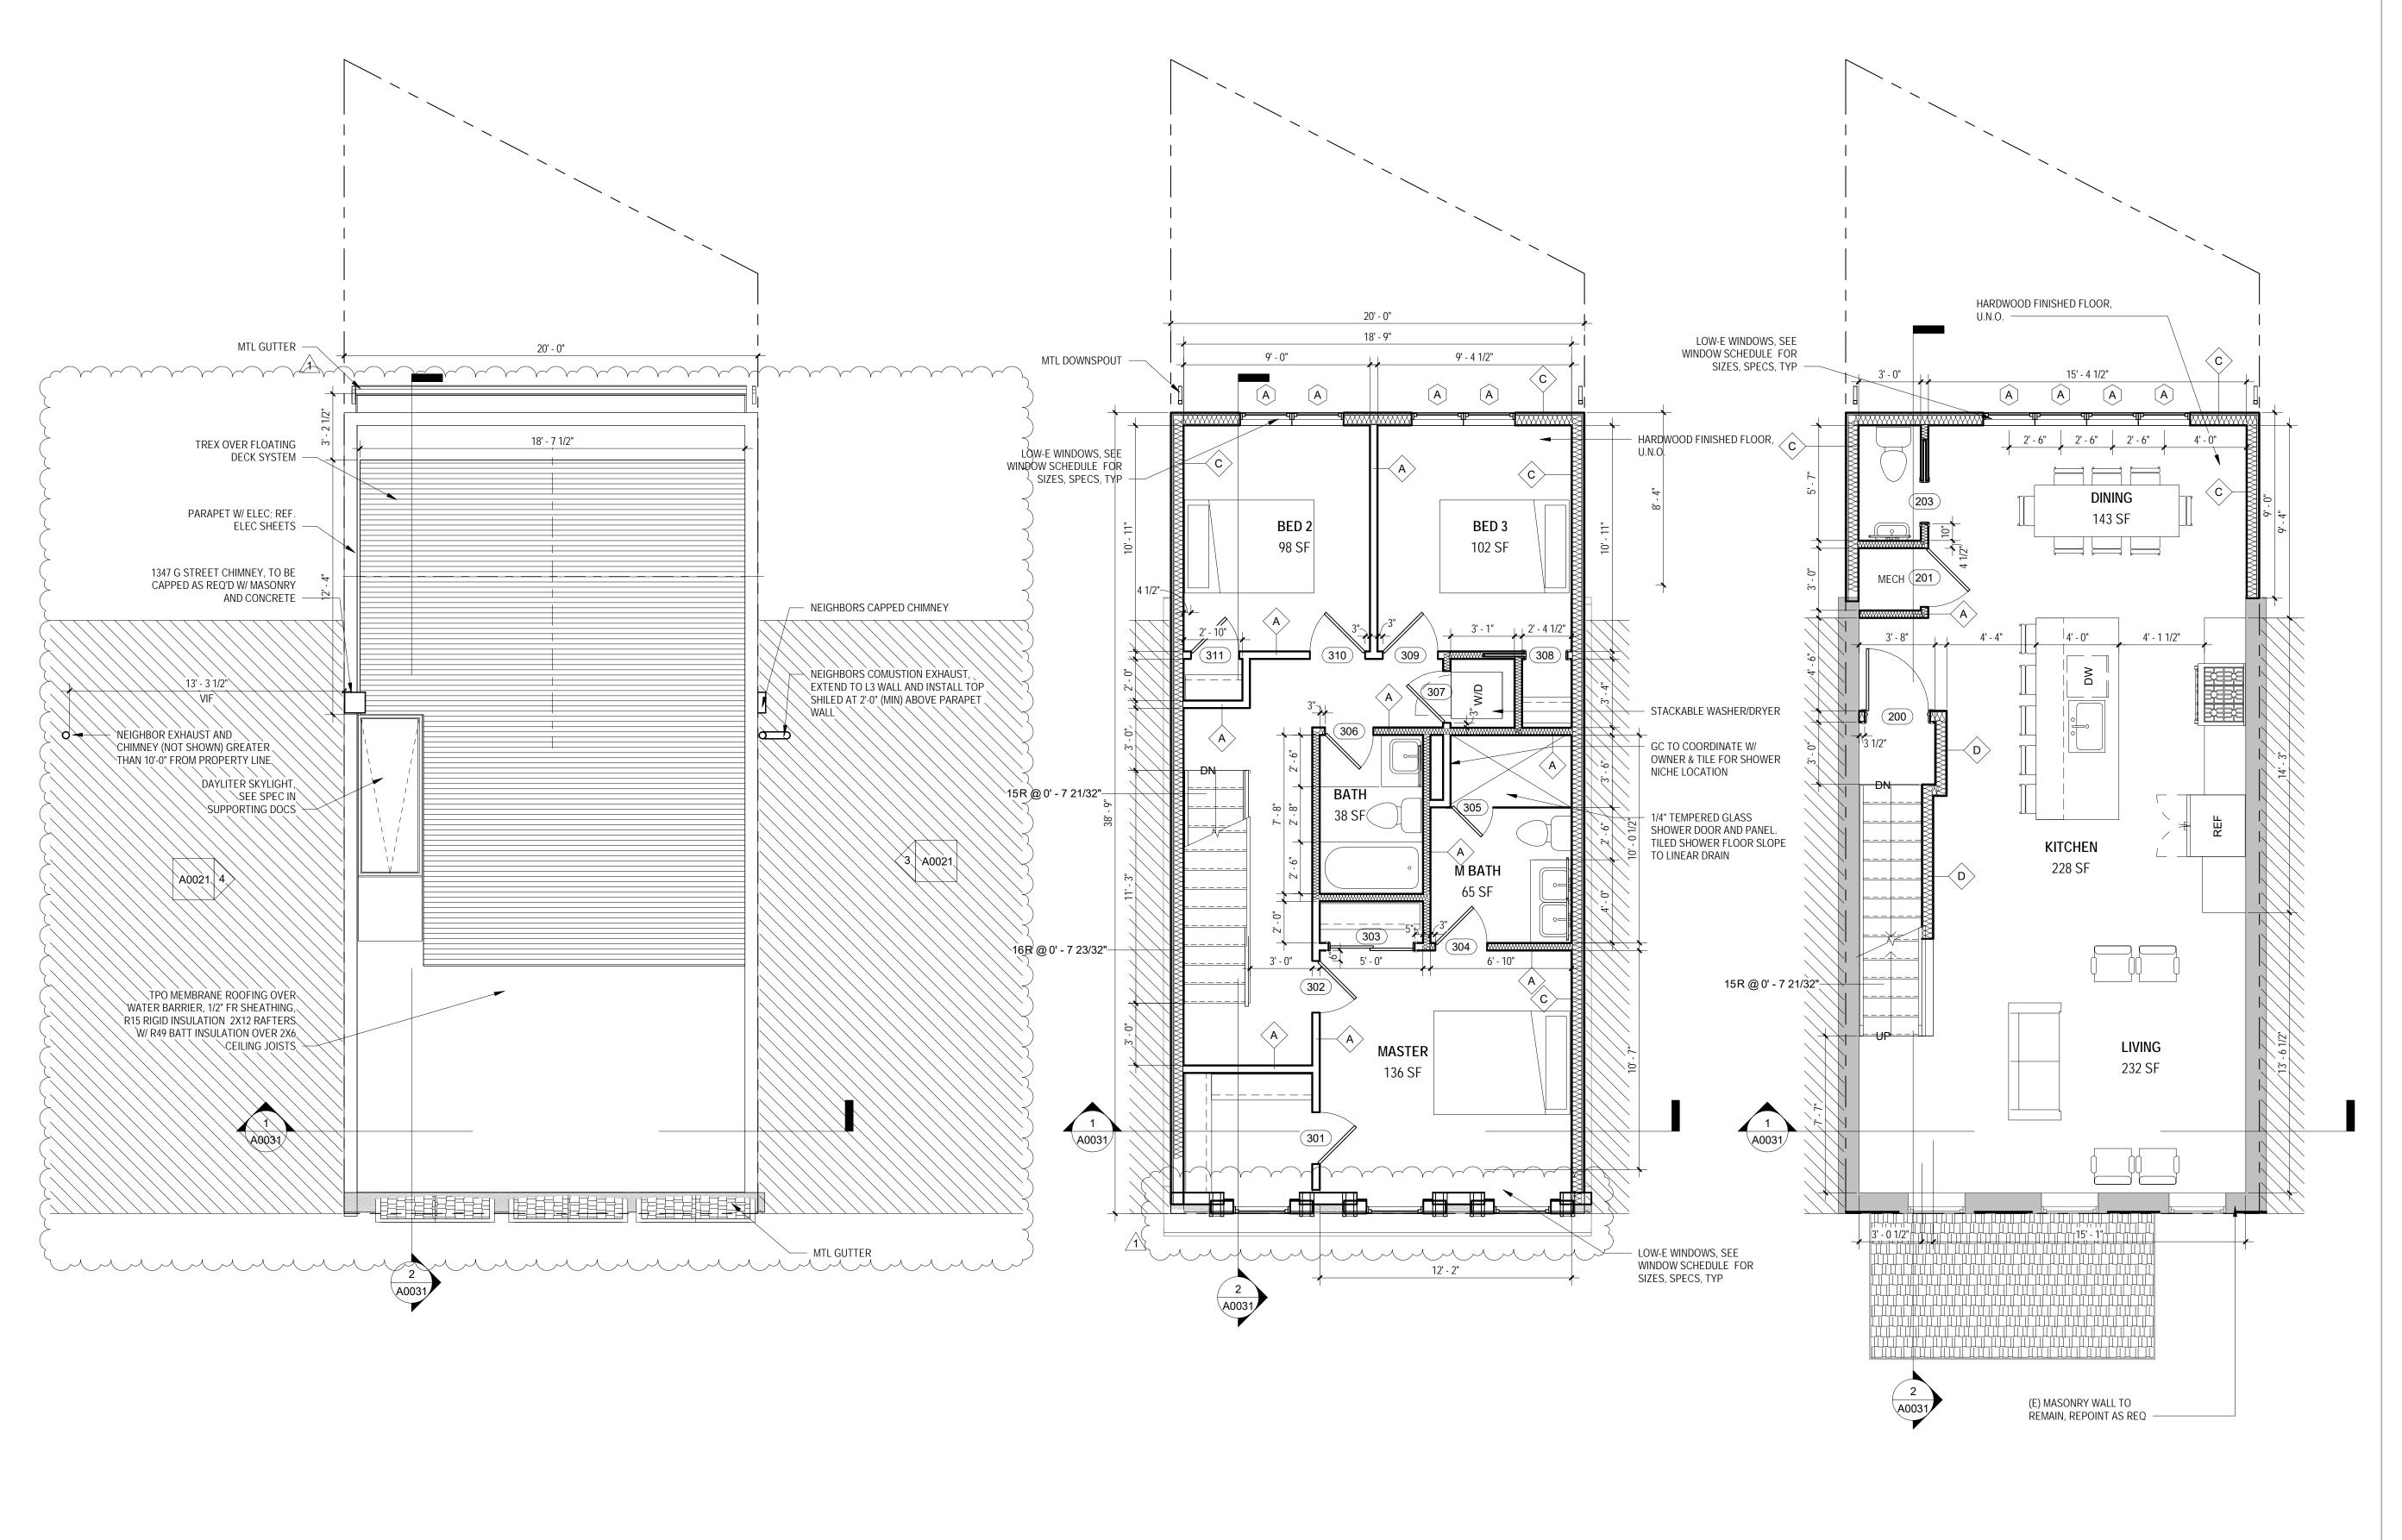2 PROPOSED - LEVEL 3 1/4" = 1'-0"

3 PROPOSED - ROOF 1/4" = 1'-0" 1 PROPOSED - LEVEL 2 1/4" = 1'-0"

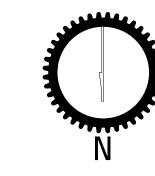

//38/7

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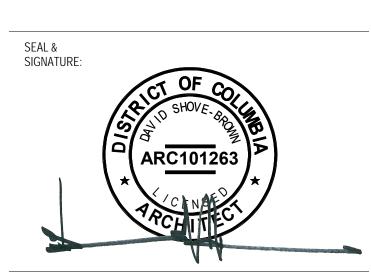
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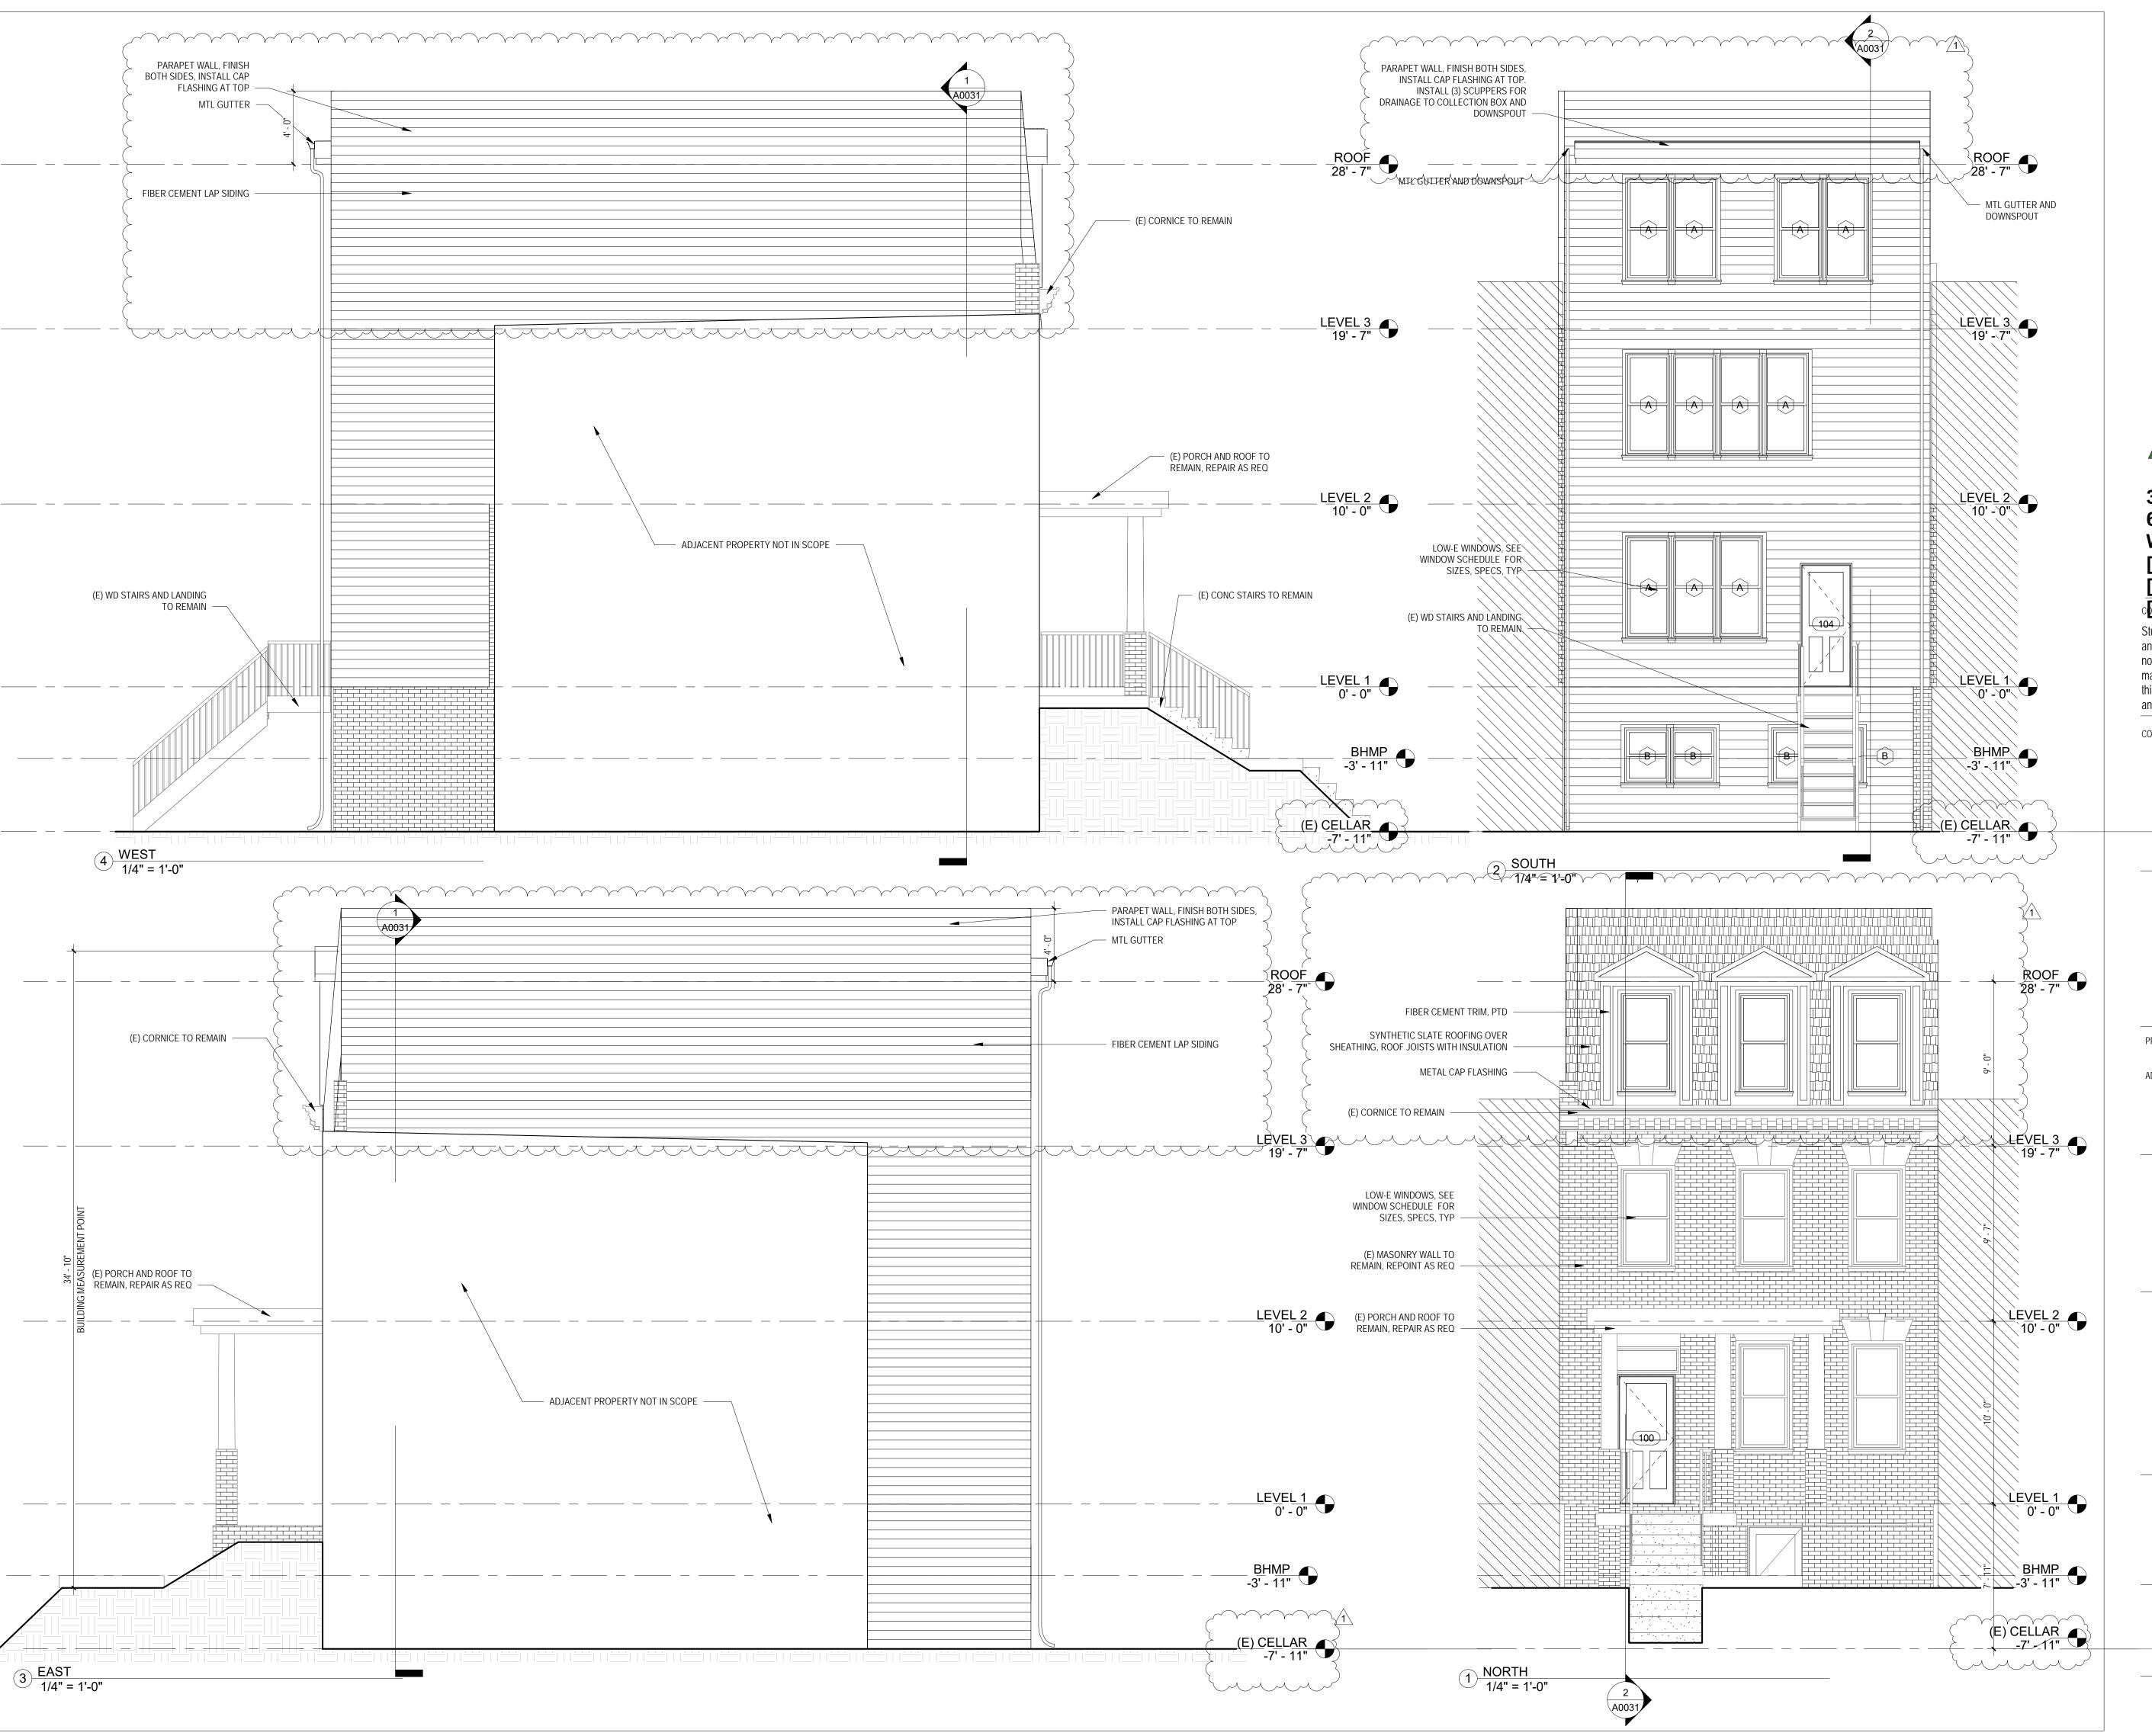
SHEET TITLE: ARCHITECTURAL FLOOR PLANS

PROJECT NO: 2017.157

DATE 12/27/17

SCALE: 1/4" = 1'-0"

A0012



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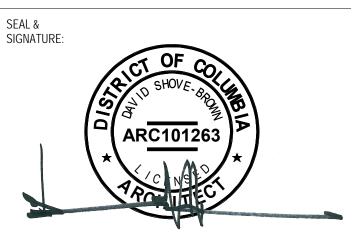
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SHEET TITLE: EXTERIOR ELEVATIONS

PROJECT NO: 2017.157

04/14/16


SCALE: 1/4" = 1'-0"

A0021

2012 IECC TABLE 402.4.1.1

AIR BARRIER AND INSULATION INSTALLATION

COMPONENT	CRITERIA
AIR BARRIER AND THERMAL BARRIER	A continuous air barrier shall be installed in the building envelope. Exterior thermal envelope contains a continuous air barrier. Breaks or joints in the air barrier shall be sealed. Air-permeable insulation shall not be used as a sealing material.
CEILING/ATTIC CEILING/ATTIC	The air barrier in any dropped ceiling/soffit shall be aligned with the insulation and any gaps in the air barrier sealed. Access openings, drop down stair or knee wall doors to unconditioned attic spaces shall be sealed.
WALLS	Corners and headers shall be insulated and the junction of the foundation and sill plate shall be sealed. The junction of the top plate and top of exterior walls shall be sealed. Exterior thermal envelope insulation for framed walls shall be installed in substantial contact and continuous alignment with the air barrier. Knee walls shall be sealed.
WINDOWS/SKYLIGHTS/DOORS	The space between window/door jambs and framing and skylights and framing shall be
RIM JOISTS	—sealed. — Rim joists shall be in sulated and include the air barrier.
FLOORS (INCLUDING ABOVE-GRADE AND CANTILEVERED FLOORS)	Insulation shall be installed to maintain permanent contact with underside of subfloor decking. The air barrier shall be installed at any exposed edge of insulation.
CRAWL SPACE WALLS	Where provided in lieu of floor insulation, insulation shall be permanently attached to the crawlspace walls.
SHAFTS, PENETRATIONS	 Exposed earth in unvented crawl spaces shall be covered with Class I vapor retarder with overlap joints — Duct shafts, utility penetrations, and flue shafts opening to exterior or unconditioned space shall be sealed.
NARROW CAVITIES	Batts in narrow cavities shall be cut to fit, or narrow cavities shall be filled by insulation that on installation readily conforms to the available cavity space.
GARAGE SEPARATION	Air sealing shall be provided between the garage and conditioned spaces.
RECESSED LIGHTING	Recessed light fixtures installed in the building thermal envelope shall be air tight, IC rated, and sealed to the drywall.
PLUMBING AND WIRING	Batt insulation shall be cut neatly to fit around wiring and plumbing in exterior walls, or insulation that on installation readily conforms to available space shall extend behind piping and wiring.
SHOWER/TUB ON EXTERIOR WALL	Exterior walls adjacent to showers and tubs shall be insulated and the air barrier installed separating them from the showers and tubs
ELECTRICAL/PHONE BOX ON EXTERIOR WALLS	The air barrier shall be installed behind electrical or communication boxes or air sealed boxes shall be install
HVAC REGISTER BOOTS	An air barrier shall be installed on fireplace walls. Fireplaces shall have gasketed doors.
FIREPLACE	HVAC register boots that penetrate building thermal envelope shall be sealed to the sub-floor or drywall.

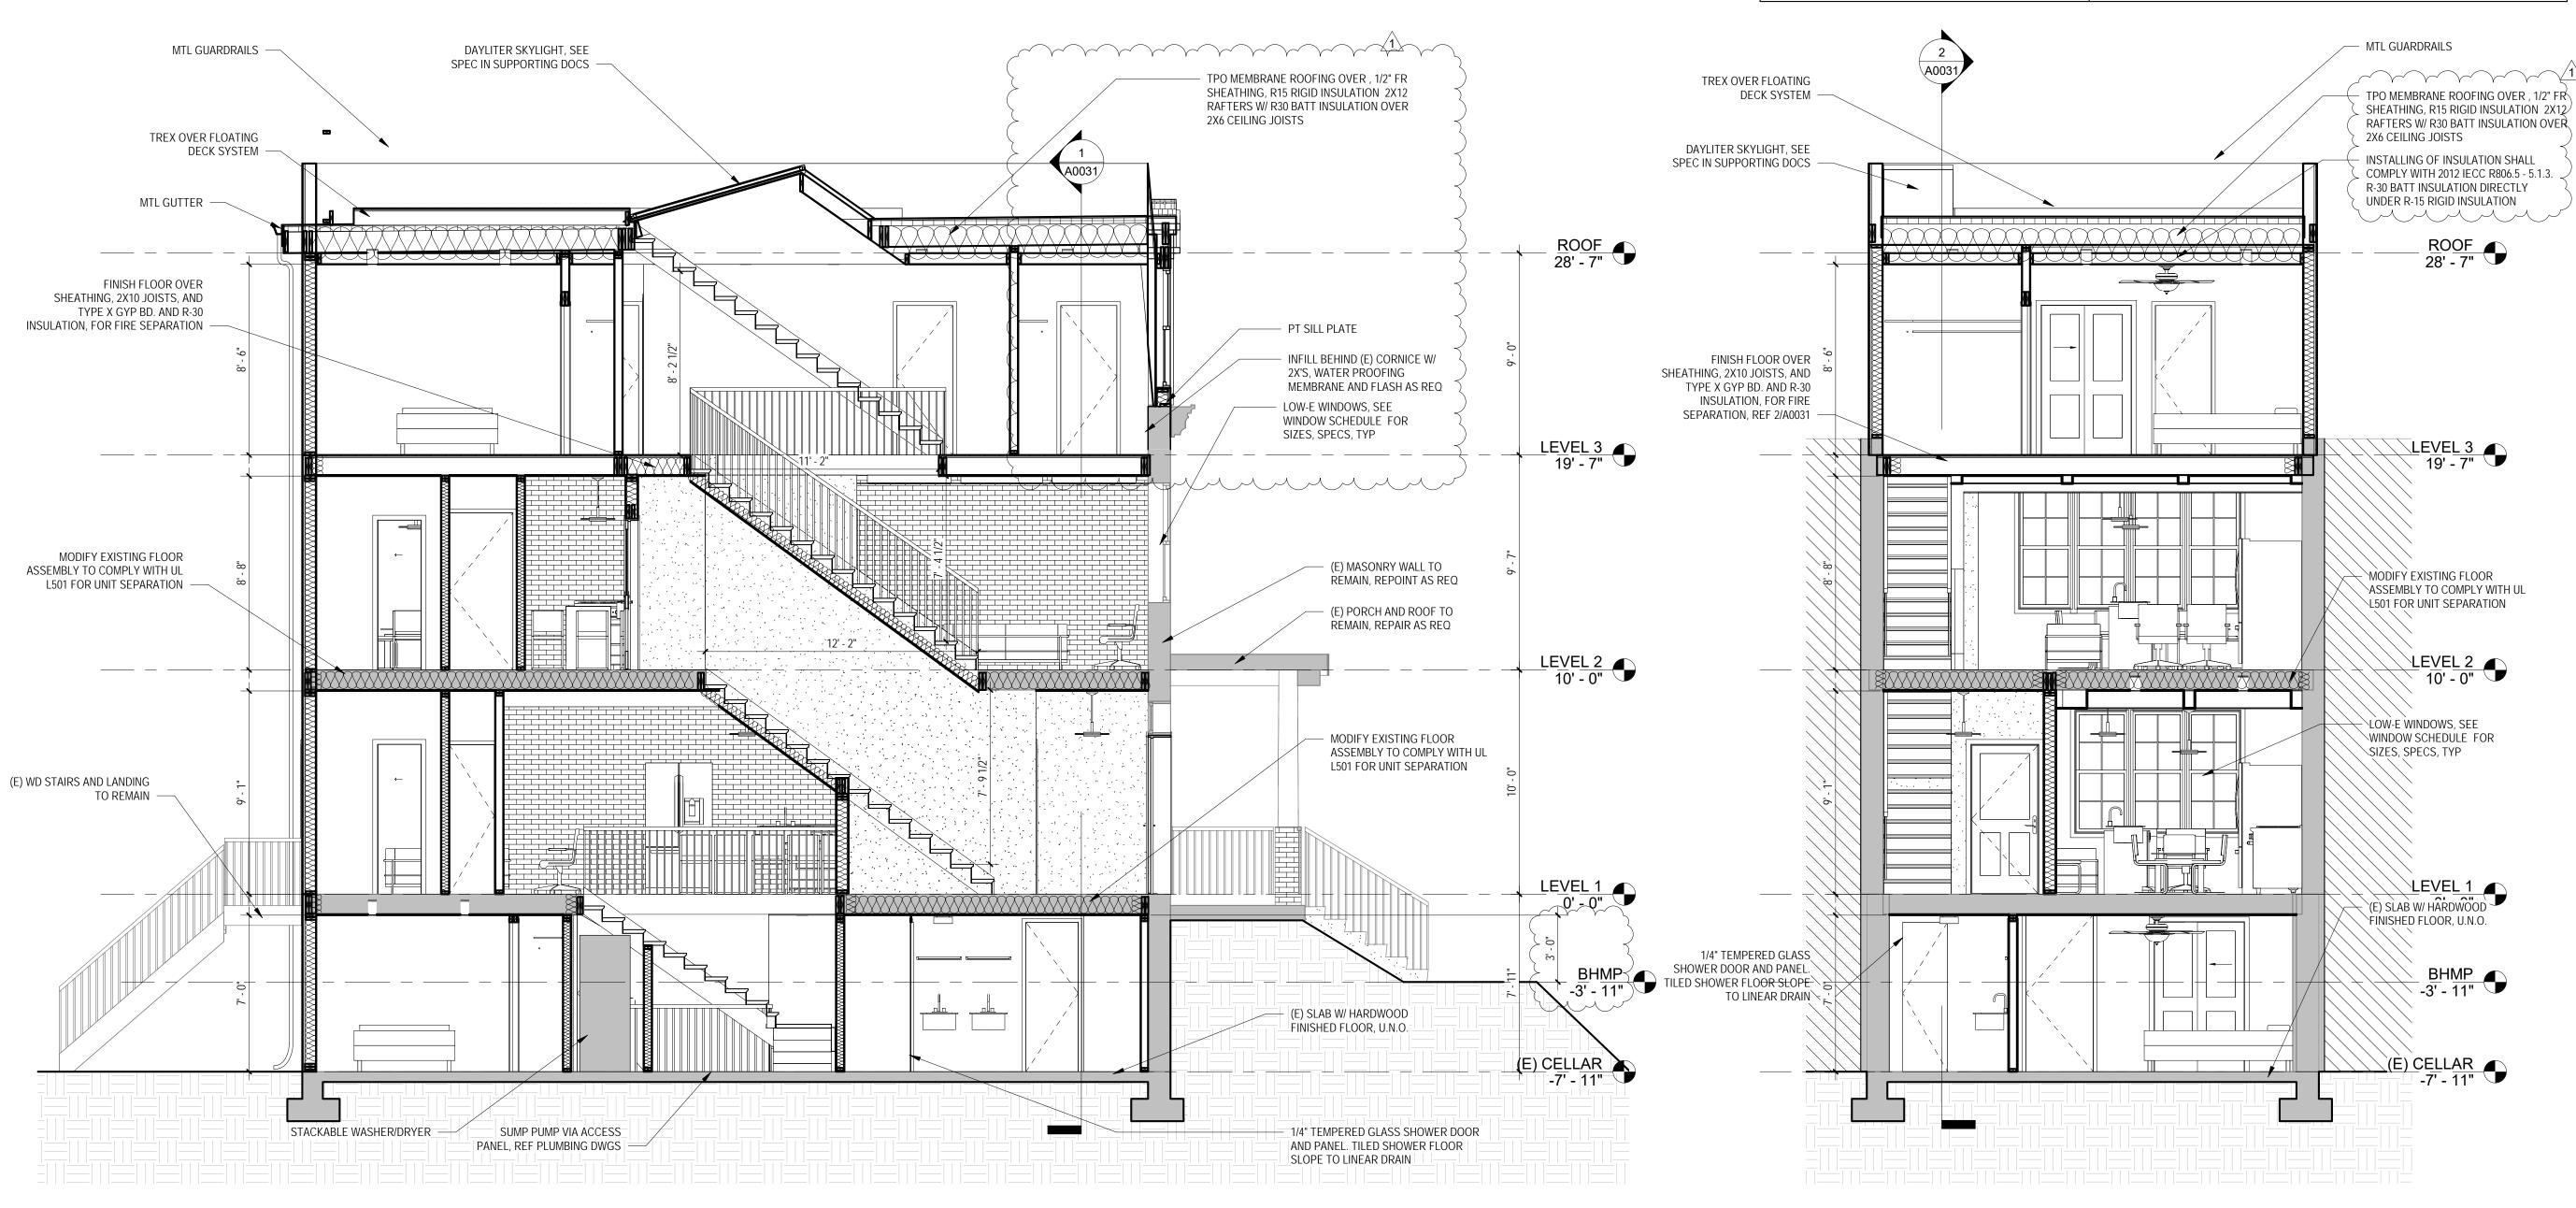

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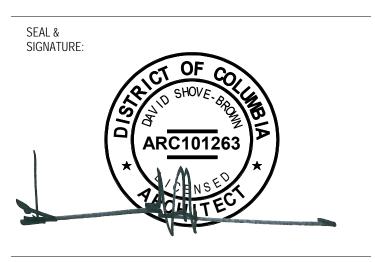
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SHEET TITLE: BUILDING AND WALL SECTIONS

PROJECT NO: 2017.157

DATE 04/14/16

SCALE: As indicated

A0031

1 SECTION - CROSS 1/4" = 1'-0"

2 SECTION - LONGITUDINAL 1/4" = 1'-0"