

Owner: WESTBROOK PARTNERS

NO. DATE

Construction Manager:

DAVIS CONSTRUCTION

Civil / Site: BOHLER DC

Landscape:
WOLF | JOSEY LANDSCAPE ARCHITECTS

Structural: SK&A DC

Mechanical & Plumbing: INTERFACE ENGINEERING

Electrical: INTERFACE ENGINEERING

PROJECT TITLE:

MERIDIAN INTERNATIONAL CENTER

PROJECT No: 65930

DRAWING TITLE:

G1 - PARKING 2

SCALE: 1/16" = 1'-0"


**A-102** 

SCHEMATIC DESIGN

N3/13/18

Board of Zoning Adjustment
District of Columbia
CASE NO.19689
EXHIBIT NO.69A

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SEAL

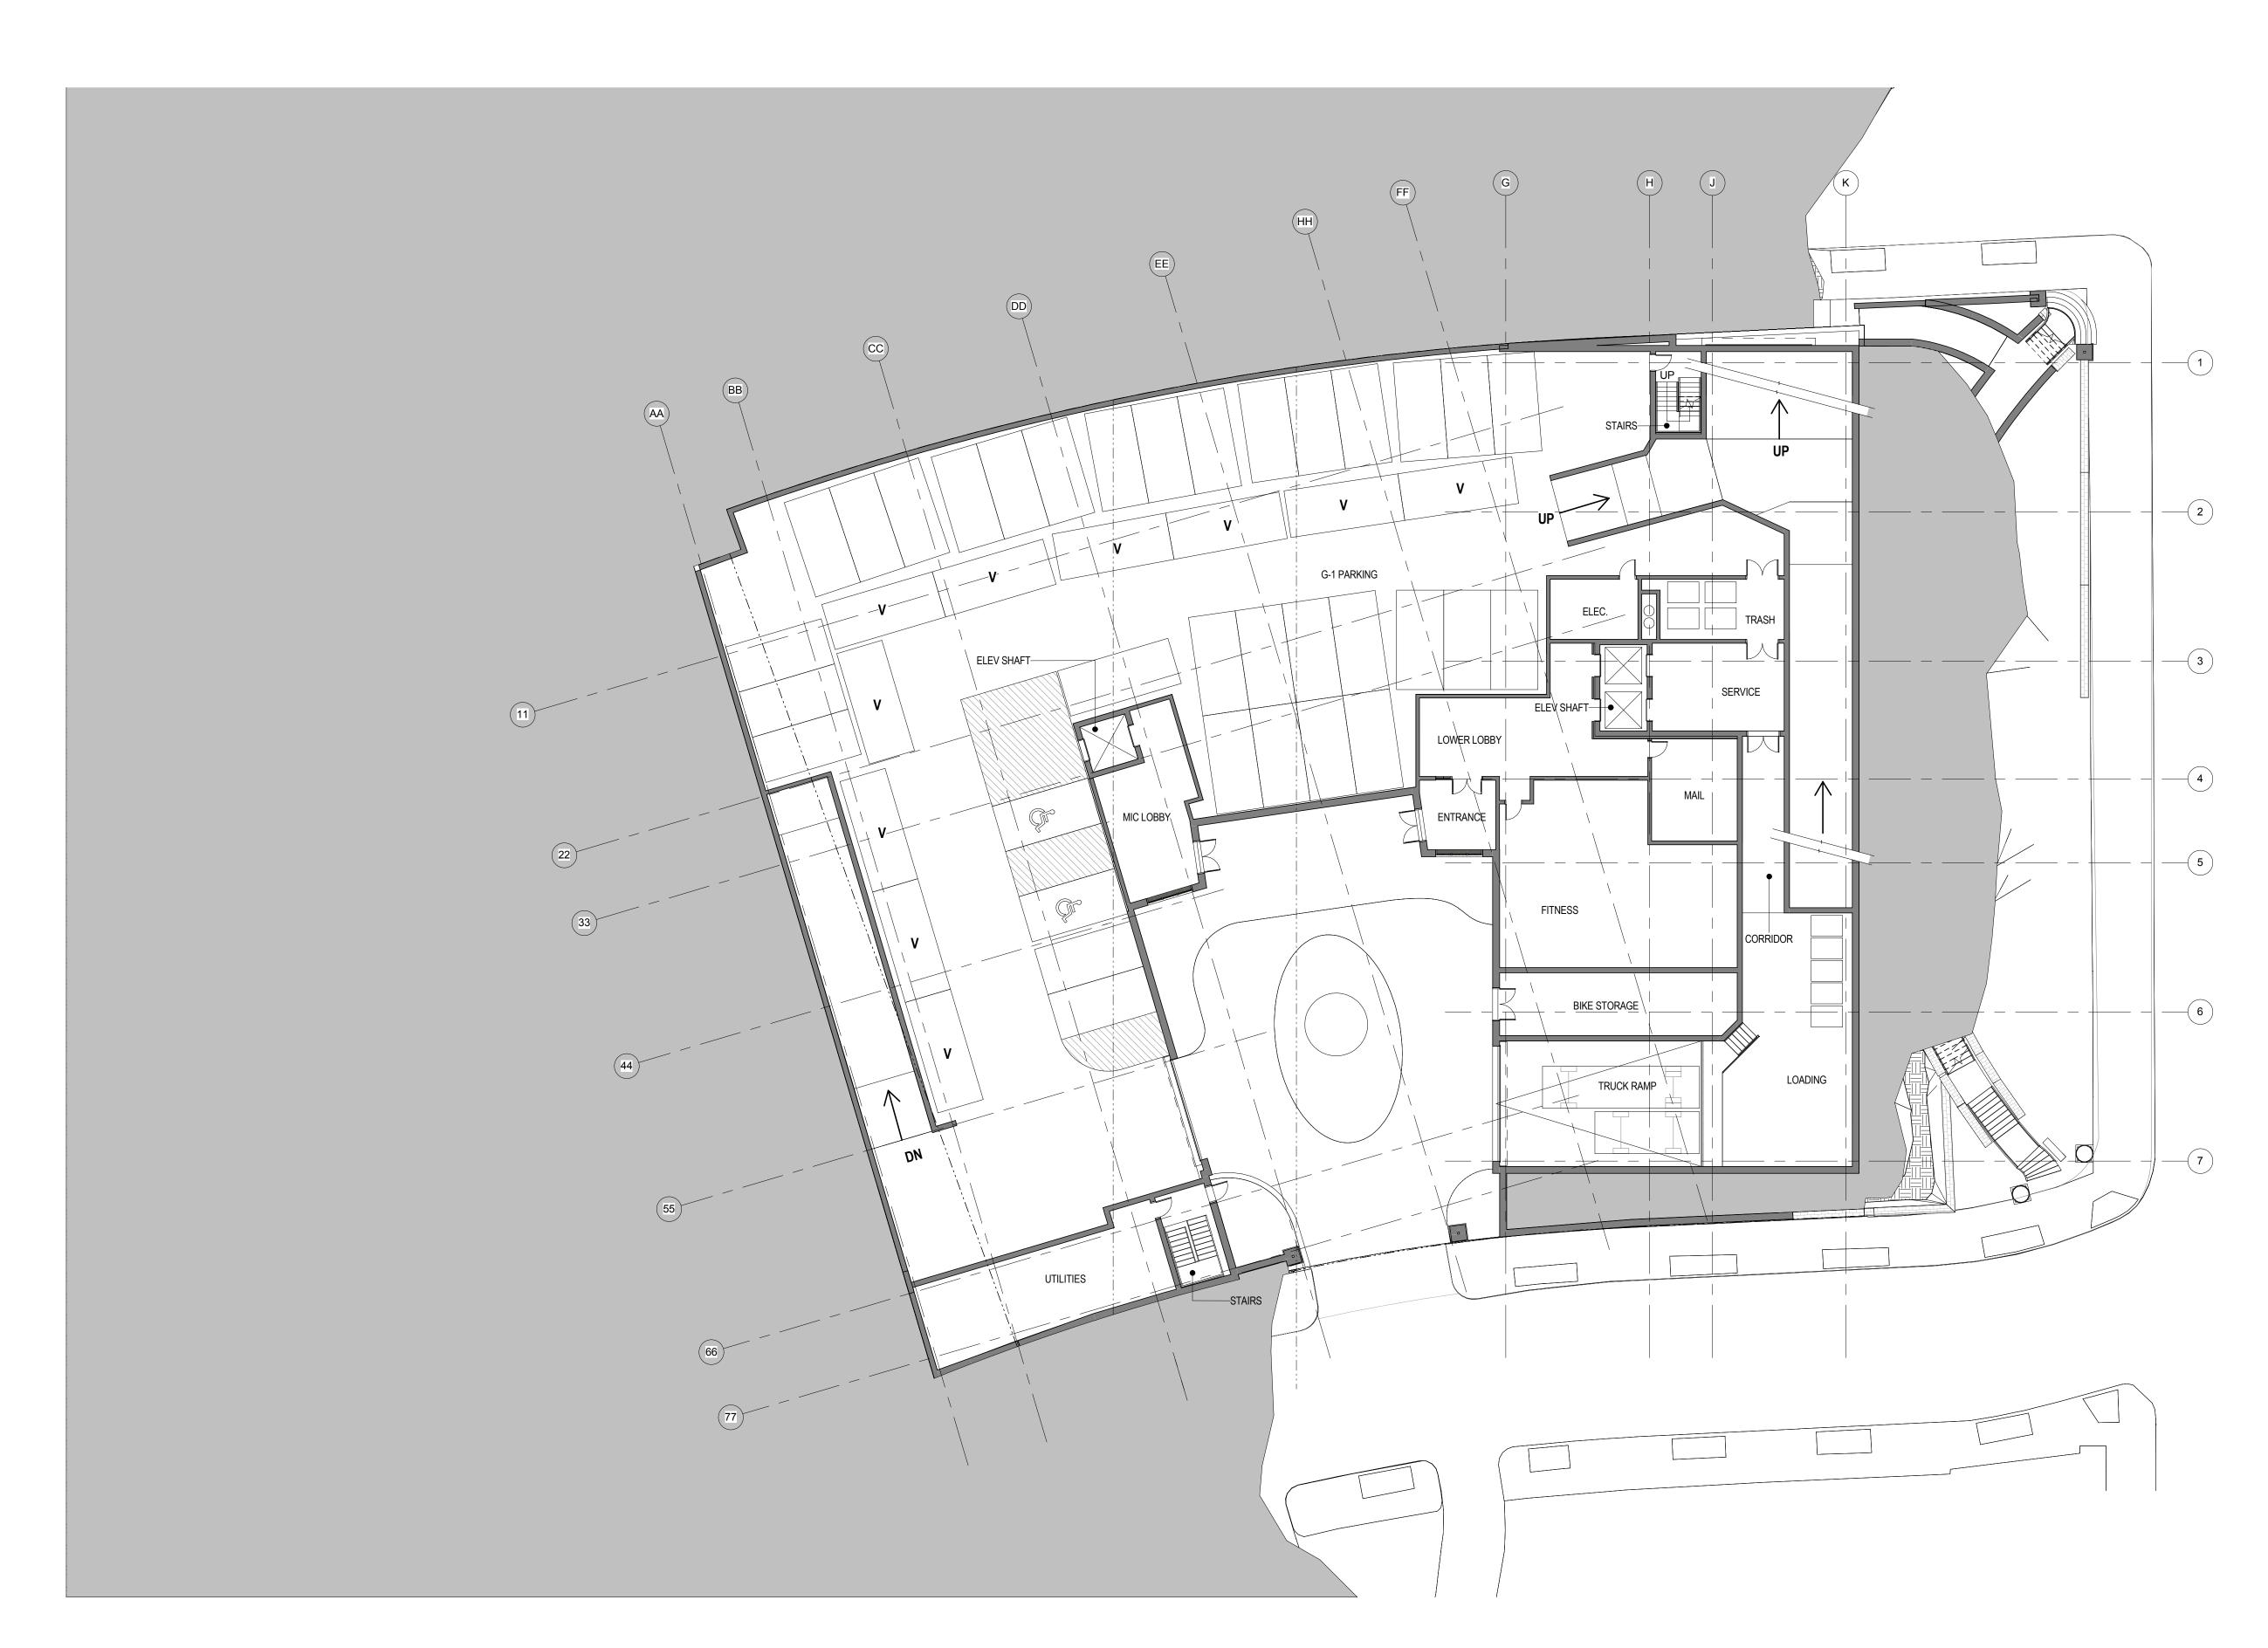

ONE THOMAS CIRCLE, NW SUITE 270 WASHINGTON, DC 20005 T. 202.495.7430

Owner: WESTBROOK PARTNERS

NO. DATE

Construction Manager:

DAVIS CONSTRUCTION

Civil / Site: BOHLER DC

Landscape:
WOLF | JOSEY LANDSCAPE ARCHITECTS

Structural: SK&A DC

Mechanical & Plumbing: INTERFACE ENGINEERING

Electrical:
INTERFACE ENGINEERING

PROJECT TITLE:

MERIDIAN INTERNATIONAL CENTER

PROJECT No: 65930

DRAWING TITLE:

G0 - PARKING 1


SCALE: 1/16" = 1'-0"

**A-103** 

SCHEMATIC DESIGN

03/13/1

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A REFER TO A-400 SERIES DRAWINGS FOR UNIT PLANS.

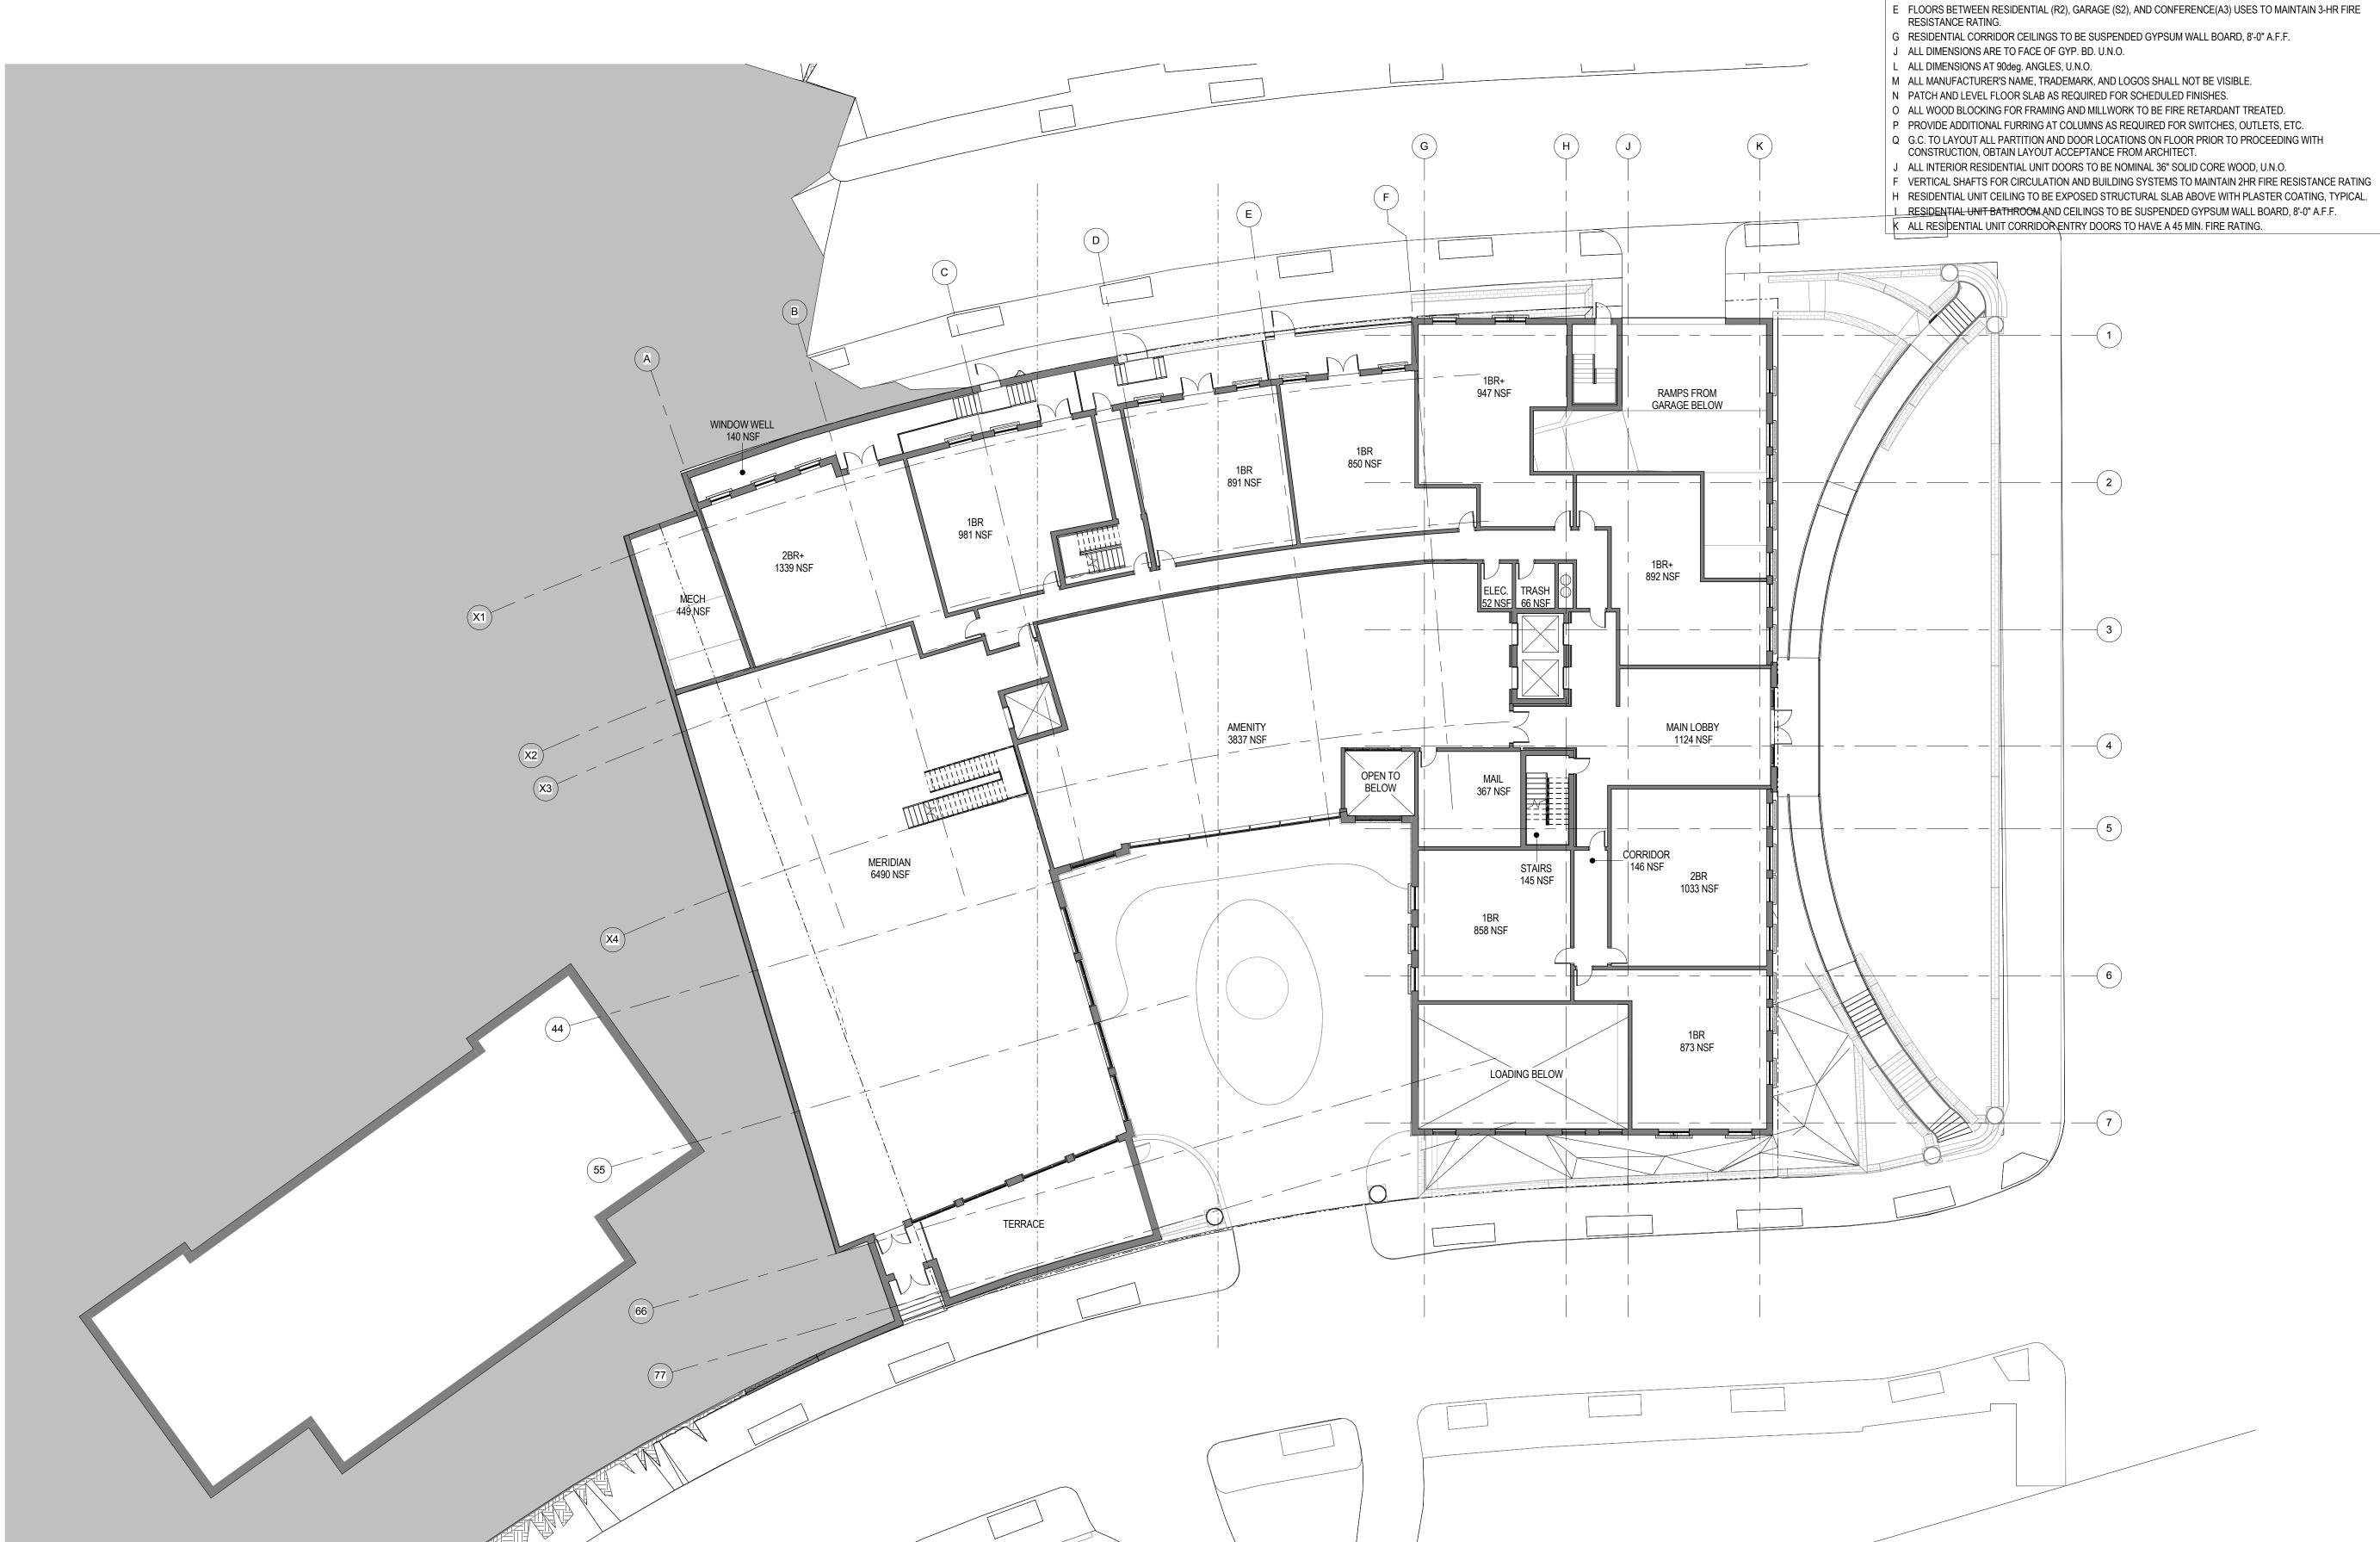B RESIDENTIAL UNIT DEMISING WALLS: 1HR RATED (UL U493); MIN. STC-55; 6-IN (TWO 2-1/2") METAL STUD FRAMING; (2) LAYERS 5/8" TYPE-X GWB EACH SIDE; ACOUSTIC INSULATION

C RESIDENTIAL UNIT CORRIDOR WALLS: 1HR FIRE RATED (UL U419); MIN. STC-55; 6-IN METAL STUD; (2) LAYERS 5/8" TYPE-X GWB EACH SIDE; ACOUSTIC INSULATION

D FLOORS BETWEEN RESIDENTIAL LEVELS TO MAINTAIN 2-HR FIRE RESISTANCE RATING

G RESIDENTIAL CORRIDOR CEILINGS TO BE SUSPENDED GYPSUM WALL BOARD, 8'-0" A.F.F.

P PROVIDE ADDITIONAL FURRING AT COLUMNS AS REQUIRED FOR SWITCHES, OUTLETS, ETC.

Q G.C. TO LAYOUT ALL PARTITION AND DOOR LOCATIONS ON FLOOR PRIOR TO PROCEEDING WITH

J ALL INTERIOR RESIDENTIAL UNIT DOORS TO BE NOMINAL 36" SOLID CORE WOOD, U.N.O.

H RESIDENTIAL UNIT CEILING TO BE EXPOSED STRUCTURAL SLAB ABOVE WITH PLASTER COATING, TYPICAL.



### Perkins Eastman DC ONE THOMAS CIRCLE, NW SUITE 270 WASHINGTON, DC 20005 T. 202.495.7430

NO. DATE

**WESTBROOK PARTNERS** 

Construction Manager: **DAVIS CONSTRUCTION** 

Civil / Site: **BOHLER DC** 

Landscape: WOLF | JOSEY LANDSCAPE ARCHITECTS

Structural: SK&A DC

Mechanical & Plumbing: INTERFACE ENGINEERING

Electrical: INTERFACE ENGINEERING

PROJECT TITLE:

MERIDIAN INTERNATIONAL CENTER

PROJECT No: 65930

DRAWING TITLE:

FIRST FLOOR

SCALE: 1/16" = 1'-0"

A-104





- A REFER TO A-400 SERIES DRAWINGS FOR UNIT PLANS.
- B RESIDENTIAL UNIT DEMISING WALLS: 1HR RATED (UL U493); MIN. STC-55; 6-IN (TWO 2-1/2") METAL STUD FRAMING; (2) LAYERS 5/8" TYPE-X GWB EACH SIDE; ACOUSTIC INSULATION
- C RESIDENTIAL UNIT CORRIDOR WALLS: 1HR FIRE RATED (UL U419); MIN. STC-55; 6-IN METAL STUD; (2) LAYERS 5/8" TYPE-X GWB EACH SIDE; ACOUSTIC INSULATION
- E FLOORS BETWEEN RESIDENTIAL (R2), GARAGE (S2), AND CONFERENCE(A3) USES TO MAINTAIN 3-HR FIRE
- Q G.C. TO LAYOUT ALL PARTITION AND DOOR LOCATIONS ON FLOOR PRIOR TO PROCEEDING WITH



NO. DATE

**WESTBROOK PARTNERS** 

Construction Manager: **DAVIS CONSTRUCTION** 

Civil / Site: **BOHLER DC** 

Landscape: WOLF | JOSEY LANDSCAPE ARCHITECTS

Structural: SK&A DC

Mechanical & Plumbing: INTERFACE ENGINEERING

Electrical: INTERFACE ENGINEERING

PROJECT TITLE:

MERIDIAN INTERNATIONAL CENTER

PROJECT No: 65930

DRAWING TITLE:

SECOND FLOOR

SCALE: 1/16" = 1'-0"

**A-105** 





- A REFER TO A-400 SERIES DRAWINGS FOR UNIT PLANS.
- B RESIDENTIAL UNIT DEMISING WALLS: 1HR RATED (UL U493); MIN. STC-55; 6-IN (TWO 2-1/2") METAL STUD FRAMING; (2) LAYERS 5/8" TYPE-X GWB EACH SIDE; ACOUSTIC INSULATION
- C RESIDENTIAL UNIT CORRIDOR WALLS: 1HR FIRE RATED (UL U419); MIN. STC-55; 6-IN METAL STUD; (2) LAYERS 5/8" TYPE-X GWB EACH SIDE; ACOUSTIC INSULATION

  - F VERTICAL SHAFTS FOR CIRCULATION AND BUILDING SYSTEMS TO MAINTAIN 2HR FIRE RESISTANCE RATING
  - H RESIDENTIAL UNIT CEILING TO BE EXPOSED STRUCTURAL SLAB ABOVE WITH PLASTER COATING, TYPICAL.



**WESTBROOK PARTNERS** 

NO. DATE

Construction Manager: **DAVIS CONSTRUCTION** 

Civil / Site: **BOHLER DC** 

WOLF | JOSEY LANDSCAPE ARCHITECTS

Structural: SK&A DC

Mechanical & Plumbing: INTERFACE ENGINEERING

Electrical: INTERFACE ENGINEERING

PROJECT TITLE:

MERIDIAN INTERNATIONAL CENTER

PROJECT No: 65930

DRAWING TITLE:

THIRD FLOOR

SCALE: 1/16" = 1'-0"

**A-106** 





- A REFER TO A-400 SERIES DRAWINGS FOR UNIT PLANS.
- B RESIDENTIAL UNIT DEMISING WALLS: 1HR RATED (UL U493); MIN. STC-55; 6-IN (TWO 2-1/2") METAL STUD FRAMING; (2) LAYERS 5/8" TYPE-X GWB EACH SIDE; ACOUSTIC INSULATION
- C RESIDENTIAL UNIT CORRIDOR WALLS: 1HR FIRE RATED (UL U419); MIN. STC-55; 6-IN METAL STUD; (2) LAYERS 5/8" TYPE-X GWB EACH SIDE; ACOUSTIC INSULATION
- D FLOORS BETWEEN RESIDENTIAL LEVELS TO MAINTAIN 2-HR FIRE RESISTANCE RATING
- P PROVIDE ADDITIONAL FURRING AT COLUMNS AS REQUIRED FOR SWITCHES, OUTLETS, ETC.
- F VERTICAL SHAFTS FOR CIRCULATION AND BUILDING SYSTEMS TO MAINTAIN 2HR FIRE RESISTANCE RATING
- H RESIDENTIAL UNIT CEILING TO BE EXPOSED STRUCTURAL SLAB ABOVE WITH PLASTER COATING, TYPICAL.



**WESTBROOK PARTNERS** 

NO. DATE

Construction Manager: **DAVIS CONSTRUCTION** 

**BOHLER DC** 

Civil / Site:

Landscape: WOLF | JOSEY LANDSCAPE ARCHITECTS

Structural: SK&A DC

Mechanical & Plumbing: INTERFACE ENGINEERING

Electrical: INTERFACE ENGINEERING

PROJECT TITLE:

MERIDIAN INTERNATIONAL CENTER

PROJECT No: 65930

DRAWING TITLE:

FOURTH FLOOR

SCALE: 1/16" = 1'-0"

**A-107** 



GENERAL PLAN NOTES

A REFER TO A-400 SERIES DRAWINGS FOR UNIT PLANS.

B RESIDENTIAL UNIT DEMISING WALLS: 1HR RATED (UL U493); MIN. STC-55; 6-IN (TWO 2-1/2") METAL STUD FRAMING; (2) LAYERS 5/8" TYPE-X GWB EACH SIDE; ACOUSTIC INSULATION

C RESIDENTIAL UNIT CORRIDOR WALLS: 1HR FIRE RATED (UL U419); MIN. STC-55; 6-IN METAL STUD; (2) LAYERS 5/8" TYPE-X GWB EACH SIDE; ACOUSTIC INSULATION

D FLOORS BETWEEN RESIDENTIAL LEVELS TO MAINTAIN 2-HR FIRE RESISTANCE RATING

E FLOORS BETWEEN RESIDENTIAL (R2), GARAGE (S2), AND CONFERENCE(A3) USES TO MAINTAIN 3-HR FIRE

RESISTANCE RATING. G RESIDENTIAL CORRIDOR CEILINGS TO BE SUSPENDED GYPSUM WALL BOARD, 8'-0" A.F.F.

J ALL DIMENSIONS ARE TO FACE OF GYP. BD. U.N.O.

L ALL DIMENSIONS AT 90deg. ANGLES, U.N.O.

M ALL MANUFACTURER'S NAME, TRADEMARK, AND LOGOS SHALL NOT BE VISIBLE. N PATCH AND LEVEL FLOOR SLAB AS REQUIRED FOR SCHEDULED FINISHES.

O ALL WOOD BLOCKING FOR FRAMING AND MILLWORK TO BE FIRE RETARDANT TREATED.

P PROVIDE ADDITIONAL FURRING AT COLUMNS AS REQUIRED FOR SWITCHES, OUTLETS, ETC.

Q G.C. TO LAYOUT ALL PARTITION AND DOOR LOCATIONS ON FLOOR PRIOR TO PROCEEDING WITH

F VERTICAL SHAFTS FOR CIRCULATION AND BUILDING SYSTEMS TO MAINTAIN 2HR FIRE RESISTANCE RATING

I RESIDENTIAL UNIT BATHROOM AND CEILINGS TO BE SUSPENDED GYPSUM WALL BOARD, 8'-0" A.F.F.



### Perkins Eastman DC ONE THOMAS CIRCLE, NW SUITE 270 WASHINGTON, DC 20005 T. 202.495.7430

**WESTBROOK PARTNERS** 

NO. DATE

**DAVIS CONSTRUCTION** 

Construction Manager:

**BOHLER DC** 

Civil / Site:

Landscape: **WOLF | JOSEY LANDSCAPE ARCHITECTS** 

Structural: SK&A DC

Mechanical & Plumbing: INTERFACE ENGINEERING

Electrical: INTERFACE ENGINEERING

PROJECT TITLE:


MERIDIAN INTERNATIONAL CENTER

PROJECT No: 65930

DRAWING TITLE: FIFTH FLOOR

SCALE: 1/16" = 1'-0"

**A-108** 

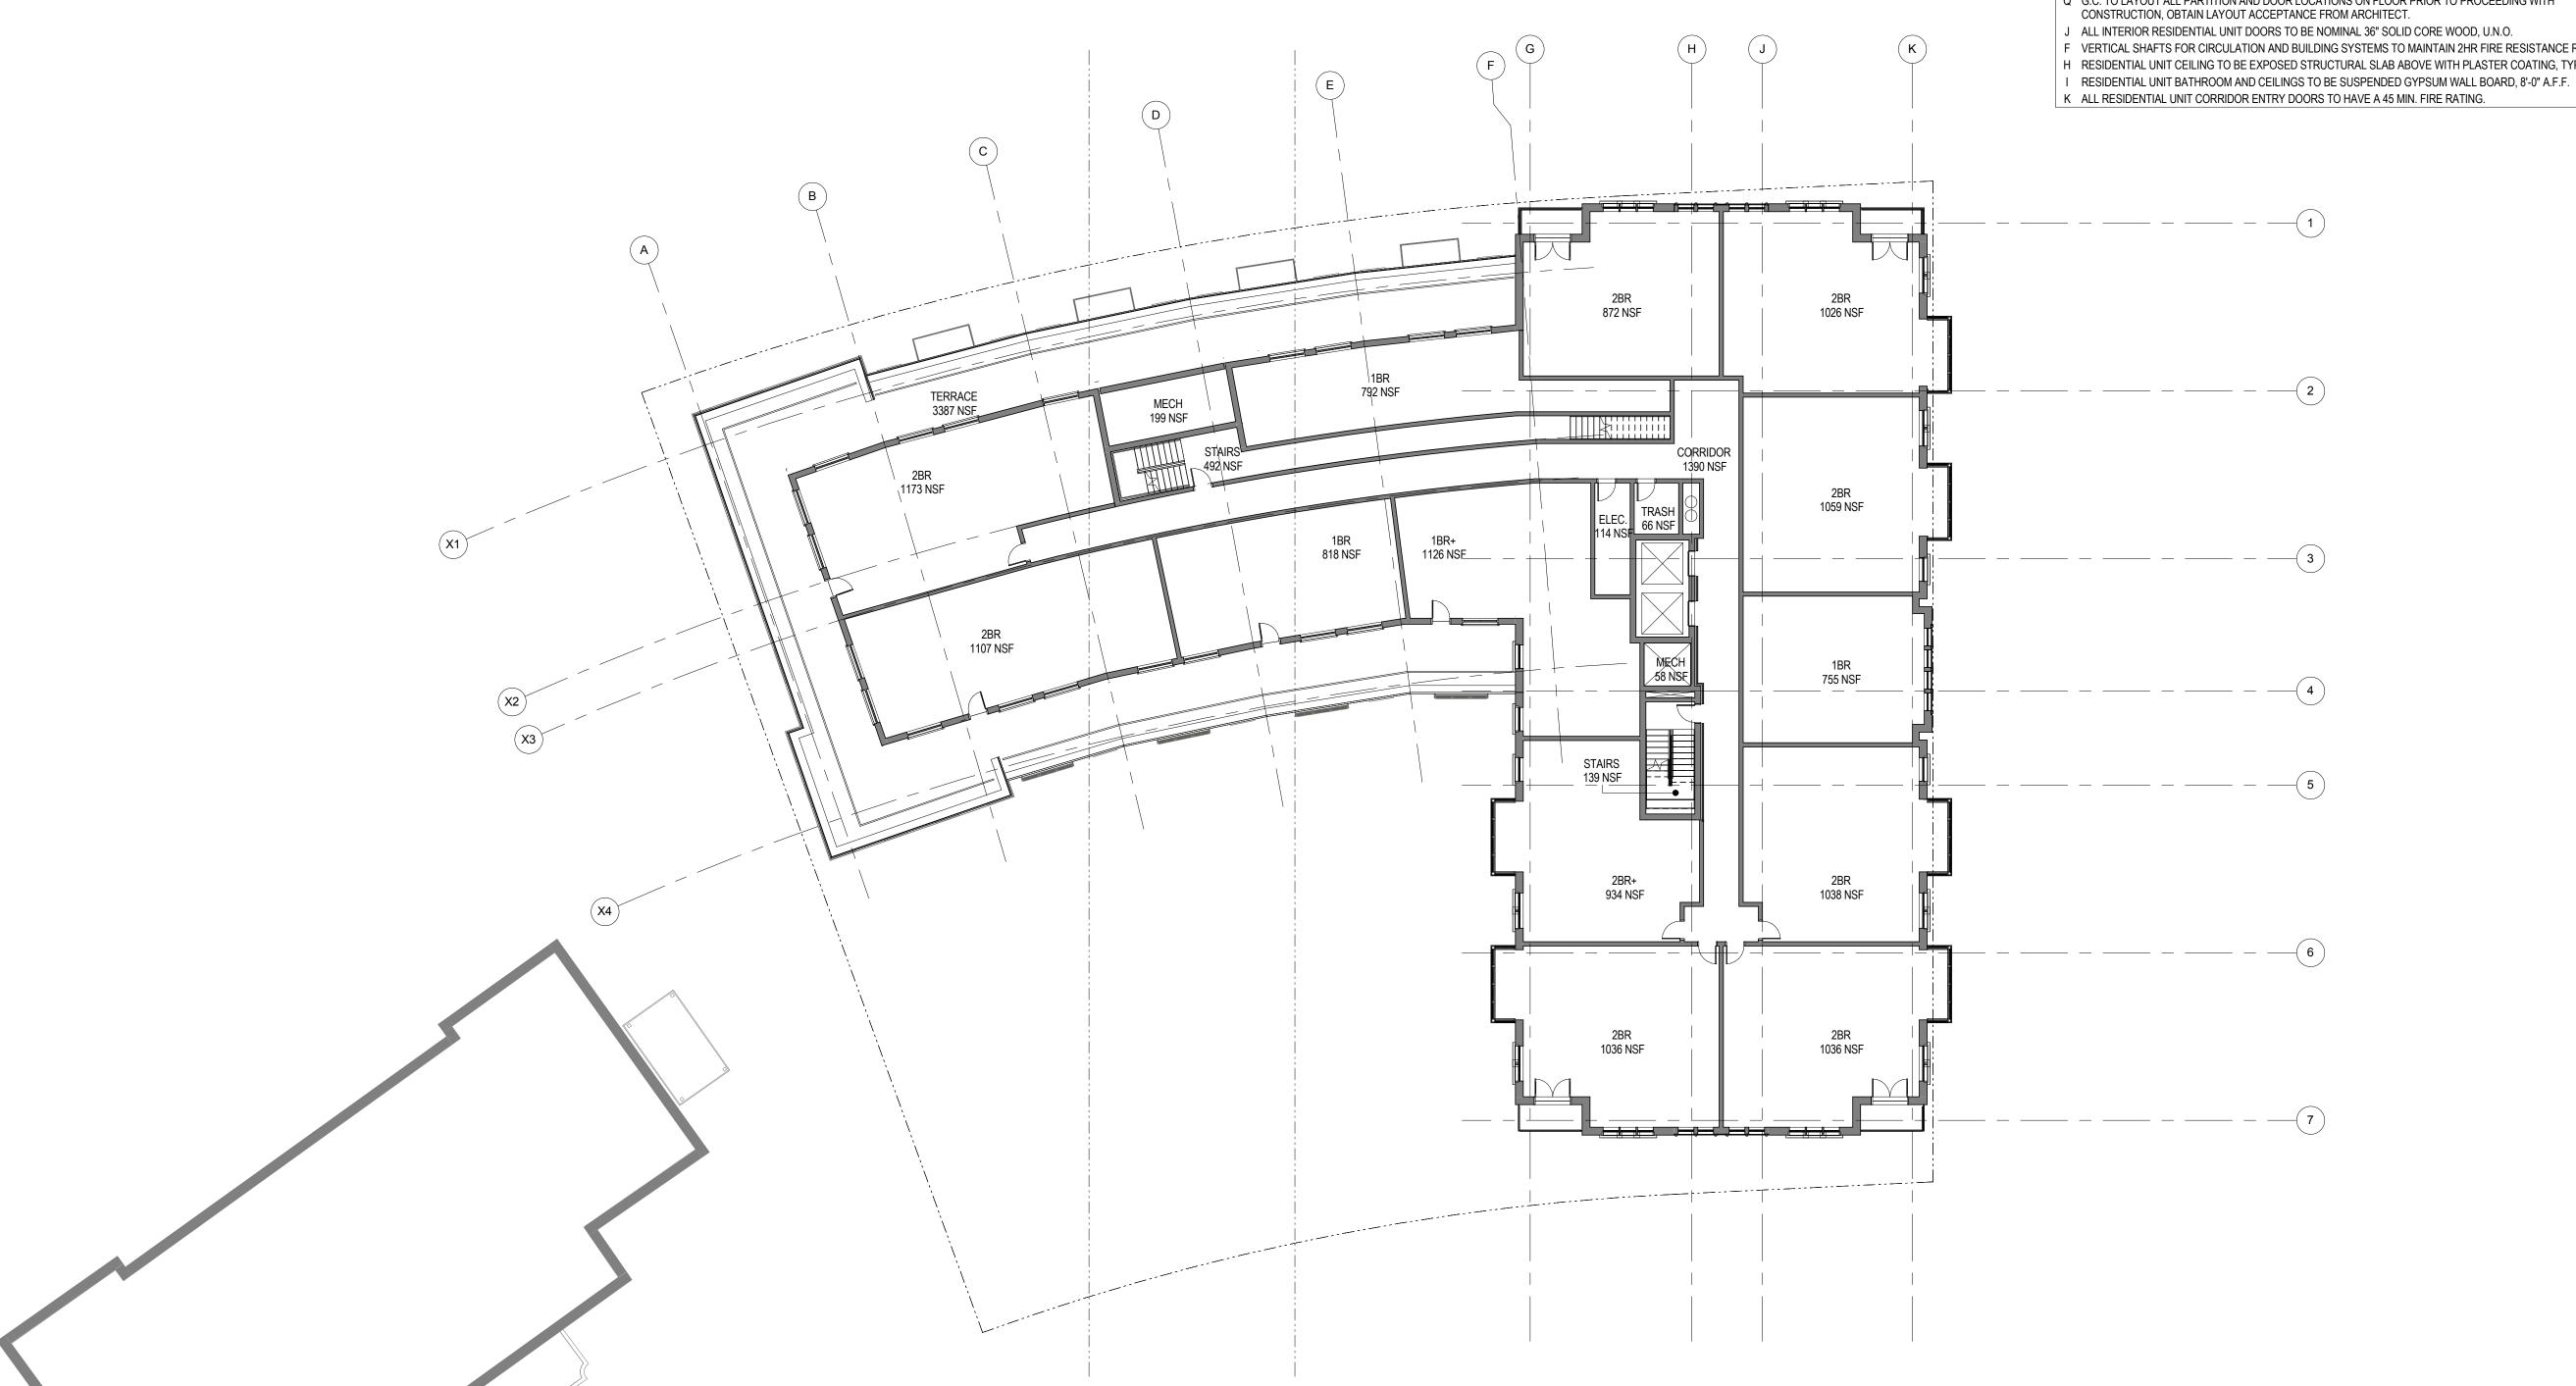



- A REFER TO A-400 SERIES DRAWINGS FOR UNIT PLANS.
- B RESIDENTIAL UNIT DEMISING WALLS: 1HR RATED (UL U493); MIN. STC-55; 6-IN (TWO 2-1/2") METAL STUD FRAMING; (2) LAYERS 5/8" TYPE-X GWB EACH SIDE; ACOUSTIC INSULATION
- C RESIDENTIAL UNIT CORRIDOR WALLS: 1HR FIRE RATED (UL U419); MIN. STC-55; 6-IN METAL STUD; (2) LAYERS 5/8" TYPE-X GWB EACH SIDE; ACOUSTIC INSULATION
- D FLOORS BETWEEN RESIDENTIAL LEVELS TO MAINTAIN 2-HR FIRE RESISTANCE RATING
- E FLOORS BETWEEN RESIDENTIAL (R2), GARAGE (S2), AND CONFERENCE(A3) USES TO MAINTAIN 3-HR FIRE RESISTANCE RATING.
- G RESIDENTIAL CORRIDOR CEILINGS TO BE SUSPENDED GYPSUM WALL BOARD, 8'-0" A.F.F.
- J ALL DIMENSIONS ARE TO FACE OF GYP. BD. U.N.O.
- L ALL DIMENSIONS AT 90deg. ANGLES, U.N.O.
- M ALL MANUFACTURER'S NAME, TRADEMARK, AND LOGOS SHALL NOT BE VISIBLE. N PATCH AND LEVEL FLOOR SLAB AS REQUIRED FOR SCHEDULED FINISHES.
- O ALL WOOD BLOCKING FOR FRAMING AND MILLWORK TO BE FIRE RETARDANT TREATED.
- P PROVIDE ADDITIONAL FURRING AT COLUMNS AS REQUIRED FOR SWITCHES, OUTLETS, ETC. Q G.C. TO LAYOUT ALL PARTITION AND DOOR LOCATIONS ON FLOOR PRIOR TO PROCEEDING WITH
- J ALL INTERIOR RESIDENTIAL UNIT DOORS TO BE NOMINAL 36" SOLID CORE WOOD, U.N.O.
- F VERTICAL SHAFTS FOR CIRCULATION AND BUILDING SYSTEMS TO MAINTAIN 2HR FIRE RESISTANCE RATING H RESIDENTIAL UNIT CEILING TO BE EXPOSED STRUCTURAL SLAB ABOVE WITH PLASTER COATING, TYPICAL.

**DAVIS CONSTRUCTION** 

Construction Manager:

**WESTBROOK PARTNERS** 

Civil / Site: **BOHLER DC** 

NO. DATE

Landscape: **WOLF | JOSEY LANDSCAPE ARCHITECTS** 

Structural: SK&A DC

Mechanical & Plumbing: INTERFACE ENGINEERING

Electrical: INTERFACE ENGINEERING

PROJECT TITLE:

MERIDIAN INTERNATIONAL CENTER


PROJECT No: 65930

DRAWING TITLE:

SIXTH FLOOR

SCALE: 1/16" = 1'-0"

**A-109** 

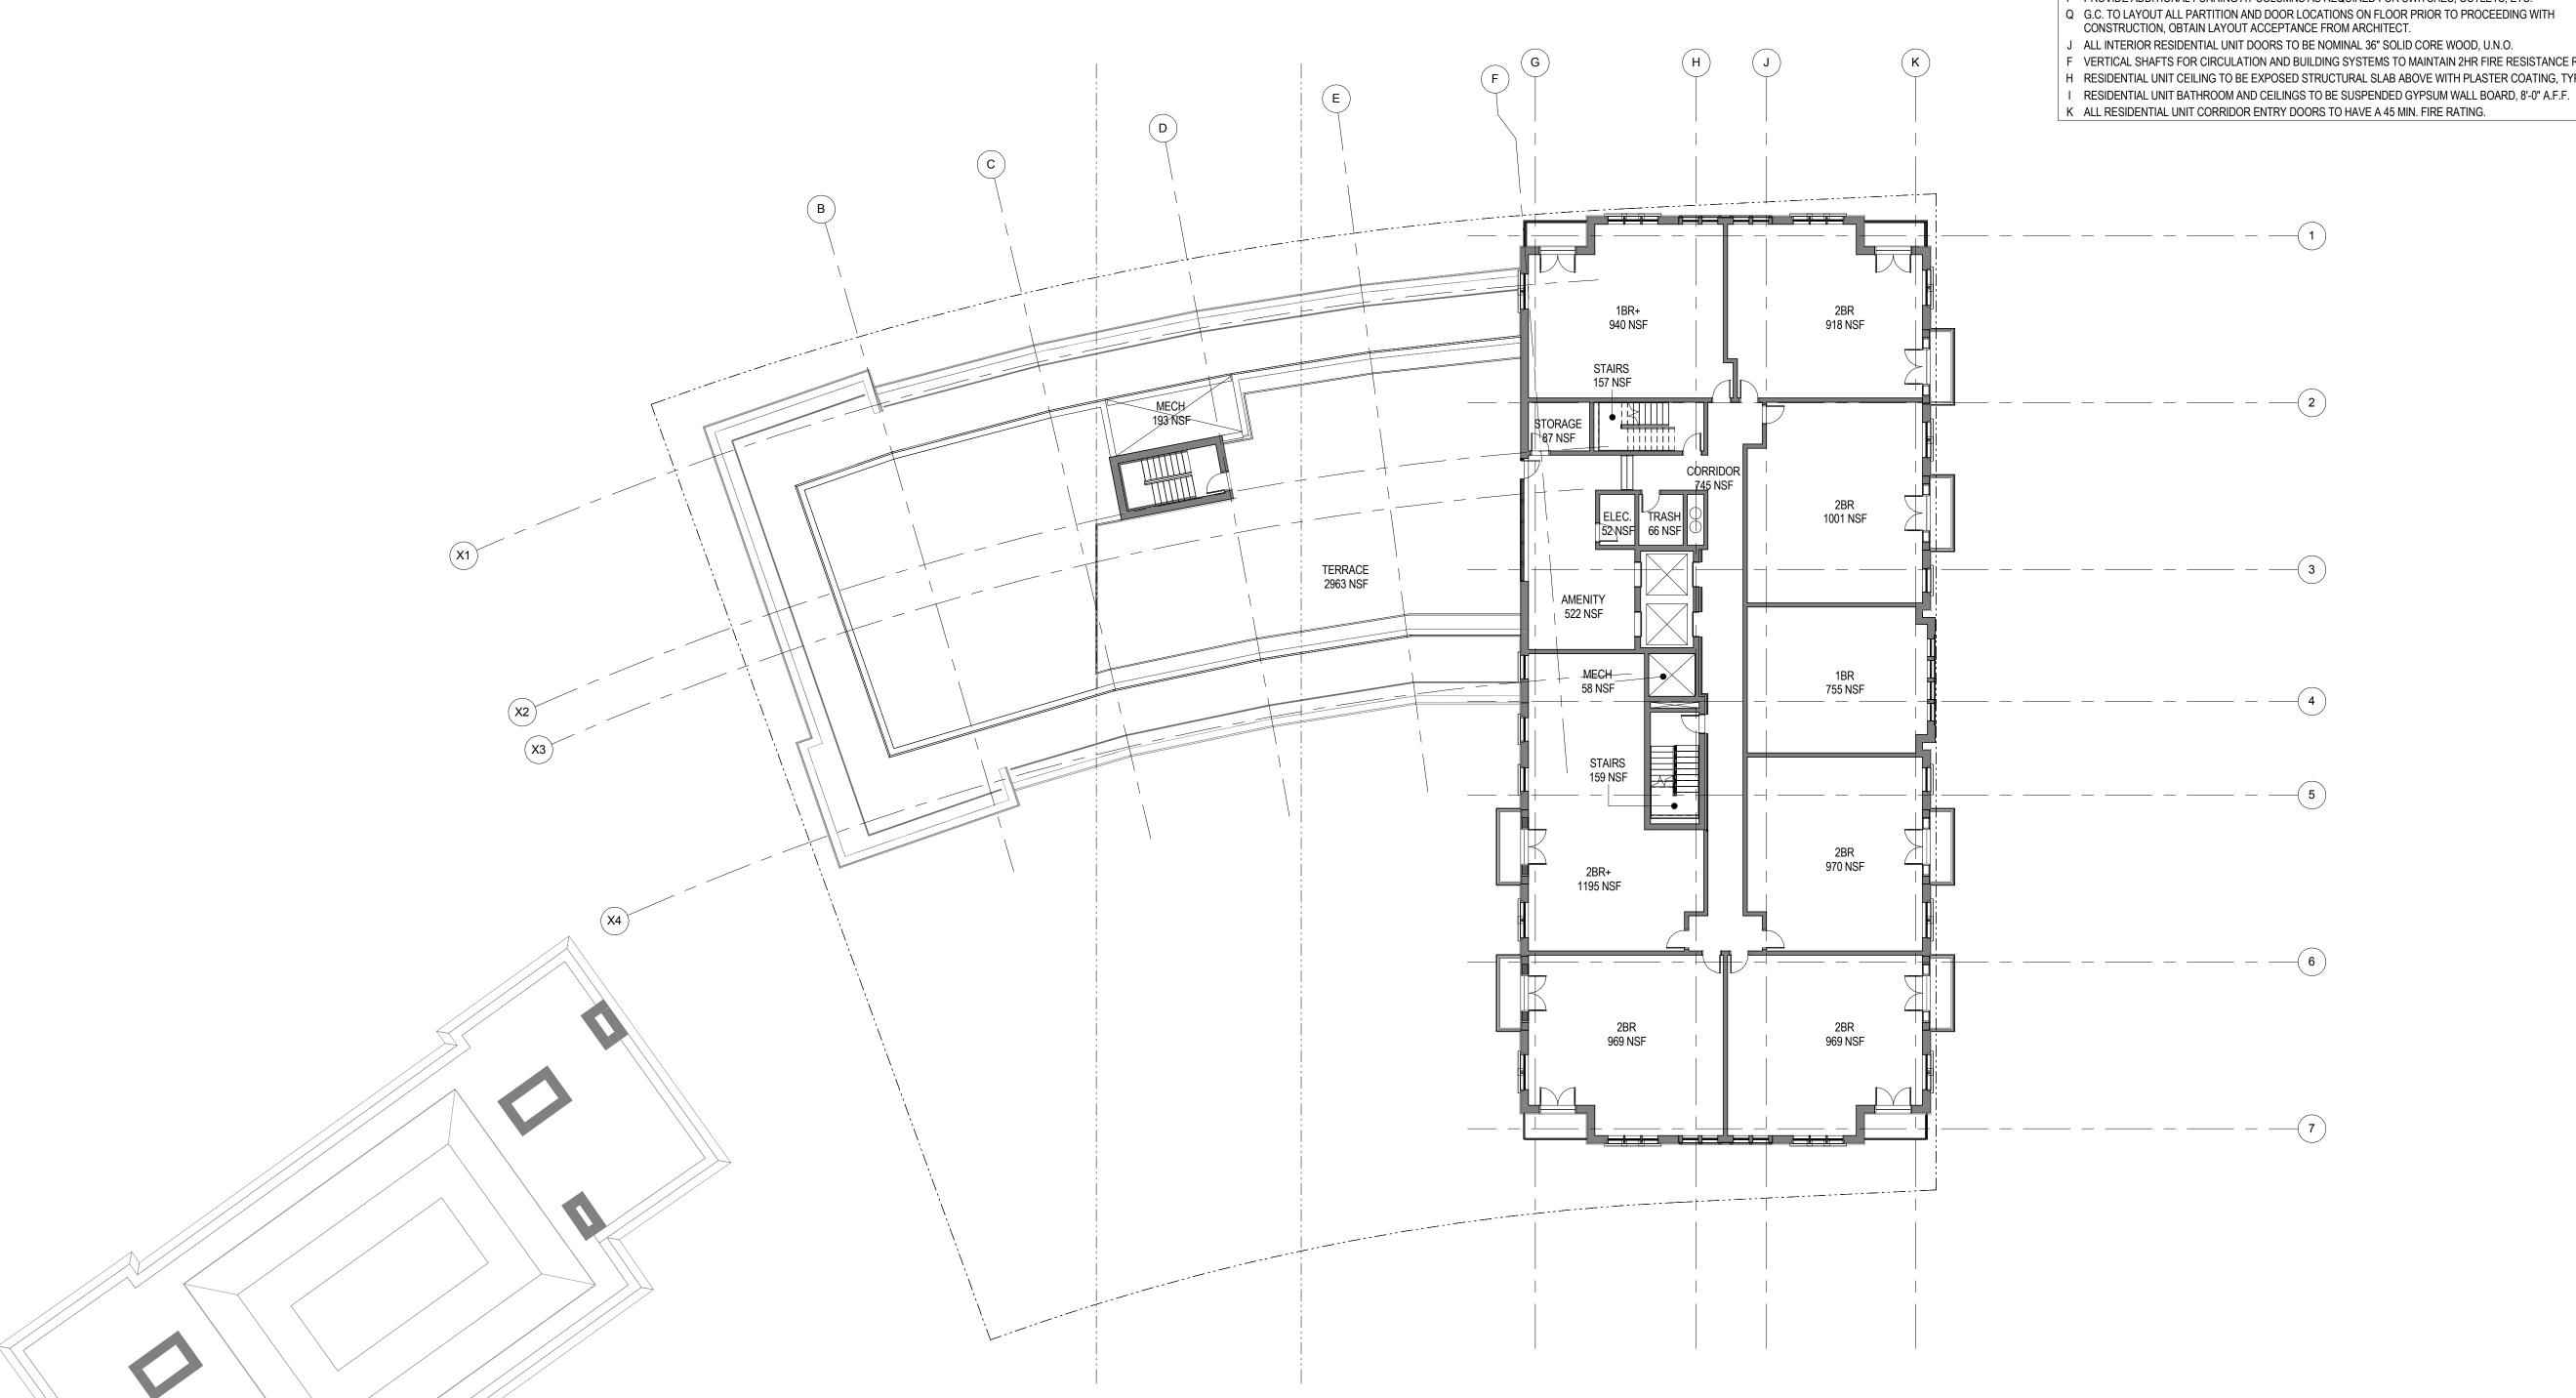

GENERAL PLAN NOTES

A REFER TO A-400 SERIES DRAWINGS FOR UNIT PLANS.

B RESIDENTIAL UNIT DEMISING WALLS: 1HR RATED (UL U493); MIN. STC-55; 6-IN (TWO 2-1/2") METAL STUD FRAMING; (2) LAYERS 5/8" TYPE-X GWB EACH SIDE; ACOUSTIC INSULATION

C RESIDENTIAL UNIT CORRIDOR WALLS: 1HR FIRE RATED (UL U419); MIN. STC-55; 6-IN METAL STUD; (2) LAYERS 5/8" TYPE-X GWB EACH SIDE; ACOUSTIC INSULATION

D FLOORS BETWEEN RESIDENTIAL LEVELS TO MAINTAIN 2-HR FIRE RESISTANCE RATING

E FLOORS BETWEEN RESIDENTIAL (R2), GARAGE (S2), AND CONFERENCE(A3) USES TO MAINTAIN 3-HR FIRE RESISTANCE RATING.

G RESIDENTIAL CORRIDOR CEILINGS TO BE SUSPENDED GYPSUM WALL BOARD, 8'-0" A.F.F.

J ALL DIMENSIONS ARE TO FACE OF GYP. BD. U.N.O.

L ALL DIMENSIONS AT 90deg. ANGLES, U.N.O.

M ALL MANUFACTURER'S NAME, TRADEMARK, AND LOGOS SHALL NOT BE VISIBLE. N PATCH AND LEVEL FLOOR SLAB AS REQUIRED FOR SCHEDULED FINISHES.

O ALL WOOD BLOCKING FOR FRAMING AND MILLWORK TO BE FIRE RETARDANT TREATED. P PROVIDE ADDITIONAL FURRING AT COLUMNS AS REQUIRED FOR SWITCHES, OUTLETS, ETC.

Q G.C. TO LAYOUT ALL PARTITION AND DOOR LOCATIONS ON FLOOR PRIOR TO PROCEEDING WITH

J ALL INTERIOR RESIDENTIAL UNIT DOORS TO BE NOMINAL 36" SOLID CORE WOOD, U.N.O.

F VERTICAL SHAFTS FOR CIRCULATION AND BUILDING SYSTEMS TO MAINTAIN 2HR FIRE RESISTANCE RATING H RESIDENTIAL UNIT CEILING TO BE EXPOSED STRUCTURAL SLAB ABOVE WITH PLASTER COATING, TYPICAL.

NO. DATE



# Perkins Eastman DC ONE THOMAS CIRCLE, NW SUITE 270 WASHINGTON, DC 20005 T. 202.495.7430

**WESTBROOK PARTNERS** 

Construction Manager:

**DAVIS CONSTRUCTION** 

Civil / Site: **BOHLER DC** 

**WOLF | JOSEY LANDSCAPE ARCHITECTS** 

Structural: SK&A DC

Mechanical & Plumbing: INTERFACE ENGINEERING

Electrical: INTERFACE ENGINEERING

PROJECT TITLE:

MERIDIAN INTERNATIONAL CENTER


PROJECT No: 65930

DRAWING TITLE:

SEVENTH FLOOR

SCALE: 1/16" = 1'-0"

A-110

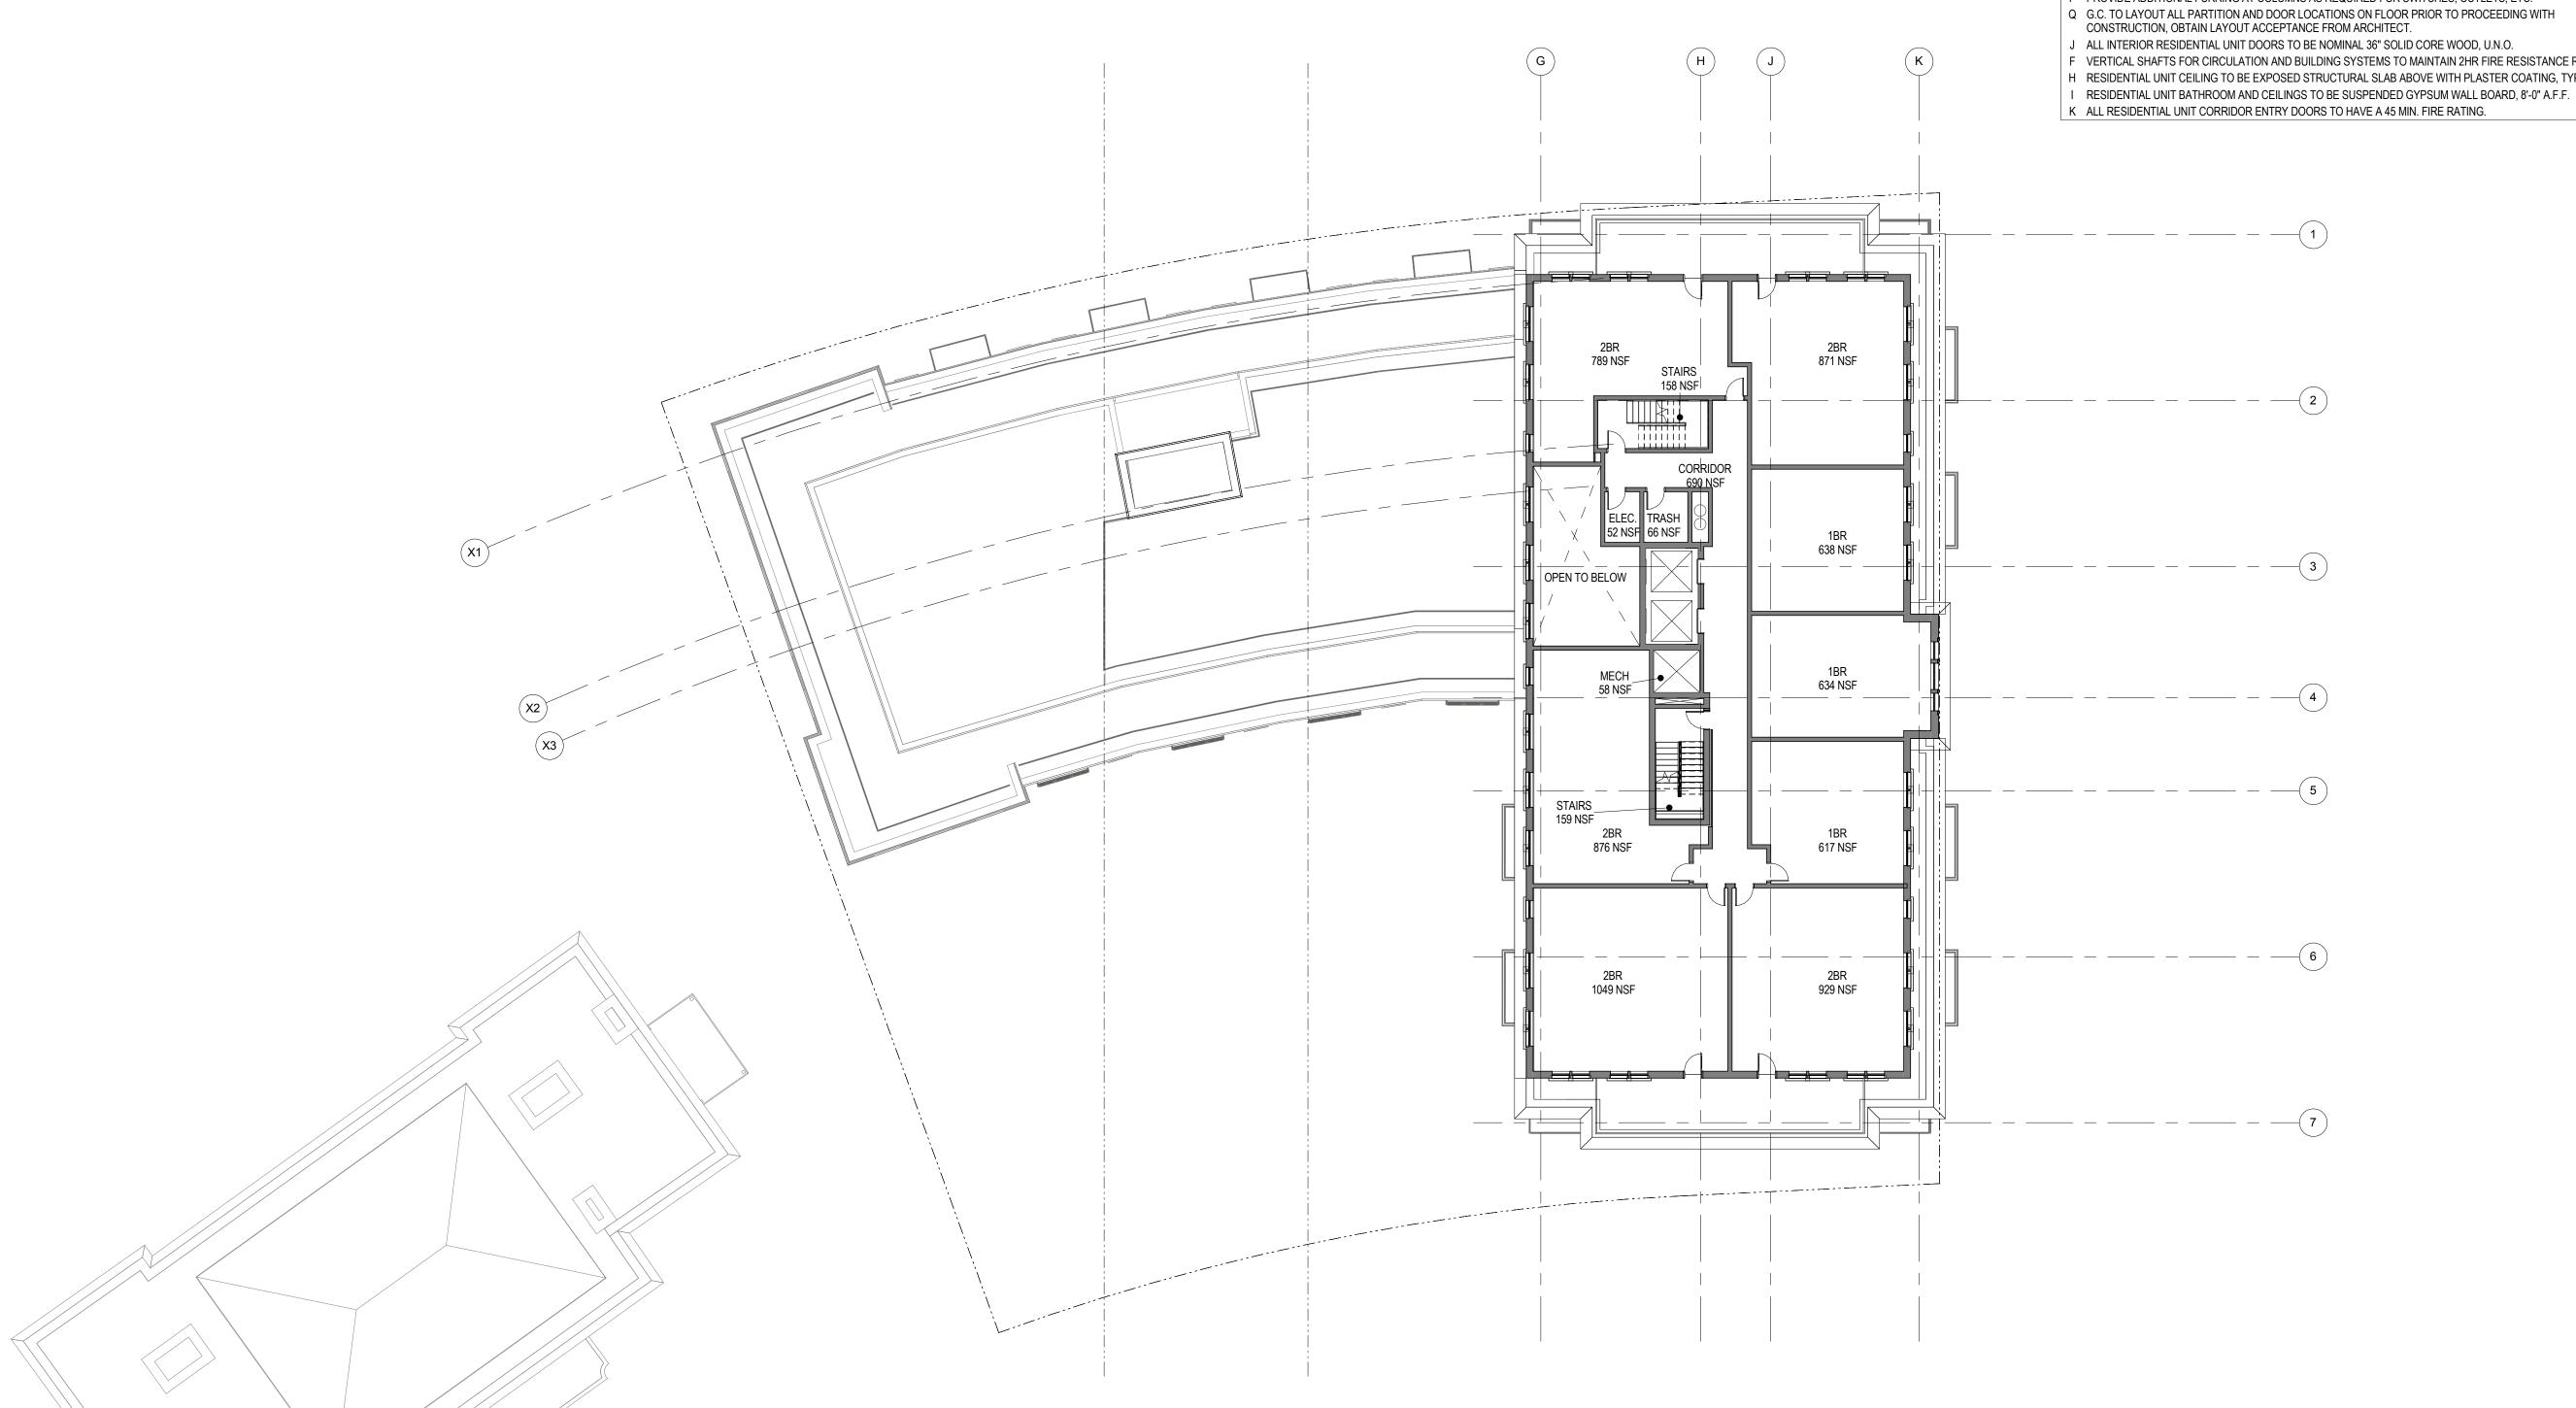



- A REFER TO A-400 SERIES DRAWINGS FOR UNIT PLANS.
- B RESIDENTIAL UNIT DEMISING WALLS: 1HR RATED (UL U493); MIN. STC-55; 6-IN (TWO 2-1/2") METAL STUD FRAMING; (2) LAYERS 5/8" TYPE-X GWB EACH SIDE; ACOUSTIC INSULATION
- C RESIDENTIAL UNIT CORRIDOR WALLS: 1HR FIRE RATED (UL U419); MIN. STC-55; 6-IN METAL STUD; (2) LAYERS 5/8" TYPE-X GWB EACH SIDE; ACOUSTIC INSULATION
- D FLOORS BETWEEN RESIDENTIAL LEVELS TO MAINTAIN 2-HR FIRE RESISTANCE RATING
- E FLOORS BETWEEN RESIDENTIAL (R2), GARAGE (S2), AND CONFERENCE(A3) USES TO MAINTAIN 3-HR FIRE RESISTANCE RATING.
- G RESIDENTIAL CORRIDOR CEILINGS TO BE SUSPENDED GYPSUM WALL BOARD, 8'-0" A.F.F.
- J ALL DIMENSIONS ARE TO FACE OF GYP. BD. U.N.O.
- L ALL DIMENSIONS AT 90deg. ANGLES, U.N.O. M ALL MANUFACTURER'S NAME, TRADEMARK, AND LOGOS SHALL NOT BE VISIBLE.
- N PATCH AND LEVEL FLOOR SLAB AS REQUIRED FOR SCHEDULED FINISHES.
- O ALL WOOD BLOCKING FOR FRAMING AND MILLWORK TO BE FIRE RETARDANT TREATED. P PROVIDE ADDITIONAL FURRING AT COLUMNS AS REQUIRED FOR SWITCHES, OUTLETS, ETC.
- Q G.C. TO LAYOUT ALL PARTITION AND DOOR LOCATIONS ON FLOOR PRIOR TO PROCEEDING WITH
- J ALL INTERIOR RESIDENTIAL UNIT DOORS TO BE NOMINAL 36" SOLID CORE WOOD, U.N.O.
- F VERTICAL SHAFTS FOR CIRCULATION AND BUILDING SYSTEMS TO MAINTAIN 2HR FIRE RESISTANCE RATING H RESIDENTIAL UNIT CEILING TO BE EXPOSED STRUCTURAL SLAB ABOVE WITH PLASTER COATING, TYPICAL.

NO. DATE



# Perkins Eastman DC ONE THOMAS CIRCLE, NW SUITE 270 WASHINGTON, DC 20005 T. 202.495.7430

**WESTBROOK PARTNERS** 

Construction Manager:

**DAVIS CONSTRUCTION** 

Civil / Site: **BOHLER DC** 

Landscape: **WOLF | JOSEY LANDSCAPE ARCHITECTS** 

Structural: SK&A DC

Mechanical & Plumbing: INTERFACE ENGINEERING

Electrical: INTERFACE ENGINEERING

PROJECT TITLE:

MERIDIAN INTERNATIONAL CENTER


PROJECT No: 65930

DRAWING TITLE:

EIGHTH FLOOR

SCALE: 1/16" = 1'-0"

A-111

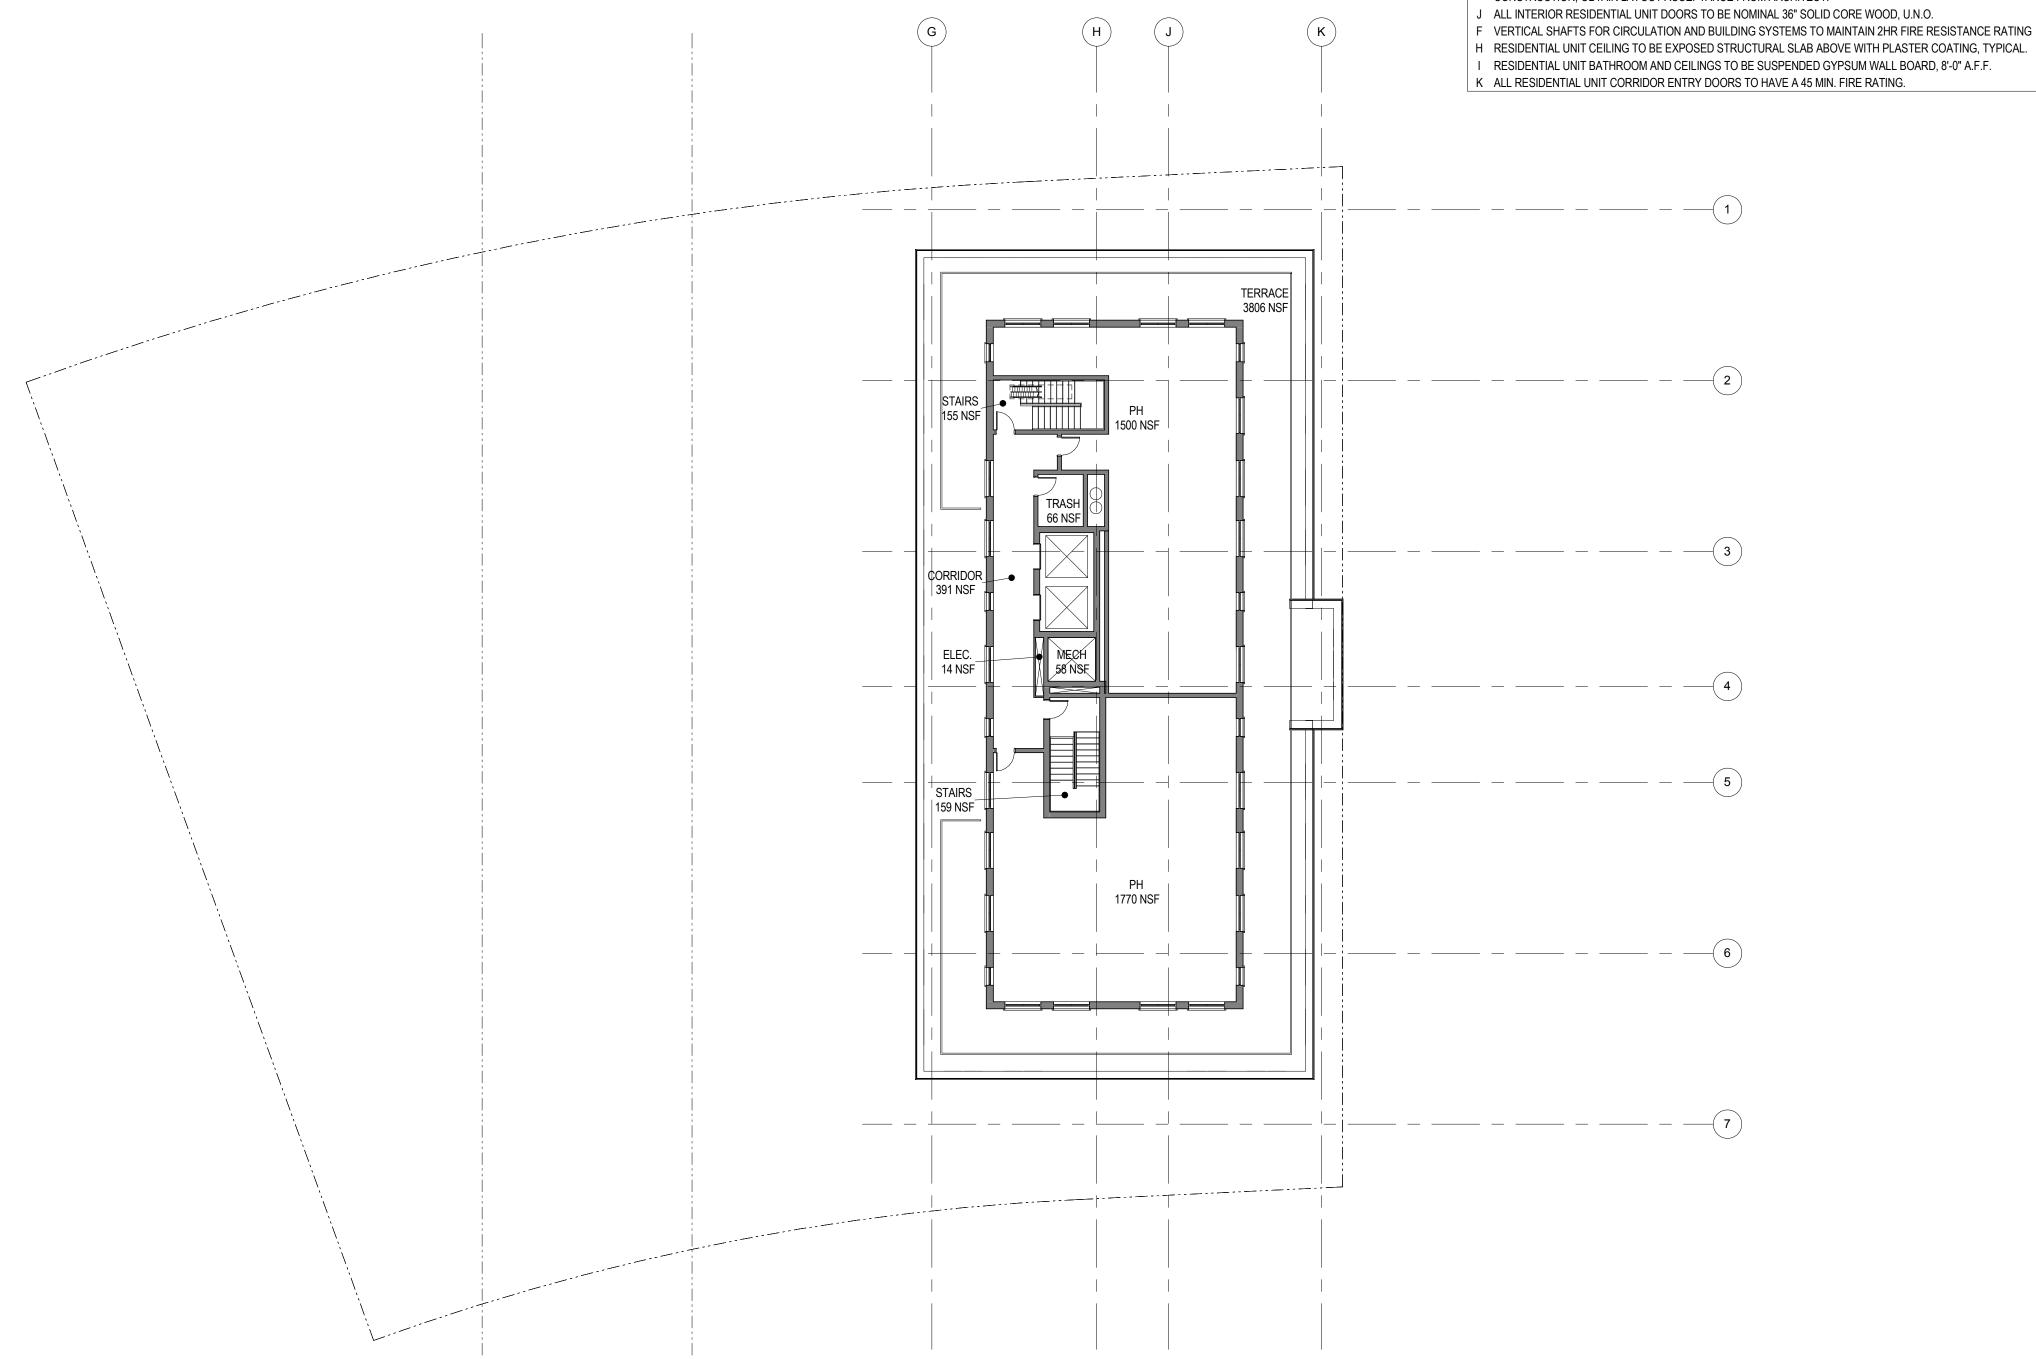



- A REFER TO A-400 SERIES DRAWINGS FOR UNIT PLANS.
- B RESIDENTIAL UNIT DEMISING WALLS: 1HR RATED (UL U493); MIN. STC-55; 6-IN (TWO 2-1/2") METAL STUD FRAMING; (2) LAYERS 5/8" TYPE-X GWB EACH SIDE; ACOUSTIC INSULATION
- C RESIDENTIAL UNIT CORRIDOR WALLS: 1HR FIRE RATED (UL U419); MIN. STC-55; 6-IN METAL STUD; (2) LAYERS 5/8" TYPE-X GWB EACH SIDE; ACOUSTIC INSULATION
- D FLOORS BETWEEN RESIDENTIAL LEVELS TO MAINTAIN 2-HR FIRE RESISTANCE RATING
- E FLOORS BETWEEN RESIDENTIAL (R2), GARAGE (S2), AND CONFERENCE(A3) USES TO MAINTAIN 3-HR FIRE
- RESISTANCE RATING. G RESIDENTIAL CORRIDOR CEILINGS TO BE SUSPENDED GYPSUM WALL BOARD, 8'-0" A.F.F.
- J ALL DIMENSIONS ARE TO FACE OF GYP. BD. U.N.O.
- L ALL DIMENSIONS AT 90deg. ANGLES, U.N.O. M ALL MANUFACTURER'S NAME, TRADEMARK, AND LOGOS SHALL NOT BE VISIBLE.
- N PATCH AND LEVEL FLOOR SLAB AS REQUIRED FOR SCHEDULED FINISHES.
- O ALL WOOD BLOCKING FOR FRAMING AND MILLWORK TO BE FIRE RETARDANT TREATED. P PROVIDE ADDITIONAL FURRING AT COLUMNS AS REQUIRED FOR SWITCHES, OUTLETS, ETC.
- Q G.C. TO LAYOUT ALL PARTITION AND DOOR LOCATIONS ON FLOOR PRIOR TO PROCEEDING WITH
- CONSTRUCTION, OBTAIN LAYOUT ACCEPTANCE FROM ARCHITECT.
- F VERTICAL SHAFTS FOR CIRCULATION AND BUILDING SYSTEMS TO MAINTAIN 2HR FIRE RESISTANCE RATING
- I RESIDENTIAL UNIT BATHROOM AND CEILINGS TO BE SUSPENDED GYPSUM WALL BOARD, 8'-0" A.F.F.



**WESTBROOK PARTNERS** 

NO. DATE

Construction Manager: **DAVIS CONSTRUCTION** 

Civil / Site: **BOHLER DC** 

Landscape: **WOLF | JOSEY LANDSCAPE ARCHITECTS** 

Structural: SK&A DC

Mechanical & Plumbing: INTERFACE ENGINEERING

Electrical: INTERFACE ENGINEERING

PROJECT TITLE:

MERIDIAN INTERNATIONAL CENTER


PROJECT No: 65930

DRAWING TITLE:


NINTH FLOOR (PENTHOUSE)

SCALE: 1/16" = 1'-0"

**A-112** 

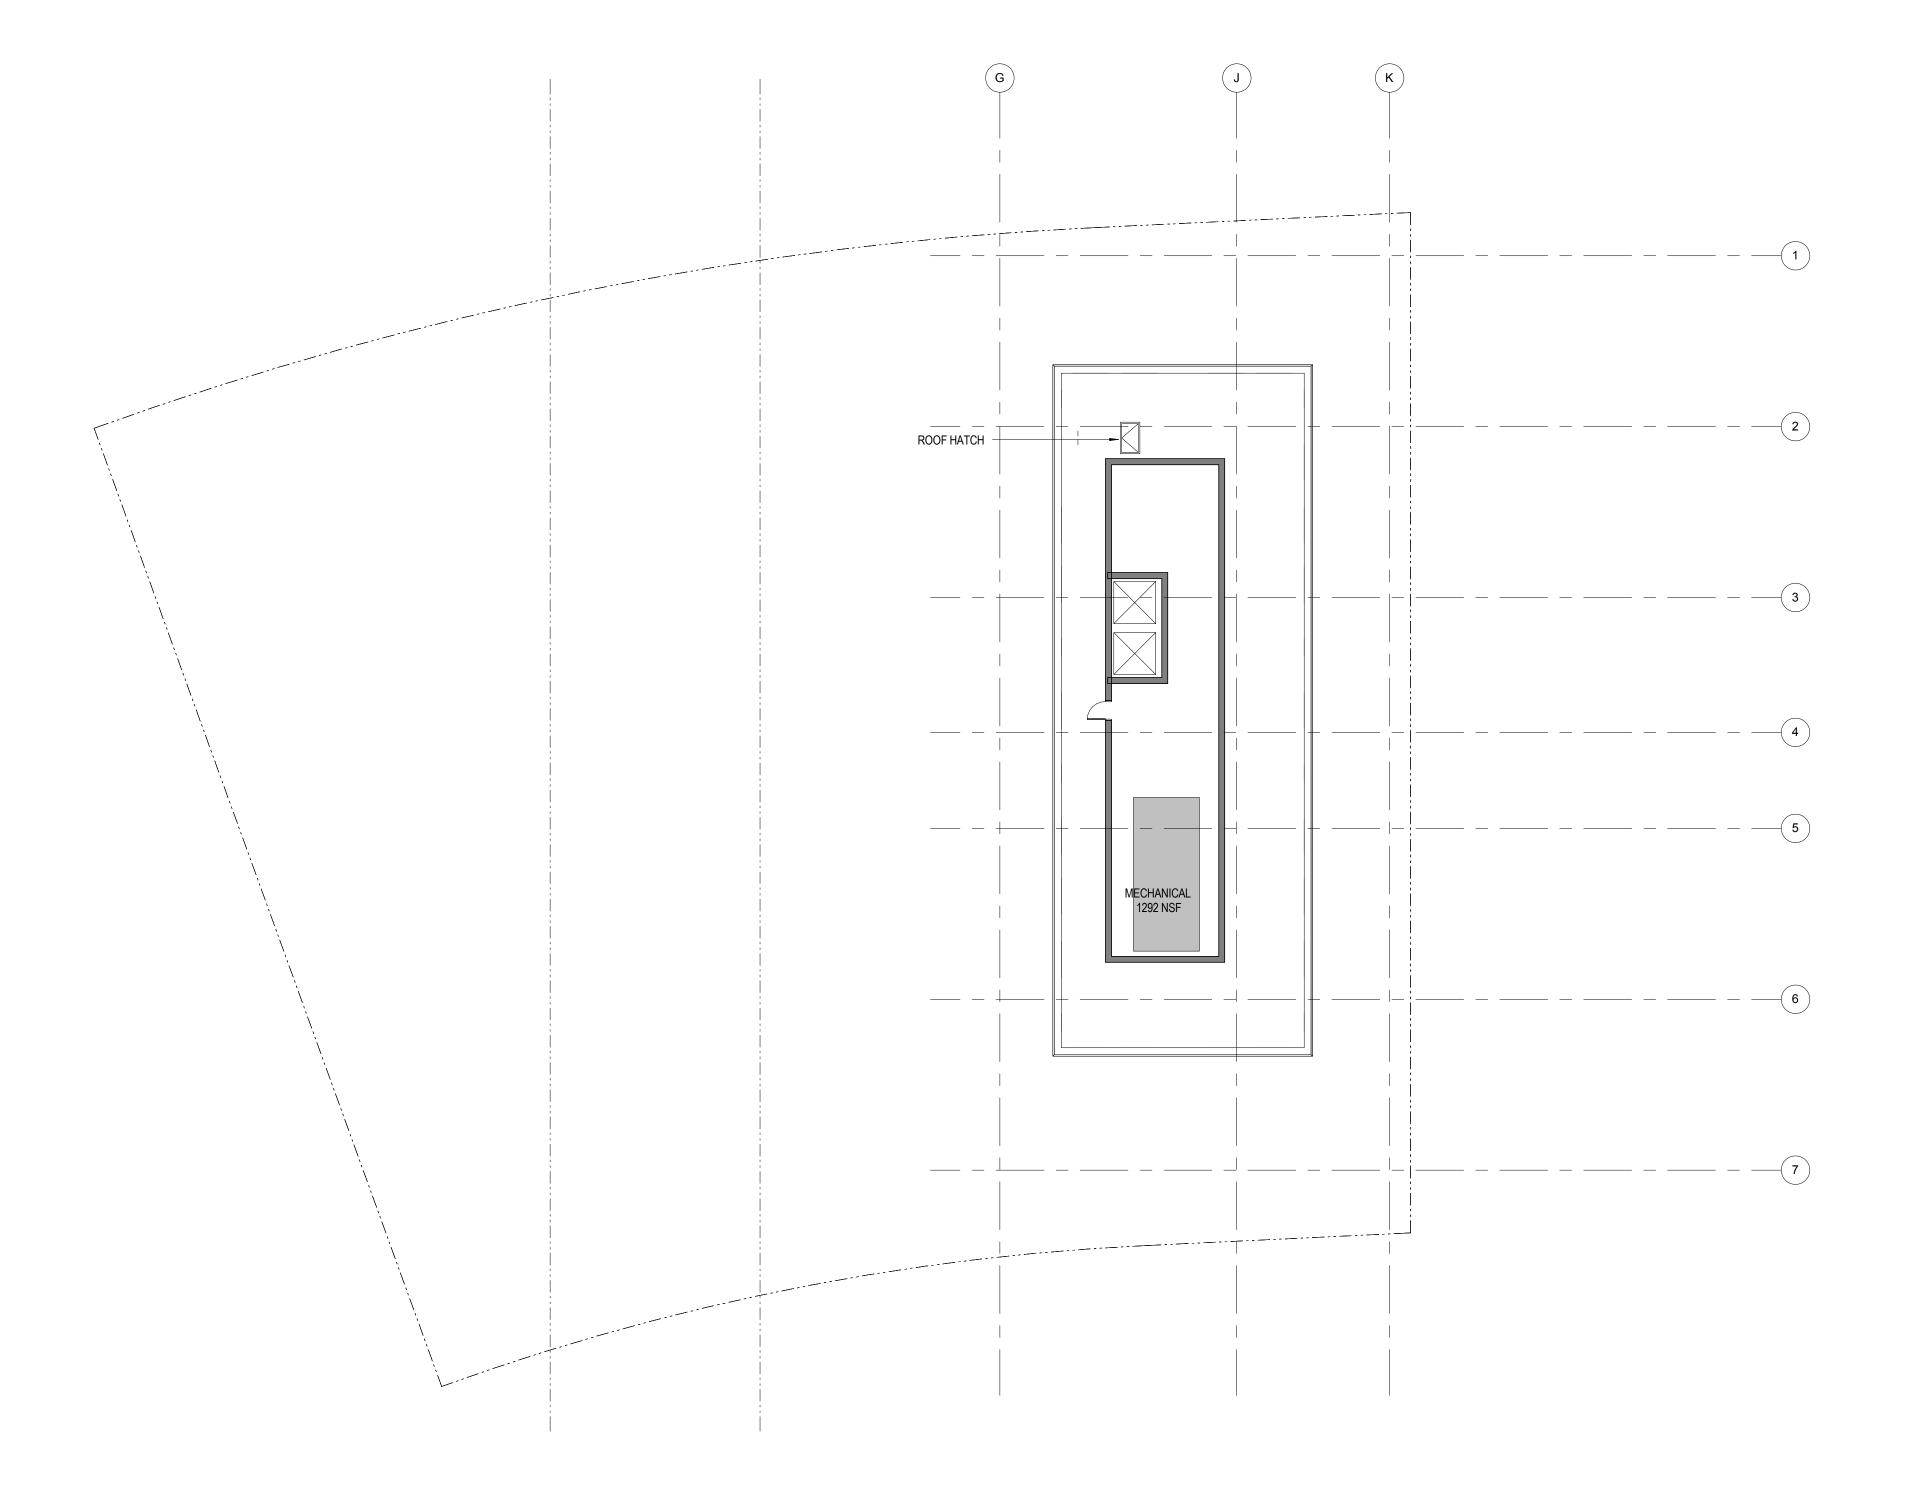

NO. DATE

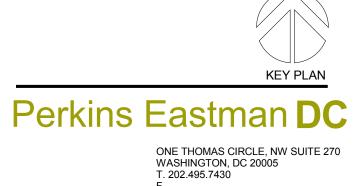

Owner: WESTBROOK PARTNERS

Construction Manager:

DAVIS CONSTRUCTION

Civil / Site: BOHLER DC

Landscape: WOLF | JOSEY LANDSCAPE ARCHITECTS

Structural: SK&A DC

Mechanical & Plumbing: INTERFACE ENGINEERING

Electrical:
INTERFACE ENGINEERING

PROJECT TITLE:

MERIDIAN INTERNATIONAL CENTER

PROJECT No: 65930

ROOF

SCALE: 1/16" = 1'-0"

**A-113** 

SCHEMATIC DESIGN

03/13/18

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1 SOUTH ELEVATION
1/8" = 1'-0"

SCALE: 1/8" = 1'-0"

NO. DATE

**A-201** 

SCHEMATIC DESIGN

03/13/18

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MERIDIAN INTERNATIONAL CENTER 02\_SECOND FLOOR 179' - 4"

PROJECT No: 65930

DRAWING TITLE:

01\_FIRST FLOOR / BHMP NORTH ELEVATION

KEY PLAN

ONE THOMAS CIRCLE, NW SUITE 270 WASHINGTON, DC 20005 T. 202.495.7430

**NORTH ELEVATION - GARDEN APARTMENTS** 

SCALE: 1/8" = 1'-0"

**A-202** 

SCHEMATIC DESIGN

03/13/18



PROJECT TITLE: MERIDIAN INTERNATIONAL CENTER

> DRAWING TITLE: EAST ELEVATION

SCALE: 1/8" = 1'-0"

NO. DATE

KEY PLAN

ONE THOMAS CIRCLE, NW SUITE 270 WASHINGTON, DC 20005 T. 202.495.7430

**WESTBROOK PARTNERS** 

**DAVIS CONSTRUCTION** 

**WOLF | JOSEY LANDSCAPE ARCHITECTS** 

**BOHLER DC** 

SK&A DC

Mechanical & Plumbing:

**INTERFACE ENGINEERING** 

INTERFACE ENGINEERING

**A-203** 

SCHEMATIC DESIGN


03/13/18

**EAST ELEVATION** 



1 WEST ELEVATION
1/8" = 1'-0"

c

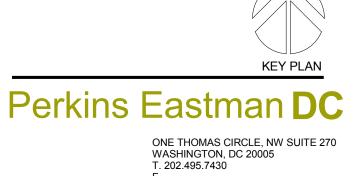

Owner:
WESTBROOK PARTNERS

NO. DATE

Construction Manager: **DAVIS CONSTRUCTION** 

Civil / Site: BOHLER DC

Landscape:
WOLF | JOSEY LANDSCAPE ARCHITECTS

Structural: SK&A DC

Mechanical & Plumbing:
INTERFACE ENGINEERING

Electrical:

INTERFACE ENGINEERING

PROJECT TITLE:

MERIDIAN INTERNATIONAL CENTER

PROJECT No: 65930

DRAWING TITLE:

WEST ELEVATION

SCALE: 1/8" = 1'-0"

**A-204** 

SCHEMATIC DESIGN

03/13/18

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