

Tab C

FEDERATION OF STATE MEDICAL BOARDS (FSMB)

2118 Leroy Place NW
Washington, DC 20008



Federation of State Medical Boards (FSMB)

Client
2118 Leroy Place NW
Washington, DC 20008

Gensler

Architect
2020 K Street NW
Washington DC 20006
Telephone 202.721.5200
Facsimile 202.872.8587

ISSUE FOR PRECONSTRUCTION DEMOLITION

04/19/19

These plans are conditionally approved as submitted or noted during plan review and are subject to field inspection. Approved plans must be kept on site and are needed for all inspections. No changes or modifications to these plans. Changes require a revision permit with the revised plans. Trade Permits are required for trade work. e.g. Electrical or Plumbing

HPRB Review - Timothy Dennee - 06-07-2019
Structural Review - Semere Hadera - 06-07-2019


Federation of State Medical Boards (FSMB)

2118 Leroy Place NW
Washington, DC 20008

Gensler

2020 K Street NW
Washington, DC 20006
Tel 202.721.5200

Date	Description
1 04/19/19	ISSUE FOR PRECONSTRUCTION DEMOLITION

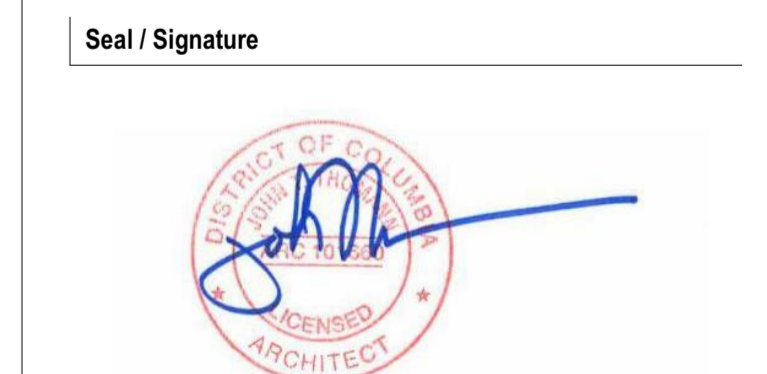

Project Name
FEDERATION OF STATE MEDICAL BOARDS (FSMB)


Project Number
09.8969.000

Description
PROJECT INFO, DRAWING INDEX, VICINITY & LOCATION MAPS, SCOPE, GRAPHIC SYMBOLS & ABBREVIATIONS


Scale
1/4" = 1'-0"

G001

VICINITY MAP

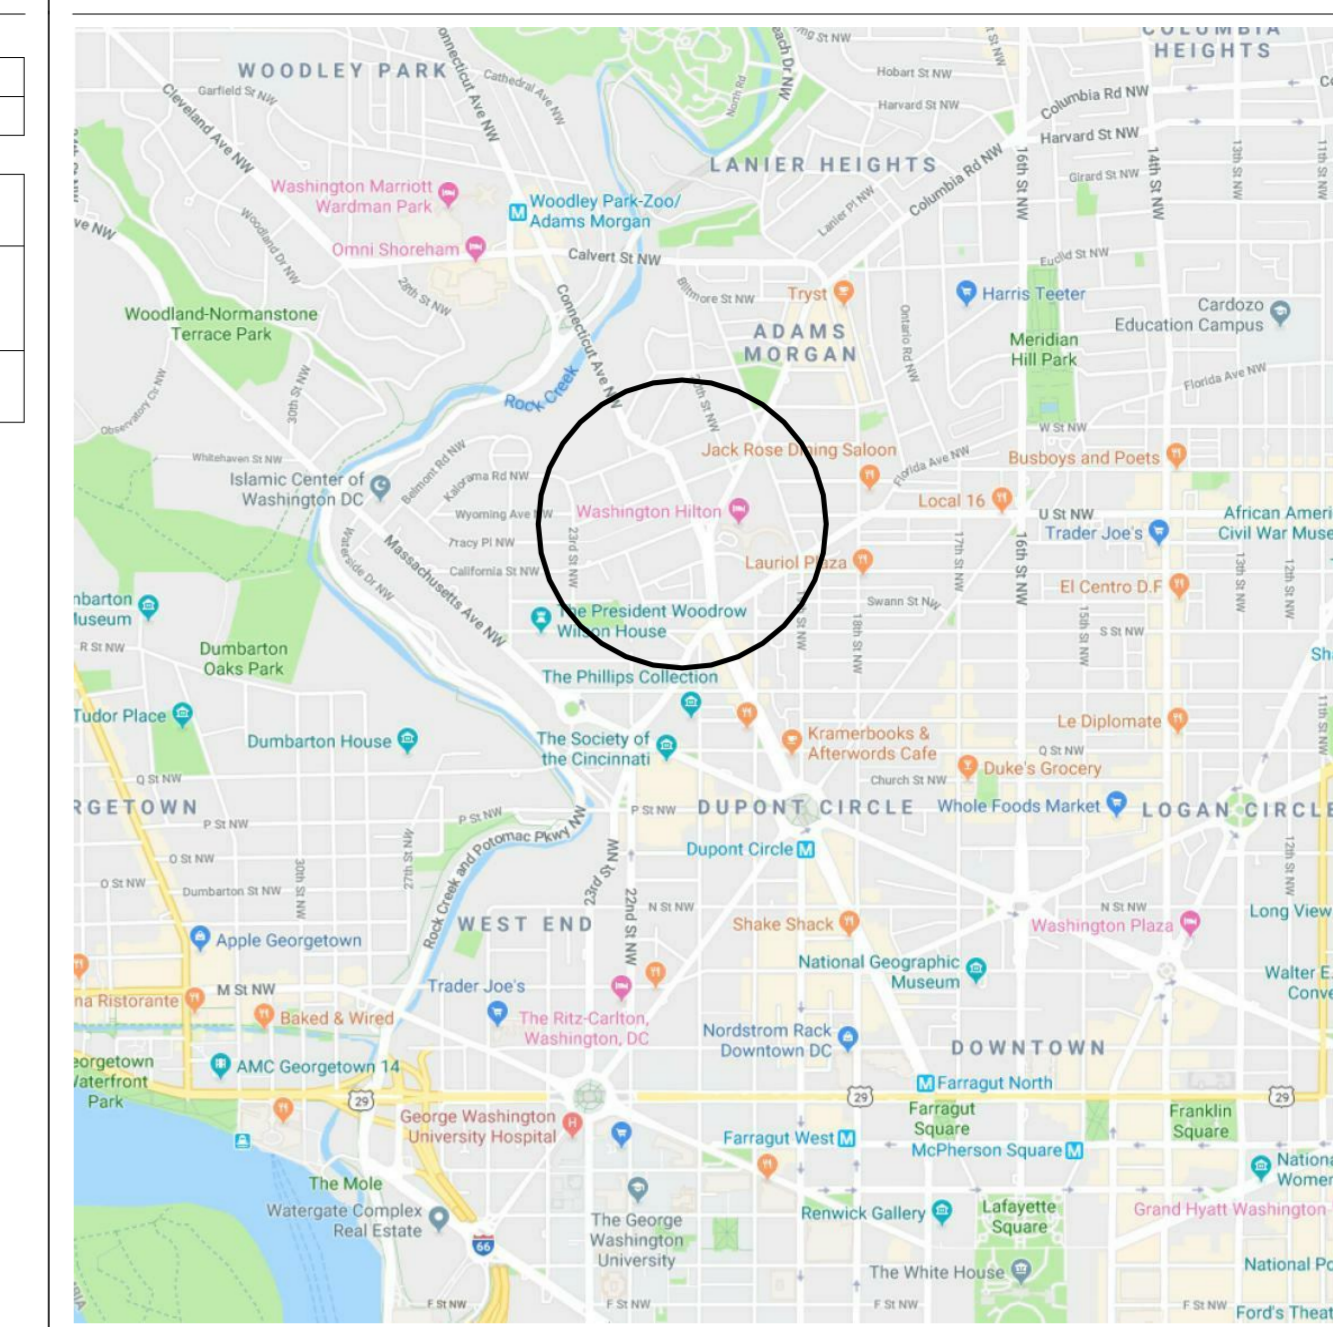

LOCATION MAP

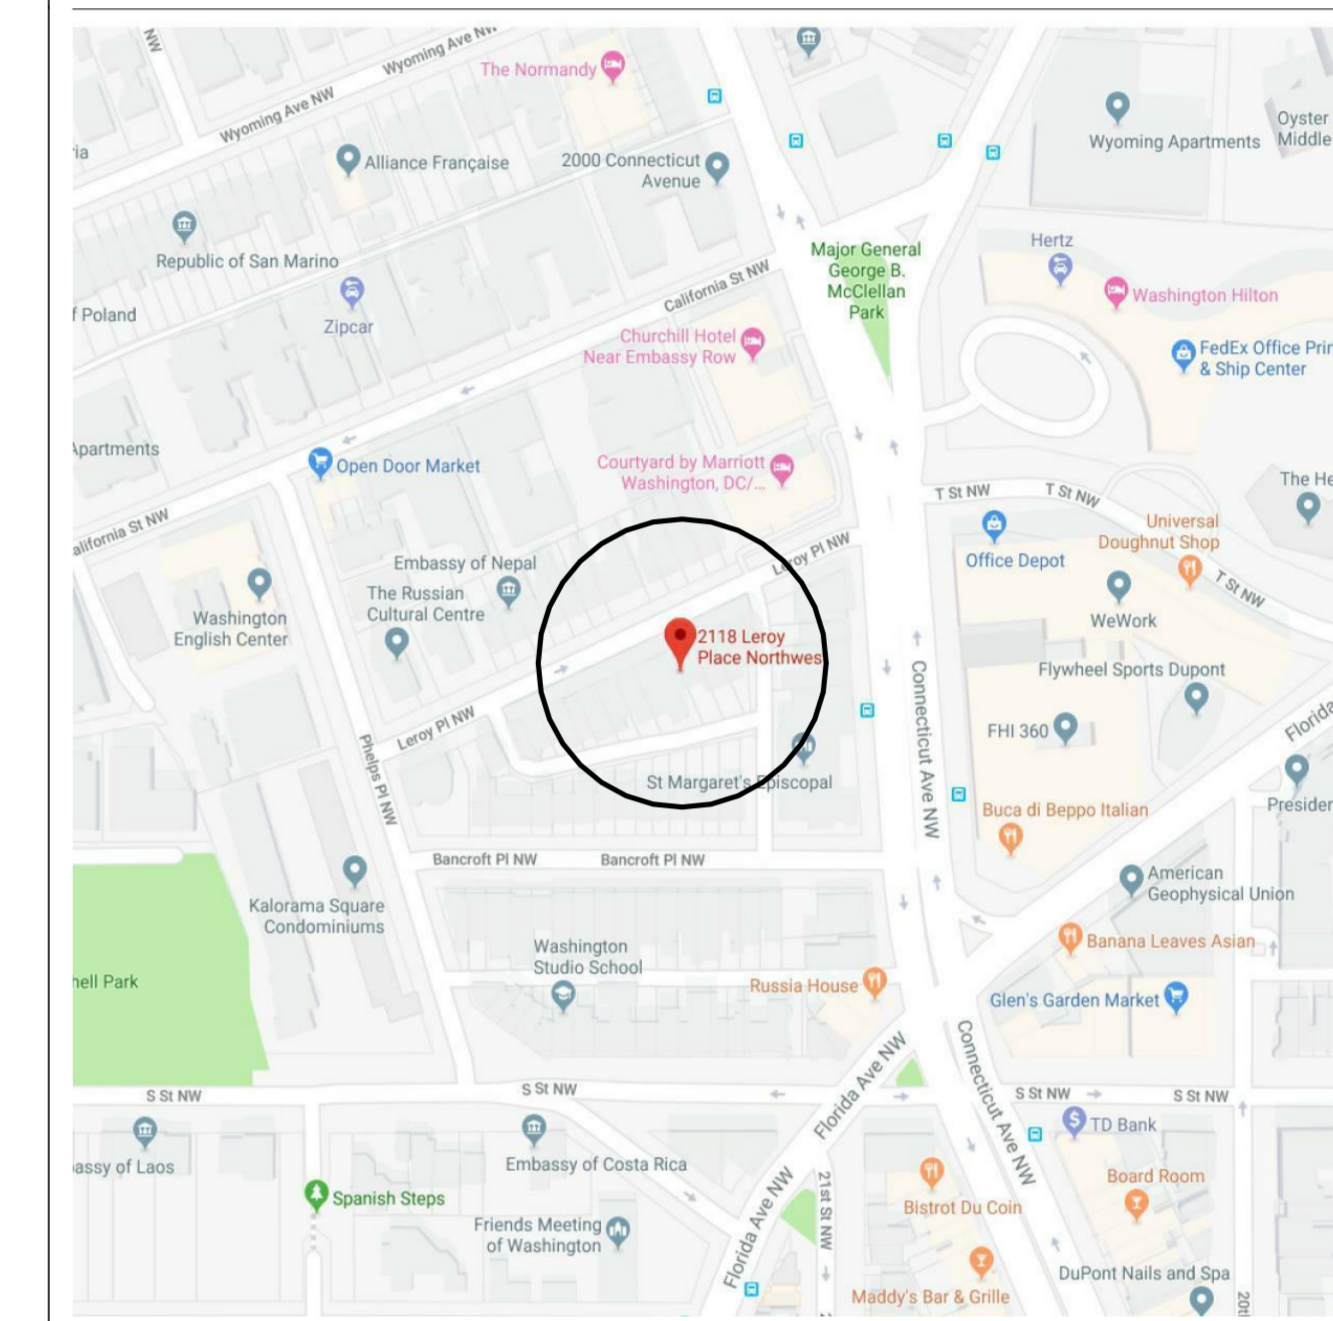

PROJECT INFORMATION

BUILDING ADDRESS: 2118 LEROY PLACE NW
WASHINGTON, DC 20008

OCCUPANCY TYPE: BUSINESS GROUP 'B'

CONSTRUCTION TYPE: TYPE VB

FIRE SUPPRESSION: NONE

FIRE ALARM SYSTEM: NONE

FLOOR AREA: 9,928 GSF

NUMBER OF STORIES: 3 (ABOVE GRADE)
1 (BELOW GRADE)

APPLICABLE CODES: 2013 TITLE 12 DCMR,
DC CONSTRUCTION CODE SUPPLEMENT
2012 ICC EXISTING BUILDING CODE
2012 ICC FUEL GAS CODE
2011 NATIONAL ELECTRICAL CODE
2012 ICC BUILDING CODE
2012 ICC MECHANICAL CODE
2012 ICC PLUMBING CODE
2012 ICC FIRE CODE
2012 ICC ENERGY CONSERVATION CODE
2010 ADAAG / ICC A11.7.2009
2012 ICC GREEN CONSTRUCTION CODE

PROJECT SCOPE

FOLLOWING ARE THE PLANS OUTLINING THE SCOPE OF WORK REQUIRED FOR SELECTIVE DEMOLITION OF EXISTING TENANT IMPROVEMENT CONDITIONS AT 2118 LEROY PLACE NW, WASHINGTON, DC.

THE DRAWINGS, IN CONCERT WITH THE PROJECT MANUAL, COMPRISE THE CONTRACT DOCUMENTS OUTLINING THE INTENT OF THE ARCHITECT, AND MAY BE SUPPLEMENTED BY FURTHER INFORMATION ISSUED BY ARCHITECT.

THE DRAWINGS ARE ARRANGED IN GENERAL TO SPECIFIC ORDER, FOLLOWING A TOP TO BOTTOM, RIGHT TO LEFT FORMAT. CONTRACTORS ARE ADVISED TO READ AND FAMILIARIZE THEMSELVES WITH THE INFORMATION IN THE PROJECT MANUAL, AS WELL AS THE GENERAL LEGENDS CONTAINED IN THE G SERIES OF DRAWINGS, PRIOR TO REVIEW OF THE PLANS, ELEVATIONS AND DETAILS. ADVISE THE ARCHITECT WHERE INTENT IS NOT CLEARLY PERCEIVED, PRIOR TO PROCEEDING WITH WORK.

DRAWING INDEX

Sheet Number	Sheet Name	Revisions		
		Latest	Description	
G000	COVER	1	ISSUE FOR PRECONSTRUCTION DEMOLITION	04/19/19
G001	PROJECT INFO, DRAWING INDEX, VICINITY & LOCATION MAPS, SCOPE, GRAPHIC SYMBOLS & ABBREVIATIONS	1	ISSUE FOR PRECONSTRUCTION DEMOLITION	04/19/19
D100	DEMOLITION PLANS	1	ISSUE FOR PRECONSTRUCTION DEMOLITION	04/19/19

GRAPHIC SYMBOLS

CONSTRUCTION

1 COLUMN GRID REFERENCE NUMBER
COLUMN GRID LINES AND REFERENCE NUMBER

EXISTING CONSTRUCTION TO REMAIN
EXISTING CONSTRUCTION TO BE DEMOLISHED
NEW PARTITION
1 HR. RATED PARTITION
2 HR. RATED PARTITION
3 HR. RATED PARTITION
4 HR. RATED PARTITION
SMOKE PARTITION
EGRESS PATH PRIMARY
EGRESS PATH SECONDARY

MILLWORK
MILLWORK ABOVE

DETAIL NUMBER
SHEET NUMBER
DESCRIPTION OF SIMILAR OR OPPOSITE

AREA TO BE DETAILED

LOCATION ON SHEET WHERE ELEVATION IS SHOWN
DIRECTION OF ELEVATION
SHEET NUMBER WHERE ELEVATION IS SHOWN
INTERIOR AND EXTERIOR ELEVATION MARKER

REVISION REFERENCE NUMBER
REVISION CLOUD DEPICTING AREA REVISED

NAME ROOM NAME
ROOM NUMBER
SHEETNOTE REFERENCE
WALL TYPE REFERENCE
FIRE RATING
DOOR REFERENCE NUMBER (REFER TO DOOR SCHEDULE)
DOOR NUMBER
DOOR TYPE
DOOR NUMBER | HARDWARE TYPE
WINDOW REFERENCE NUMBER (REFER TO WINDOW SCHEDULE)
MILLWORK REFERENCE NUMBER (REFER TO MILLWORK SCHEDULE)
ELEVATION DATUM REFERENCE
FLOOR ELEVATION TRANSITION
MATCH LINE SEE XXXX
ALIGN WITH ESTABLISHED / ADJACENT SURFACES

WALL MOUNTED LIFE SAFETY EQUIPMENT AND DEVICES
FIRE WARDEN STATION SYMBOL
WALL MOUNTED FIRE ALARM STROBE SYMBOL
FIRE ALARM PULL SYMBOL
WALL MOUNTED FIRE EXTINGUISHER CABINET
WALL MOUNTED FIRE EXTINGUISHER
WALL MOUNTED FIRE HOSE CABINET
WALL MOUNTED FIRE VALVE
WALL MOUNTED FIRE VALVE CABINET

FINISH
WALL FINISH TAG
BASE FINISH TAG
EXTENT OF FINISH TYP.
WALL FINISH TAG
SPECIAL FINISH TAG
FLOOR FINISH TAG
CEILING FINISH TAG
CHANGE IN FLOOR FINISH

ELEVATION INDICATION

GLASS SYMBOL
MASONRY COURSING
WOOD VENEER
STONE

GRAPHIC SYMBOLS

SECTION INDICATIONS

ACOUSTICAL CEILING TILE
ALUMINUM
BRICK
CARPET
CONCRETE
CONCRETE MASONRY UNIT
CUT STONE
EARTH
FABRIC WRAPPED PANEL
GLASS
GRAVEL
GYPSUM PLASTER
INSULATION (LOOSE OR BATT)
INSULATION (RIGID)
METAL
PLASTIC
PLYWOOD
PRE-CAST PANELS
SAND OR GROUT
STONE
WOOD (FINISHED)
WOOD (CONTINUOUS MEMBER)
WOOD (INTERRUPTED MEMBER)

REFLECTED CEILING

ACOUSTICAL CEILING AND GRID
CEILING HEIGHT CHANGE SYMBOL
FINISH CEILING HEIGHT SYMBOL
GRID STARTPOINT SYMBOL
CEILING FINISH TAG
MOTION SENSOR
CEILING MOUNTED SPEAKER
CEILING MOUNTED CAMERA
CEILING MOUNTED SPRINKLER HEAD
CEILING MOUNTED SMOKE DETECTOR
CEILING MOUNTED STROBE LIGHT
CEILING MOUNTED EXIT SIGNS
WALL MOUNTED EXIT SIGNS - PARALLEL
WALL MOUNTED EXIT SIGNS - PERPENDICULAR
DENOTES EXISTING TO REMAIN
DENOTES EXISTING TO BE RELOCATED
ACCESS DOOR

LIGHT FIXTURES

FLORESCENT LIGHT FIXTURE
FLORESCENT LIGHT FIXTURE / EMERGENCY CIRCUIT
EXISTING LIGHT FIXTURE TO BE REMOVED
UNDER CABINET FLORESCENT FIXTURE
FLORESCENT STRIP FIXTURE
FLORESCENT PENDANT FIXTURE
RECESSED DOWNLIGHT
RECESSED ADJUSTABLE DOWNLIGHT
RECESSED WALL WASHER
TRACK LIGHTING
SURFACE MOUNTED LIGHT FIXTURE
WALL SCONCE
LIGHT SWITCH
DIMMER SWITCH

MECHANICAL FIXTURES

RETURN AIR
SUPPLY AIR
CIRCULAR DIFFUSER
LINEAR DIFFUSER
EXHAUST FAN

ABBREVIATIONS

INSTRUM	INSTRUMENT(A)TION	&	AND
INSUL	INSULATION	ACCESS	ACCESSORY
INT	INTERIOR	ACOUS	ACOUSTICAL
INTLK	INTERLOCK(ING)	AFF	ABOVE FINISHED FLOOR
JAN	JANITOR	AL	ALUMINUM
		ALT	ALTERNATE
KIT	KITCHEN	ANNUNC	ANNUNCIATOR
		ANOD	ANODIZED
		APPL	APPLIANCE
LAV	LAVATORY	ARCH	ARCHITECTURAL
LB	LOAD	AUTO	AUTOMATIC
LP	LOW POINT	AVG	AVERAGE
LT	LIGHT		
LVLG	LEVELING	BD	BOARD
LVT	LOUVER	BLDG	BUILDING
E	BRITISH POUND (CURRENCY)	BLKG	BLOCKING
		BOLLD	BOLLARD
MAX	MAXIMUM	BRDLM	BROADLOOM
MECH	MECHANICAL	BU	BUILT UP
MEMB	MEMBRANE		
MET	METAL	CAB	CABINET
MEZZ	MEZZANINE	CEM	CEMENT(ITOUS)
MFD	MANUFACTURED	CER	CERAMIC
MFR	MANUFACTURER	CIP	CAST-IN-PLACE
MIN	MINIMUM	CLG	CEILING
MISC	MISCELLANEOUS	CMU	CONCRETE MASONRY UNIT
MLWK	MILLWORK	COATG	COATING
MOIST	MOISTURE	COILG	COILING
MOT	MOTORIZED	CONC	CONCRETE
MTD	MOUNTED	CONSTR	CONSTRUCTION
		CONT	CONTINUOUS(A)TION
NIC	NOT IN CONTRCT	CONTR	CONTRACT(OR)
NO	NUMBER	COV	COVER
NTS	NOT TO SCALE	CPT	CARPET
OPNG	OPENING(S)	\$	DOLLAR (US CURRENCY)
OPR	OPERABLE	DBL	DOUBLE
ORD	OVERFLOW ROOF DRAIN	DEPT	DEPARTMENT
ORNA	ORNAMENTAL	DES	DESIGNED
OVL	OVERFLOW	DET	DETAIL
OVHD	OVERHEAD	DF	DRINKING FOUNTAIN
		DIA	DIAMETER
PBD	PARTICLE BOARD	DIFF	DIFFUSER
PEDR	PEDESTRIAN	DIM	DIMENSION
PLAM	PLASTIC LAMINATE	DISP	DISPENSER
PLAS	PLASTER	DIV	DIVISION
PLSTC	PLASTIC	DN	DOWN
PLYWD	PLYWOOD	DR	DOOR
PNL	PANEL	DSCON	DISCONNECT
POLYST	POLYSTYRENE	DWG	DRAWER
PORT	PORTABLE		
PREFAB	PREFABRICATED	ELAST	ELASTOMERIC
PREFIN	PREFINISHED	ELEC	ELECTRICAL
PRTECN	PROTECTION	EMBED	EMBEDDED(ING)
PTN	PARTITION	ENGR	ENGINEER(ED)
		ENTR	ENTRANCE
RD	ROOF DRAIN	EQ	EQUAL
RDL	ROOF DRAIN LEADER	EQUIP	EQUIPMENT
RDR	READER	EXIST	EXISTING
RECES	RECESSED	EXP JT	EXPANSION JOINT
RECP	RECEPTACLE	EXPS	EXPOSED(D)
REF	REFERENCE(S)	EXT	EXTERIOR
REFL	REFLECTED		
REFR	REFRIGERATOR	FAB	FABRICATION
REINF	REINFORCED(D) (ING) (MENT)	FD	FLOOR DRAIN
REQD	REQUIRED	FE	FIRE EXTINGUISHER
RESIL	RESILIENT	FE&C	FIRE EXTINGUISHER AND CABINET
RESIS	RESISTANT(IVE)	FHC	FIRE HOSE AND CABINET
RFG	ROOFING	FIN	FINISH
RM	ROOM	FLDG	FOLDING
RO	ROUGH OPENING	FLR	FLOORING
		FPLC	FIREPLACE
SCR	SCRIBE	FR	FIRE RAT(ING) (ED)
SECUR	SECURITY	FRMG	FRAMING
SF	SQUARE FEET	FURN	FURNITURE
SG	SINGLE	FWC	FABRIC WALL COVERING
SHORG	SHORING	FXD	FIXED
SIM	SIMILAR	FXTR	FIXTURE
SST	STAINLESS STEEL		
STD	STANDARD	GA	GAUGE
STL	STEEL	GFRG	GLASS FIBER REINFORCED CONCRETE
STRFR	STOREFRONT	GFRG	GLASS FIBER REINFORCED GYPSUM
STRUCT	STRUCTURAL	GFRP	GLAS FIBER REINFORCED PLASTER
SURF	SURFACE	GL	GLASS
SUSP	SUSPENDED	GR	GRADE(ING)
SYS	SYSTEM(S)	GYP	GYPSUM
T&G	TOUNGUE AND GROOVE	HD	HEAD
THK	THICK	HDWD	HARDWOOD
TLT	TOILET	HDWE	HARDWARE
TRAF	TRAFFIC	HM	HOLLOW METAL
TRANS	TRANSPARENT	HORIZ	HORIZONTAL
TRTD	TREATED	HP	HIGH POINT
TYP	TYPICAL	HVAC	HEATING, VENTILATING, AND AIR CONDITIONING
UNDRLAY	UNDERLAYMENT	INFILTR	INFILTRATION
UNO	UNLESS NOTED OTHERWISE	INFO	INFORMATION
UTL	UTILITY		
VEH	VEHICLE		
VERT	VERTICAL		
VIF	VERIFY IN FIELD		
W	WITH		
W/O	WITHOUT		
WC	WATER CLOSET		
WD	WOOD		
WDW	WINDOW		
WT	WEIGHT		
WTRPRF	WATERPROOFING		

These plans are conditionally approved as submitted or noted during plan review and are subject to field inspection. Approved plans must be kept on site and are needed for all inspections. No changes or modifications to these plans. Changes require a revision permit with the revised plans. Trade Permits are required for trade work. e.g. Electrical or Plumbing

HPRB Review - Timothy Dennee - 06-07-2019
Structural Review - Semere Hadera - 06-07-2019


Federation of State Medical Boards (FSMB)
2118 Leroy Place NW
Washington, DC 20008

Gensler

2020 K Street NW
Washington, DC 20006
Tel 202.721.5200

Date	Description
1 04/19/19	ISSUE FOR PRECONSTRUCTION DEMOLITION

Seal / Signature

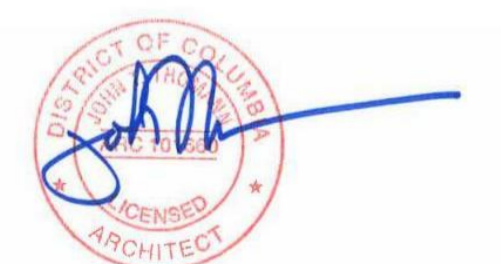

Project Name

FEDERATION OF STATE MEDICAL BOARDS (FSMB)

Project Number

09.8969.000

Description

DEMOLITION PLANS

Scale

As indicated


D100

SHEET NOTES


- RESTROOM TO BE DEMOLISHED. REMOVE ALL RESTROOM FIXTURES, ACCESSORIES AND FINISHES. CAP ALL UTILITY LINES. CAP PIPING AT THE RISER.
- REMOVE ALL BUILT-IN SHELVES, WOOD PANELING AND ALL FINISHES DOWN TO EXPOSED BRICK STRUCTURE.
- EXISTING CHIMNEY AND HEARTH TO REMAIN. REMOVE ALL FINISHES DOWN TO BARE STRUCTURE.
- EXISTING WINDOW AND FRAME TO REMAIN. REMOVE ALL WINDOW TREATMENTS AND ADJACENT FINISHES.
- REMOVE ALL WALL FINISHES DOWN TO BARE STRUCTURE. REMOVE DOORS, WHEN SHOWN AS DEMOLISHED LINES.
- EXISTING WINDOW AND FRAME TO BE REMOVED. OPENING TO BE BRACED AS NEEDED UNTIL NEW IN-CELL WORK.
- REMOVE ALL MILLWORK AND SINK. CAP ALL UTILITY LINES.
- EXISTING STAIR & RAILING TO REMAIN. PROTECT DURING DEMOLITION. REMOVE ALL TREAD AND RISER FINISHES DOWN TO SUBFLOOR. REMOVE ALL WALL FINISHES INCLUDING ANY PLASTER/DRYWALL FROM ALL ADJACENT WALLS SHOWN TO BE DEMOLISHED. ONCE ALL FRAMING IS EXPOSED NOTIFY ARCHITECT AND STRUCTURAL ENGINEER FOR REVIEW OF STRUCTURAL INTEGRITY PRIOR TO WALL DEMOLITION.
- REMOVE ALL FINISHES DOWN STRUCTURAL COMPONENTS, WHERE EXISTING.
- REMOVE ALL NON STRUCTURAL WALLS WITHIN ROOM. BUILT-INS AND FINISHES. NOTIFY ARCHITECT & OWNER IF ANY STRUCTURAL BEARING WALLS ARE EXPOSED.
- CLEAN OUT CRAWL SPACE DOWN TO BARE STRUCTURE.
- REMOVE ALL WALL FINISHES, INCLUDING PLASTER, DOWN TO BARE FRAMING. ONCE STRUCTURE IS EXPOSED, CONTACT ARCHITECT AND STRUCTURAL ENGINEER FOR REVIEW TO DETERMINE IF WALLS ARE LOAD BEARING.
- CAREFULLY REMOVE ALL MARBLE WAINSCOT. STORE ON SITE FOR FUTURE USE.

GENERAL NOTES


- WALL LAYOUT SHOWN ON DRAWINGS IS DERIVED FROM DRAWINGS PROVIDED BY THE OWNER AND NOT BASED ON AN ACCURATE FIELD SURVEY BUT IT IS INTENDED TO BE A GENERAL REPRESENTATION OF THE DEMOLITION REQUIRED AND MAY VARY FROM EXISTING CONDITIONS.
- CONTRACTOR SHALL VISIT THE SITE AND EXAMINE DEMOLITION DOCUMENTS PRIOR TO SUBMISSION OF BIDS. CONTRACTOR SHALL IDENTIFY TO THE ARCHITECT OBSERVED FAULTS OR AMBIGUITY IN THE DEMOLITION DOCUMENTS, AND PROVIDE OPPORTUNITY FOR RESOLUTION PRIOR TO SUBMISSION OF BIDS. SUBMISSION OF BID CONSTITUTES CONTRACTOR'S ACKNOWLEDGMENT OF ACCEPTANCE OF THE DEMOLITION DOCUMENTS AS AN ADEQUATE DEFINITION OF SCOPE OF WORK. CONTRACTOR'S EXTRA COST CLAIMS BASED ON INADEQUACY OF DEMOLITION DOCUMENTS SHALL NOT BE CONSIDERED OR ACCEPTED.
- U.N.O. REMOVE ALL CEILING SYSTEMS (EG: ACOUSTICAL TILE CEILINGS AND GRID, PLASTER CEILING, AND STICK ON CEILING TILES) BULBS AND WINDOW BLINDS. REMOVE ALL LIGHT FIXTURES AND WIRING BACK TO ELECTRICAL PANEL. REMOVE ALL INSULATING MATERIAL BETWEEN THE EXISTING JOISTS.
- REMOVE ALL EXISTING INTERIOR WALL FINISHES, INCLUDING WOOD PANELING AND PLASTER FINISH AT ALL WALLS NOTED TO REMAIN.
- REMOVE ALL DISTRIBUTION DUCTS BETWEEN DROP ACOUSTICAL CEILINGS AND PLASTER CEILINGS. LEAVE ALL AC UNITS IN PLACE.
- CONTRACTOR SHALL ENSURE UNINTERRUPTED ACCESS TO FIRE EXITS DURING DEMOLITION.
- REMOVE ALL FLOORING MATERIAL DOWN TO SUB FLOOR OR SLAB.
- DEMOLISH ALL LOW VOLTAGE WIRING BACK TO THE 1' MARK OF INCOMING PHONE SERVICE.
- REMOVE ALL ELECTRICAL WIRING IN WALLS. DEMOLISH BACK TO THE ELECTRICAL PANEL.
- WHERE EXISTING WORK SHALL BE CUT, DRILLED, ALTERED, REMOVED OR TEMPORARILY REMOVED AND REPLACED FOR PERFORMANCE OF WORK UNDER THE CONTRACT, WORK REPLACED SHALL MATCH SIMILAR EXISTING WORK. STRUCTURAL MEMBERS OF WOOD, CONCRETE OR STRUCTURAL STEEL SHALL NOT BE CUT OR ALTERED EXCEPT AS SHOWN, WITHOUT AUTHORIZATION OF THE OWNER. WORK REMAINING IN PLACE BUT DAMAGED OR DEFACED DURING THIS CONTRACT SHALL BE RESTORED TO THE CONDITION AT TIME OF AWARD OF CONTRACT.
- CONTRACTOR SHALL COORDINATE DEMOLITION WORK WITH EXISTING CONDITIONS OF ALL TRADES, BOTH ABOVE CEILING AND BELOW FLOOR/GRADE.
- THE CONTRACTOR SHALL PERFORM DEMOLITION BASED ON THE ACTUAL INSTALLED SYSTEMS. THE CONTRACTOR SHALL BE RESPONSIBLE TO INSPECT THE FACILITY TO ESTABLISH THE CURRENT ITEMS OF EQUIPMENT AND DISTRIBUTION SYSTEMS.
- DAMAGES CAUSED BY THE DEMOLITION TO EXISTING CONDITIONS, EQUIPMENT, OR APPARATUS DURING THE EXECUTION OF THIS CONTRACT AND INDICATED TO REMAIN SHALL BE REPAIRED/REPLACED TO MATCH ORIGINAL CONDITION AT NO ADDITIONAL COST TO OWNER.
- CONTRACTOR SHALL SALVAGE SPECIFIC MATERIALS AND EQUIPMENT IDENTIFIED AND WHEN SO DIRECTED BY THE OWNER, ARCHITECT, ENGINEER, AND/OR DEMOLITION DOCUMENTS.
- CONTRACTOR SHALL THOROUGHLY CLEAN WORK AREA DAILY AND REMOVE TRASH AND DEBRIS FROM SITE AFTER COMPLETION OF THE CONTRACT.
- CONTRACTOR TO NOTIFY OWNER OF ANY MATERIALS SUSPECTED TO BE HAZARDOUS.
- EXISTING WORK TO REMAIN SHALL BE PROTECTED FROM DAMAGE. WORK DAMAGED BY THE CONTRACTOR SHALL BE REPLACED TO MATCH EXISTING WORK OR AS REQUIRED TO ACCOMMODATE NEW WORK INSTALLED UNDER THIS CONTRACT.
- THE DEMOLITION PROCEDURES SHALL PROVIDE FOR SAFE CONDUCT OF THE WORK, PROTECTION OF PERSONNEL, CAREFUL REMOVAL AND DISPOSITION OF MATERIALS SPECIFIED TO BE SALVAGED. PROTECTION OF PROPERTY TO REMAIN UNDISTURBED. COORDINATION WITH OTHER WORK IN PROGRESS, AND TIMELY DISCONNECTION OF UTILITY SERVICES OR AS DESCRIBED HEREIN.
- NOTIFY ARCHITECT & OWNER IF ANY WALL SHOWN TO BE DEMOLISH

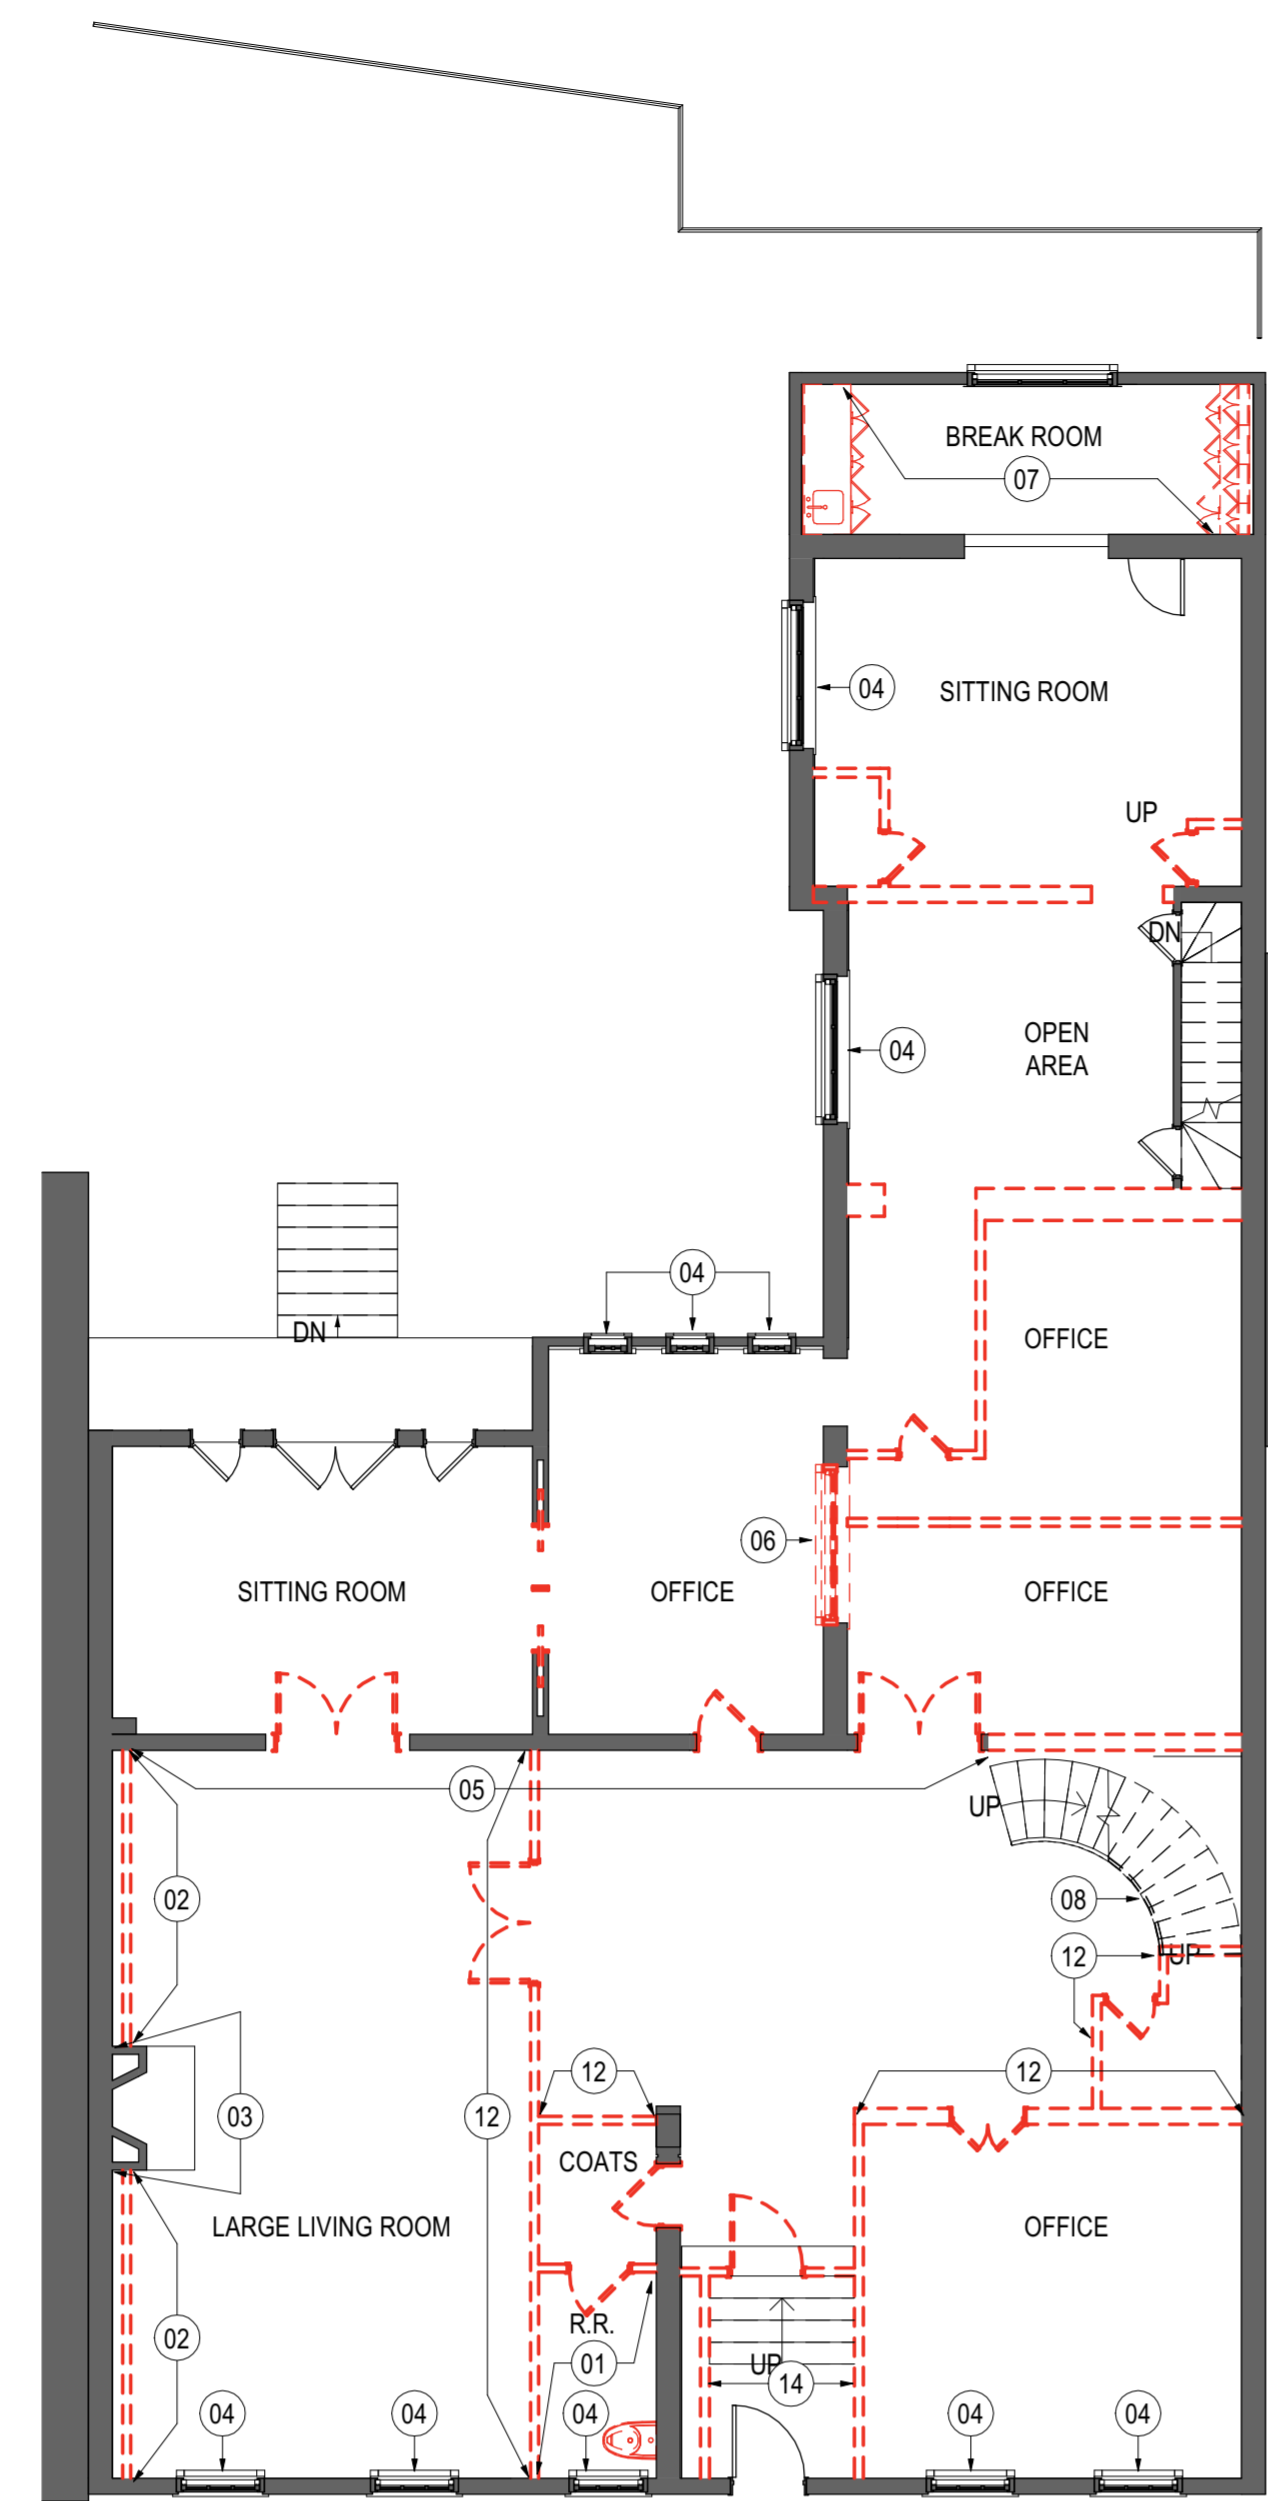


02 DEMOLITION PLAN - LEVEL 01
SCALE: 1/8" = 1'-0"

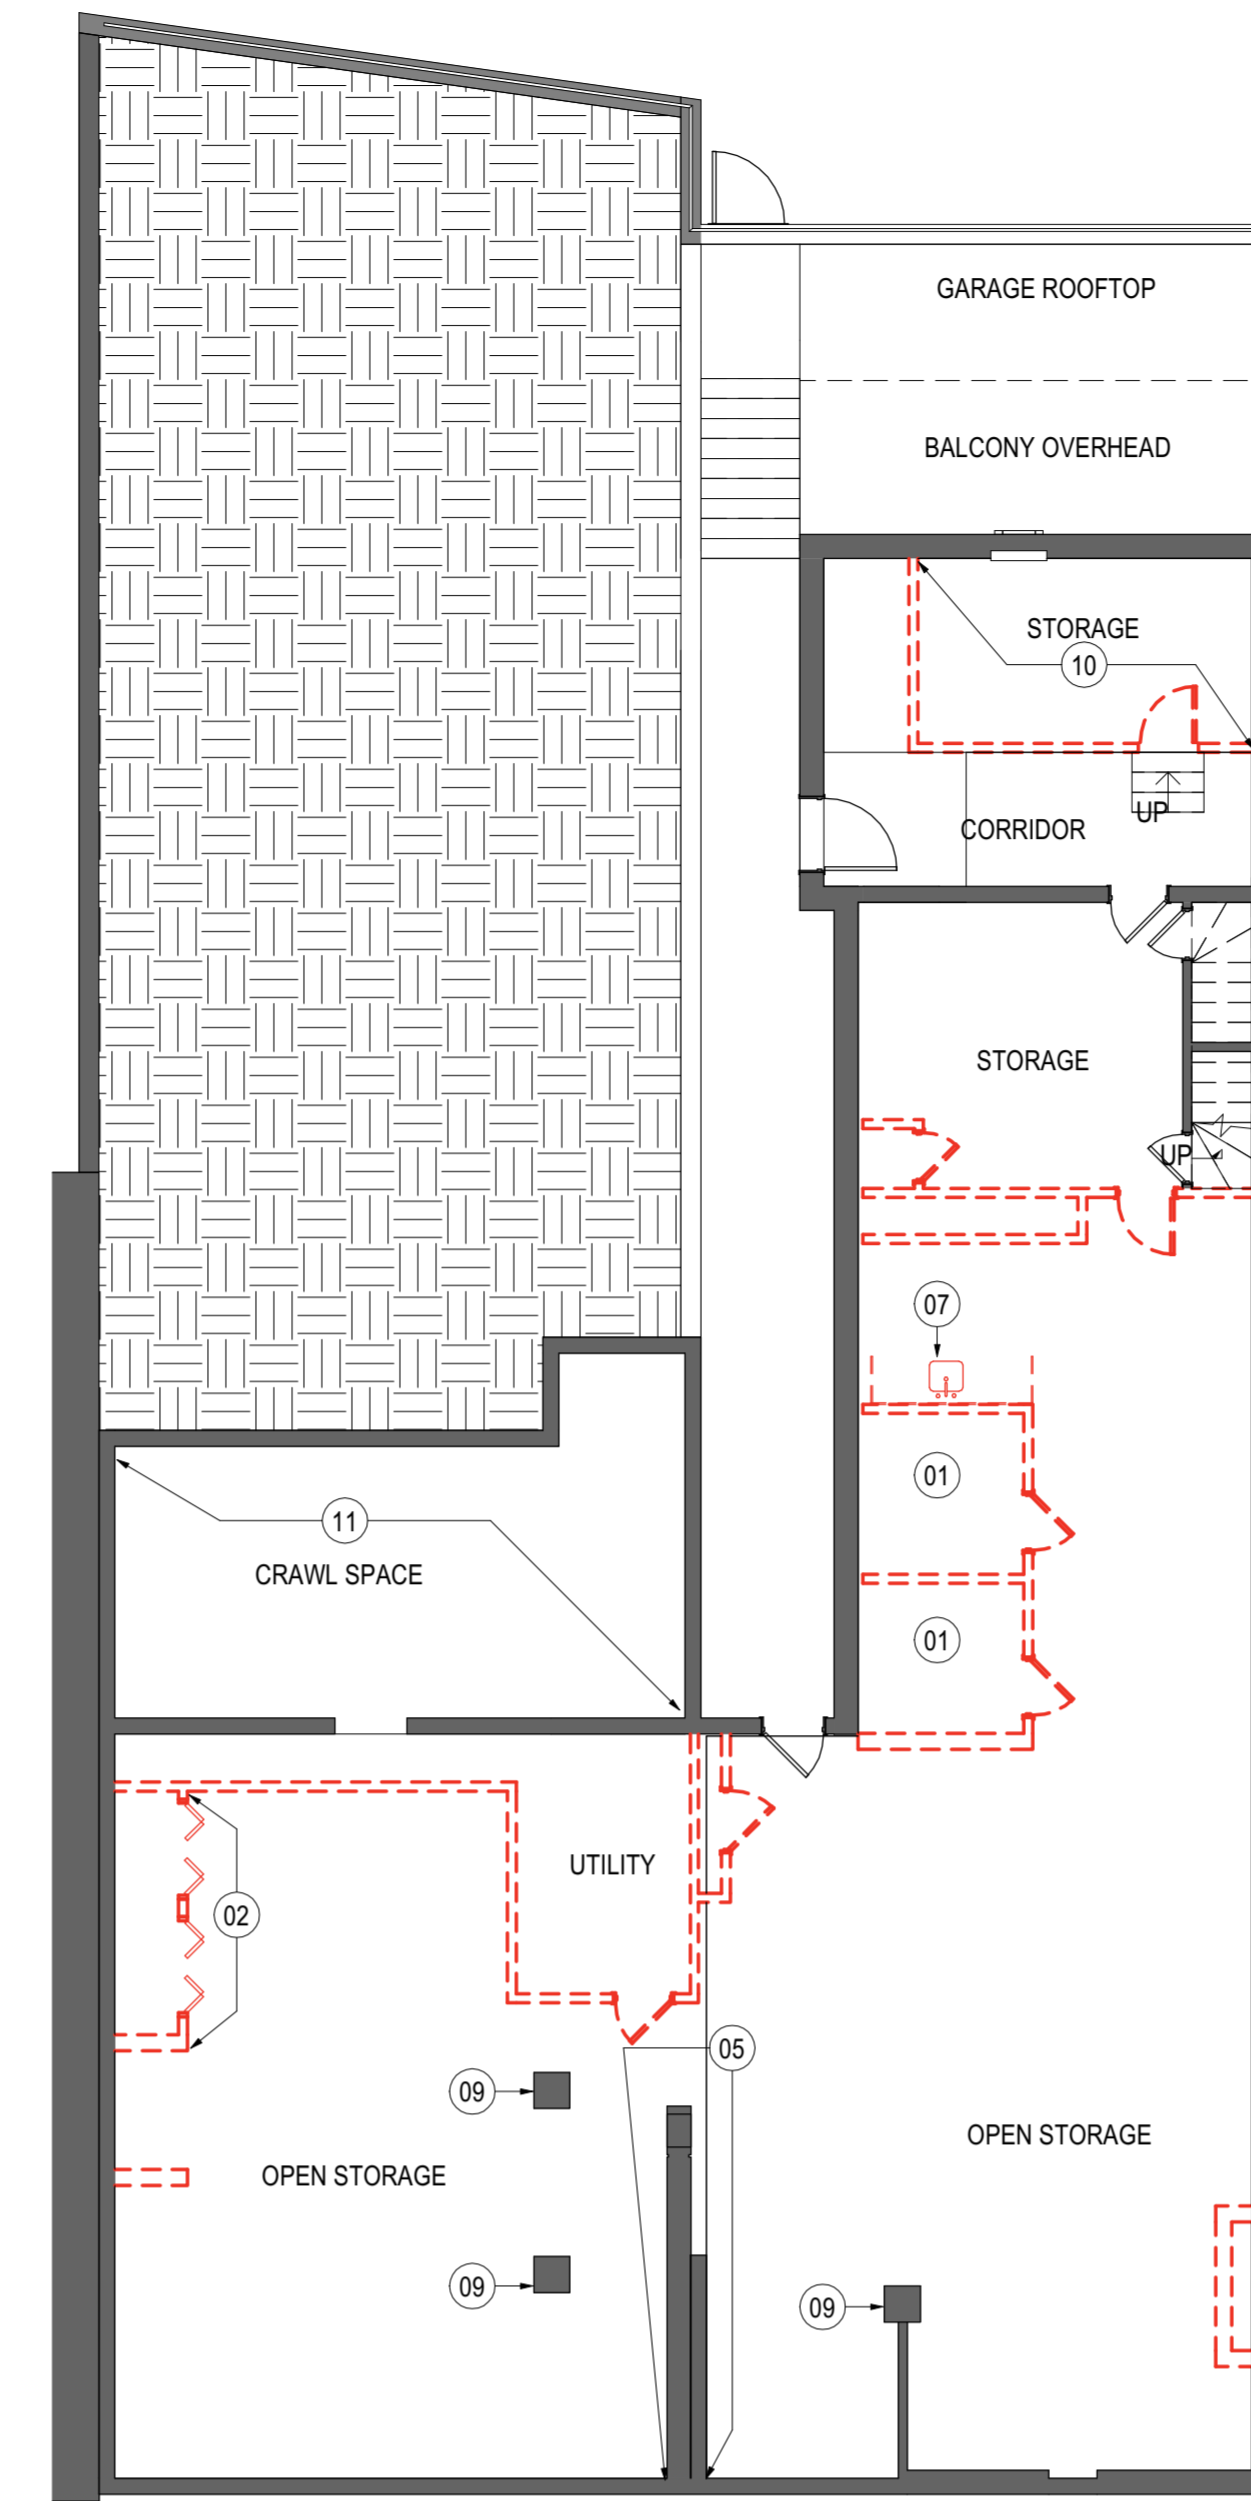


01 DEMOLITION PLAN - LOWER LEVEL
SCALE: 1/8" = 1'-0"

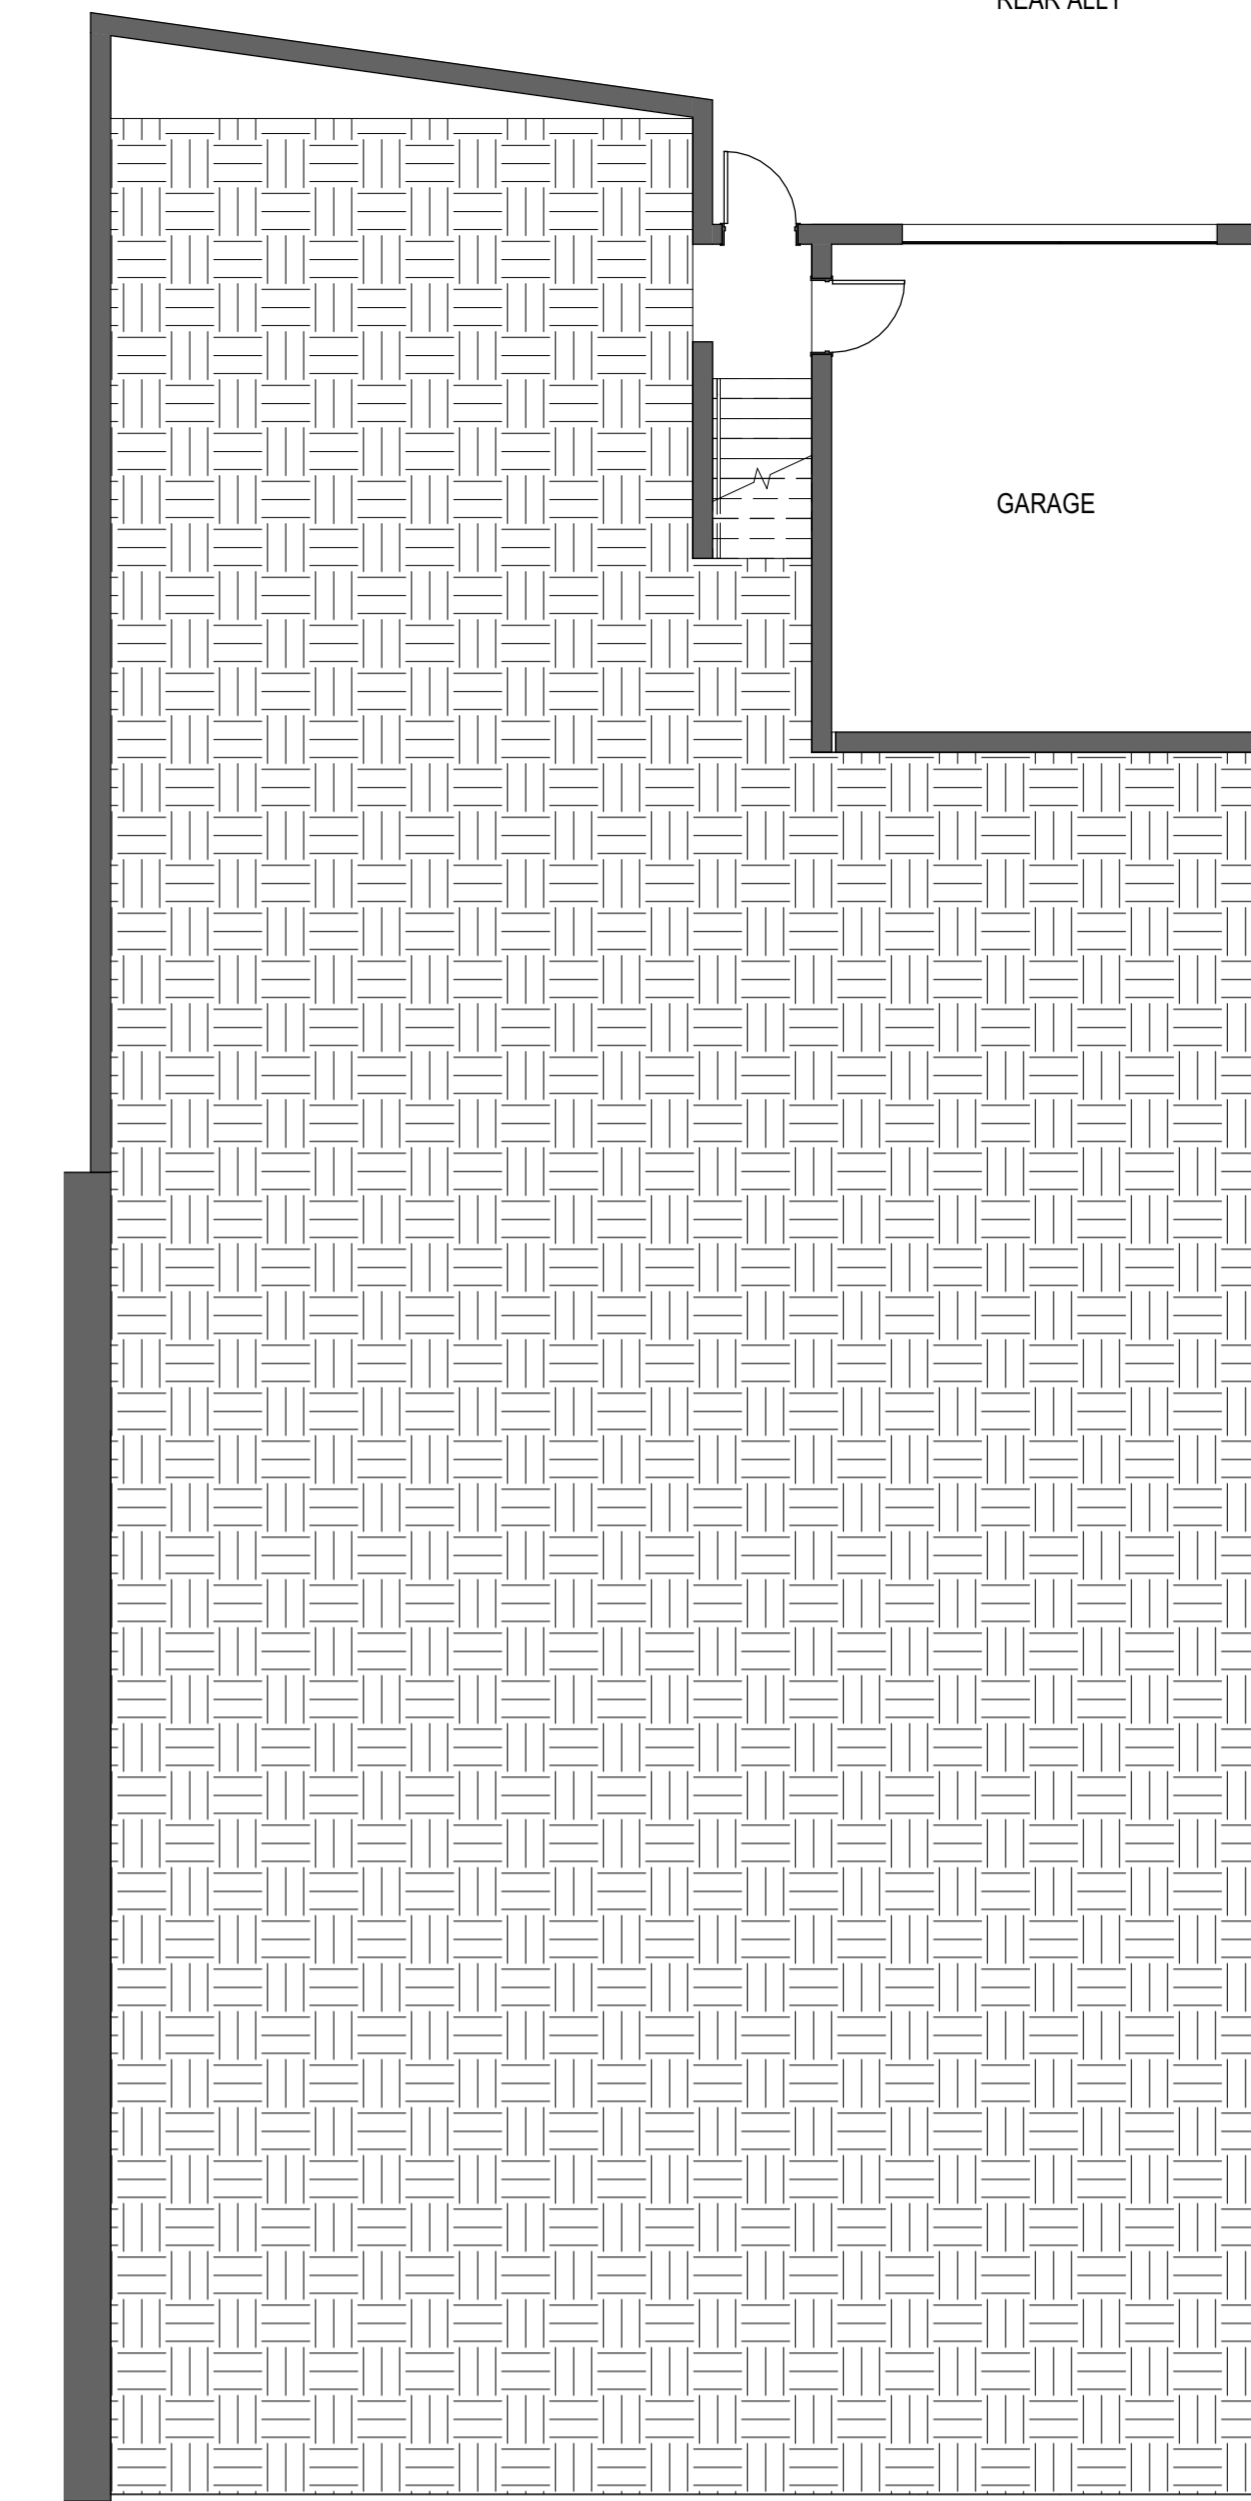

6 DEMOLITION PLAN - GARAGE LEVEL
SCALE: 1/8" = 1'-0"

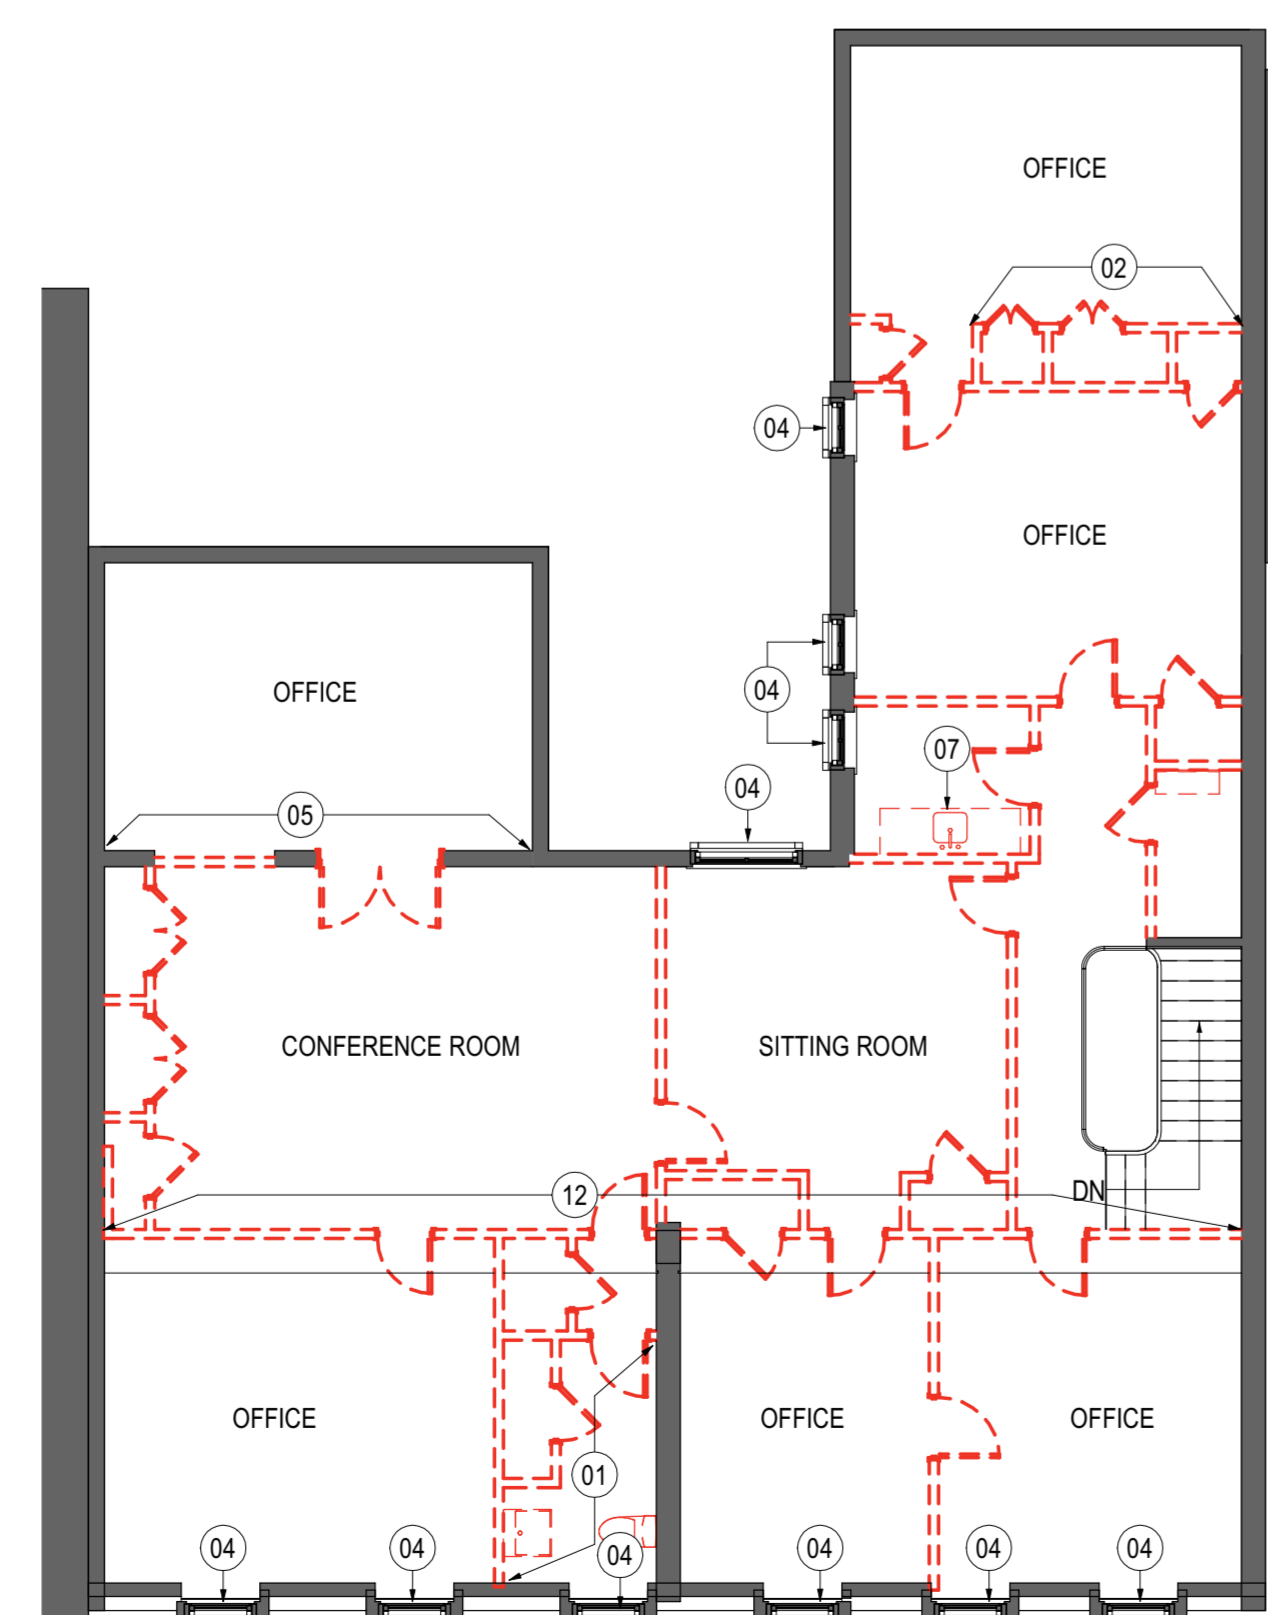

04 DEMOLITION PLAN - LEVEL 03
SCALE: 1/8" = 1'-0"

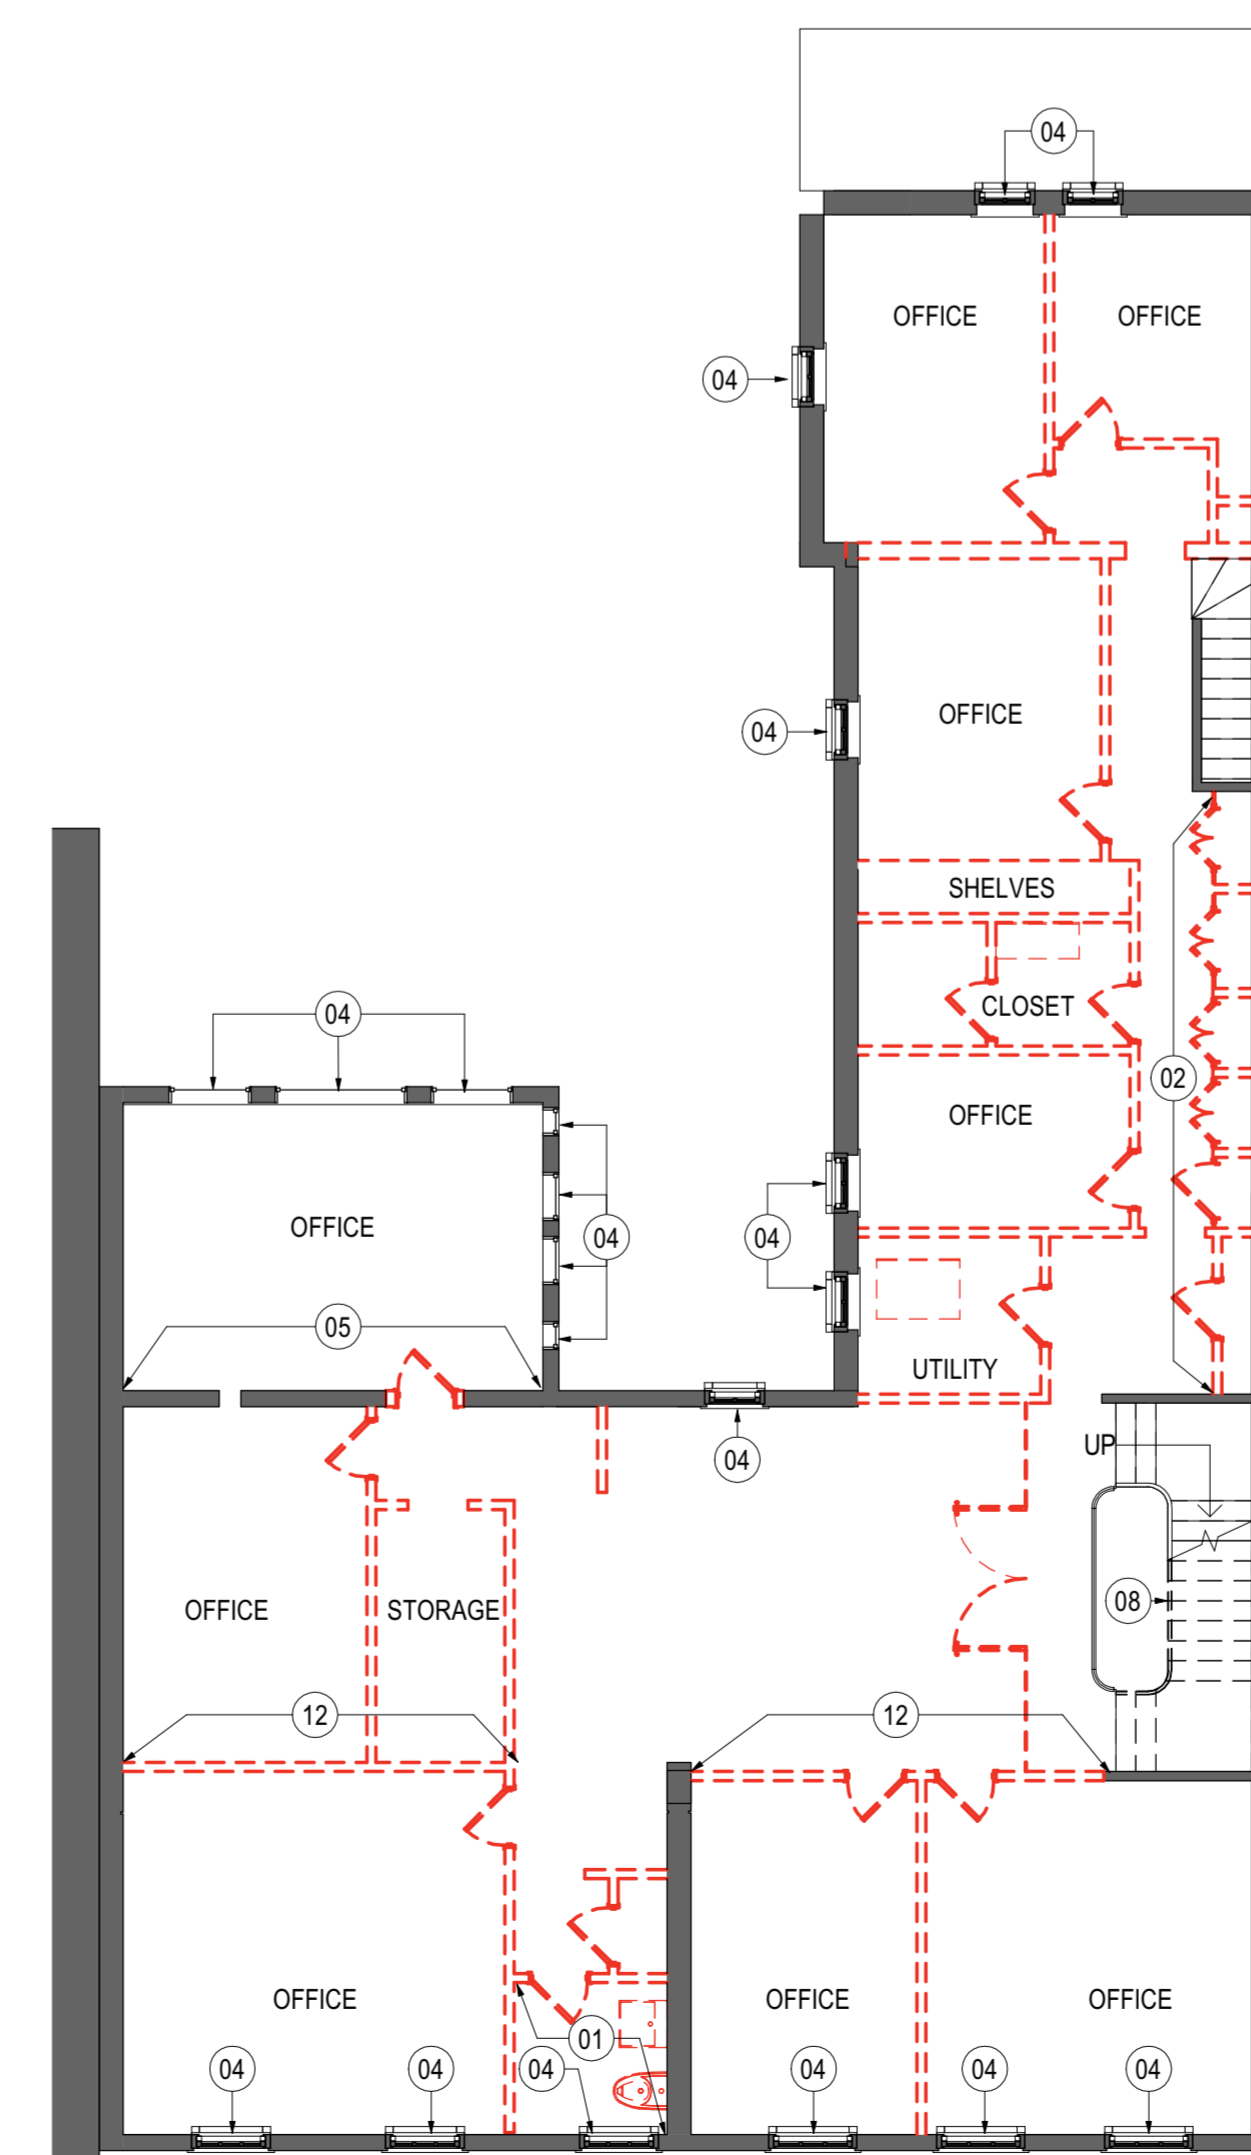

03 DEMOLITION PLAN - LEVEL 02
SCALE: 1/8" = 1'-0"

05 DEMOLITION LEGEND
SCALE: 1/4" = 1'-0"

- EXISTING PARTITION WALL TO REMAIN
- EXISTING STAIR OR SITEWORK TO REMAIN
- EXISTING PARTITION WALL TO BE DEMOLISHED