
BZA APPLICATION SITE PLAN SAINT PAUL'S TOWNHOUSE PARCEL

PART OF LOT 1067 (WHICH IS PART OF LOT 915), SQUARE 3648; WASHINGTON, DC

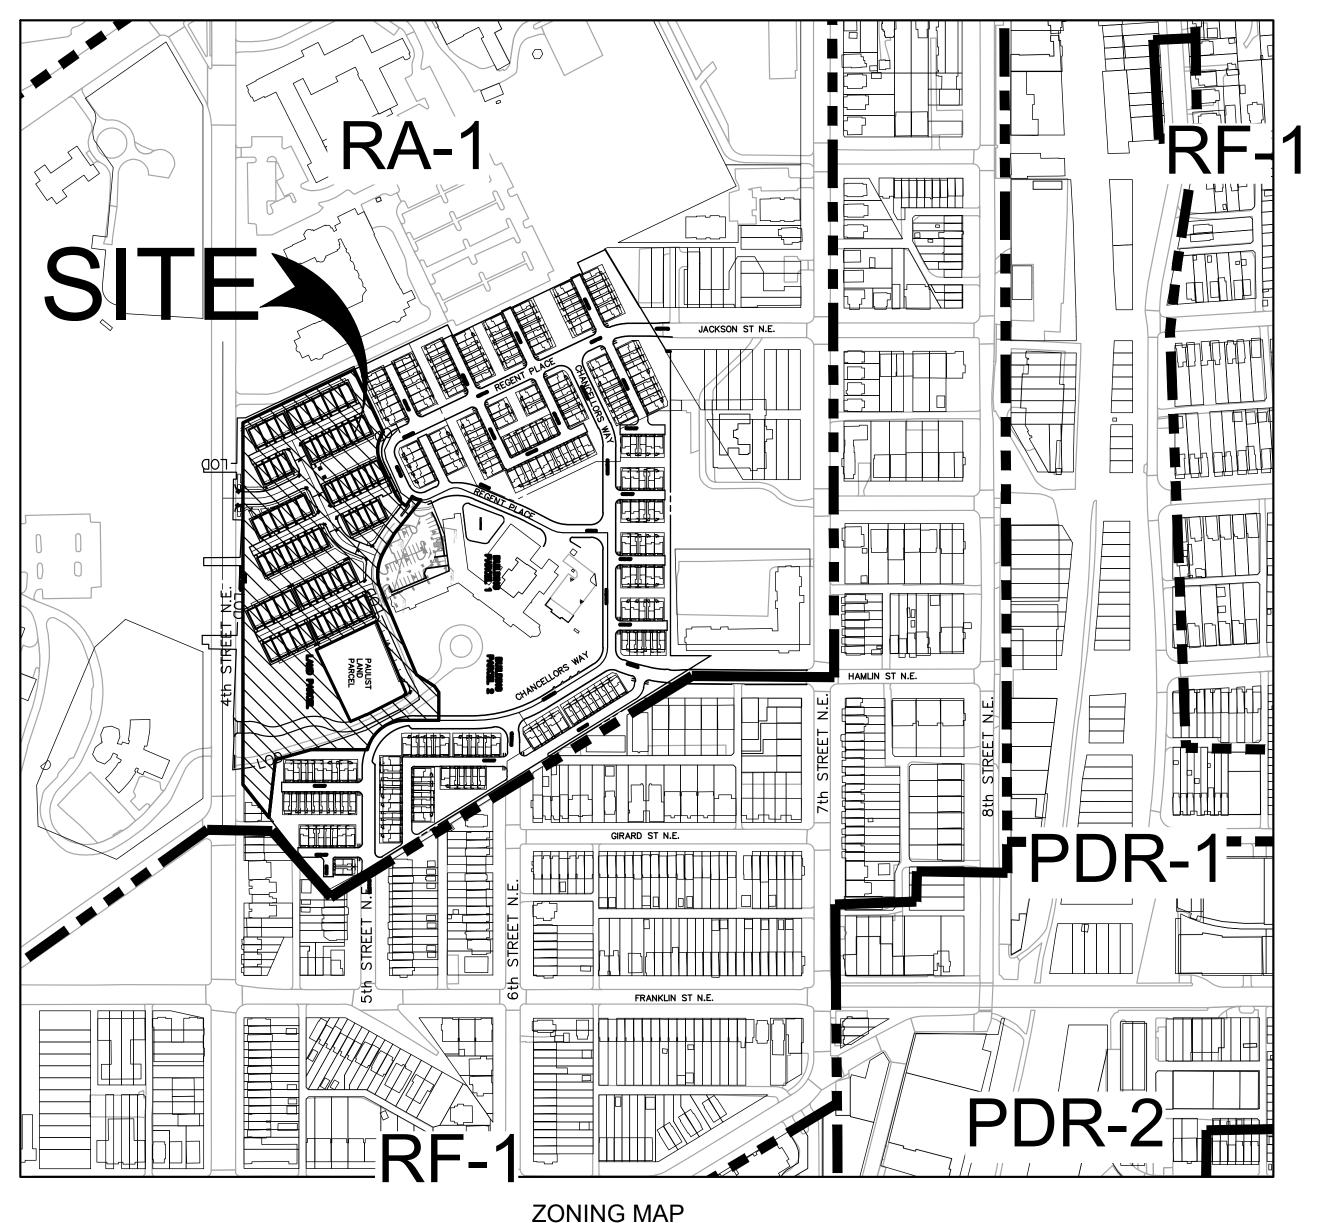

SCALE: 1" = 200'



VICINITY MAP SCALE: 1" = 200'

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BOUNDARY INFORMATION SHOWN HEREON WAS OBTAINED FROM OFFICIAL CITY RECORDS AND VERIFIED IN THE FIELD INSOFAR AS POSSIBLE. PROPERTY LINE DIMENSIONS FROM OFFICIAL RECORDS MAY NOT NECESSARILY AGREE WITH ACTUAL MEASURED DIMENSIONS. ALL PROPERTY LINES IN THE DISTRICT OF COLUMBIA ARE SUBJECT TO CHANGE WITH THE FINAL DETERMINATION TO BE MADE BY THE OFFICE OF THE SURVEYOR FOR THE DISTRICT OF COLUMBIA. A "SURVEY TO MARK" PREPARED BY DISTRICT OF COLUMBIA REGISTERED LAND SURVEYOR AND VERIFIED BY THE OFFICE OF THE SURVEYOR MAY BE REQUIRED TO ESTABLISH A FINAL BOUNDARY DETERMINATION AND CONFIGURATION FOR THIS PROPERTY.

NOTE:

ALL SITE PLANS AND LANDSCAPE PLANS ARE SUBJECT TO REVISION. THE DEVELOPER RESERVES THE RIGHT TO MAKE CHANGES WITHOUT NOTICE, IN ELEVATIONS, DIMENSIONS, CONTOURS, ETC., INCLUDING THE SIZING, LOCATION, CREATION, OR ELIMINATION OF ANY PATIO, DECK, RETAINING WALL, OR OTHER LOT FEATURES. WHEN REQUIRED, APPROVAL OF ANY REVISION TO SITE AND LANDSCAPE PLANS WILL BE OBTAINED FROM THE APPROPRIATE LOCAL JURISDICTION.

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DEVELOPMENT, INC.

175 Admiral Cochrane Dr.

PROFESSIONAL SEAL

I HEREBY CERTIFY THAT THESE DOCUMENTS WERE PREPARED OR APPROVED BY ME, AND THAT I AM A DULY LICENSED PROFESSIONAL ENGINEER UNDER THE LAWS OF THE DISTRICT OF COLUMBIA.

JEFFREY B. AMATEAU LICENSE No. 905527 EXPIRATION DATE JULY 14, 2018

ST. PAUL'S **TOWNHOUSE PARCEL**

PART OF LOT 1067 PART OF LOT 915 SQUARE 3648 3015 4th STREET N.E. WASHINGTON, D.C.

COVER SHEET

DRAWN BY: <u>CAD</u> DESIGNED BY: <u>LK</u> DATE ISSUED: SEPT. 2016

PROJECT VM1453 G

CASE NO 19877 SHEET NO.



LAYOUT: COVER SHEET, Plotted By: kelso

SCALE: 1" = 200'

<u>LEGEND</u> PROPOSED (NEW) STORM SEWER **→** 10"S SANITARY SEWER 8"W WATER MAIN UNDERGROUND TELEPHONE LINE UNDERGROUND ELECTRICAL LINE UNDERGROUND TV CABLE OVERHEAD TELEPHONE OVERHEAD WIRES OVERHEAD ELECTRIC —— 22———— INTERMEDIATE CONTOUR PROP EP EDGE OF PAVEMENT CENTERLINE WATER SURFACE CONDUIT DOOR ENTRANCE/EXIT uuuuuu RETAINING WALL ON-SITE SHEET DELINEATION OFF-SITE SHEET DELINEATION BM #1 TRV #1 ELEV=101.62 BENCHMARK STORM DRAIN MANHOLE OTHERWISE SPECIFIED IN THE CONTRACT DOCUMENTS. STORM DRAIN STRUCTURE LOCATION OF UNDERDRAINS, AND LOCATION OF MECHANICAL EQUIPMENT AND CONNECTIONS AT THE FACES OF BUILDINGS. STORM DRAIN STRUCTURE LBL SANITARY MANHOLE SANITARY STRUCTURE LBL SANITARY CLEANOUT WATER MANHOLE FIRE HYDRANT FIRE DEPARTMENT CONNECTION VALVE WATER SERVICE METER REDUCER BENDS TEL MANHOLE ELEC TRANSFORMER ELEC MANHOLE CABLE PEDESTAL TEL PEDESTAL STREET LIGHT UTILITY POLE □ OR ○ OVERHEAD WIRE —₩— GAS MANHOLE © OR G GAS VALVE SPOT ELEVATION 00.00 OR 00.0 SOIL BORING AIR/DRAIN BLOW-OFF (WASA STD.W-50.10) 'FOR LOCATION OF UTILITIES CALL 8-1-1 or 1-800-257-7777 OR LOG ON TO www.call811.com or http://www.missutility.ne 48 HOURS IN ADVANCE OF ANY WORK IN THIS VICINITY" The excavator must notify all public utility companies with undergroun facilities in the area of proposed excavation and have those facilities

- GENERAL CONSTRUCTION AND COORDINATION NOTES
 - THE CONTRACTOR SHALL NOTIFY "MISS UTILITY" AT 1-800-257-7777 48 HOURS PRIOR TO THE START OF EXCAVATION FOR THE MARKING OF UNDERGROUND UTILITIES.
 - CONSTRUCTION OF THESE PLANS SHALL BE IN ACCORDANCE WITH ALL APPLICABLE DCDOT STANDARDS, ALL PERMIT CONDITIONS, AND 39. THE CONTRACTOR IS TO VERIFY THAT ALL UTILITIES ARE IN PLACE PRIOR TO THE PLACEMENT OF SUB BASE AND / OR PAVING SPECIFICATIONS AS WELL AS ALL DDOF AND DOWATER STANDARDS FOR UTILITY CONSTRUCTION. ANY DEVIATION FROM THESE PLANS SHALL BE APPROVED BY THE OWNER AND THE APPROPRIATE INSPECTOR PRIOR TO BEGINNING THE CONSTRUCTION.
 - 3. IF VIKA HAS NOT BEEN ENGAGED TO PROVIDE STAKEOUT SERVICES, THE CONTRACTOR SHALL ESTABLISH AND CHECK ALL HORIZONTAL AND VERTICAL CONTROLS TO BE USED WITH THIS PROJECT. IN ADDITION, THE CONTRACTOR SHALL COMPUTE THE LAYOUT OF THE ENTIRE SITE PLAN IN ADVANCE OF BEGINNING ANY WORK ASSOCIATED WITH THE SUBJECT PLANS AND SUBMIT A STAKEOUT SHEET TO THE OWNER/DEVELOPER AND VIKA.
 - 4. CONSTRUCTION STAKEOUT SHALL BE UNDER THE SUPERVISION OF A LICENSED LAND SURVEYOR.
 - 5. THE CONTRACTOR SHALL NOT RELY SOLELY ON ELECTRONIC VERSIONS OF PLANS, SPECIFICATIONS, AND DATA FILES THAT ARE OBTAINED FROM THE DESIGNERS. BUT SHALL VERIFY LOCATION OF PROJECT FEATURES AND DIMENSIONS IN ACCORDANCE WITH THE PAPER COPIES OF THE PLANS AND SPECIFICATIONS THAT ARE SUPPLIED AS PART OF THE CONTRACT DOCUMENTS.
 - 6. THE CONTRACTOR SHALL BE RESPONSIBLE TO VERIFY EXISTING TOPOGRAPHIC CONDITIONS INDICATED ON THESE PLANS AND CONTRACT DOCUMENTS PRIOR TO BEGINNING ANY LAND DISTURBANCE WORK ON THE PROJECT. ONCE LAND DISTURBANCE HAS COMMENCED. THE CONTRACTOR SHALL HAVE NO CLAIMS AS TO EXISTING TOPOGRAPHY NOT MEETING MINIMUM SURVEY STANDARDS AND SHALL ACCEPT ALL EXISTING TOPOGRAPHIC CONDITIONS AS BEING WITHIN UNITED STATES NATIONAL MAP ACCURACY STANDARDS FOR CONSTRUCTION CONTRACT PURPOSES. IF THE CONTRACTOR FINDS A DISCREPANCY IN TOPOGRAPHIC INFORMATION, HE/SHE SHALL NOTIFY VIKA AND THE OWNER PRIOR TO PERFORMING ANY LAND DISTURBING ACTIVITY SO THE AREA CAN BE RESURVEYED IN AN UNDISTURBED STATE.
 - THE CONTRACTOR SHALL VERIFY ALL FIELD EXISTING CONDITIONS PRIOR TO AND DURING CONSTRUCTION AND NOTIFY VIKA IMMEDIATELY OF ANY DISCREPANCIES BETWEEN ACTUAL FIELD CONDITIONS AND APPROVED PLAN.
 - 8. IF THE CONTRACTOR HAS ANY QUESTIONS AS TO THE NATURE, METHOD, OR DETAIL OF THE PERFORMANCE OF HIS WORK OR THE CONTRACT DOCUMENTS, HE SHOULD CONTACT VIKA PRIOR TO COMMENCING WORK. VIKA MARYLAND LLC. ACCEPTS NO LIABILITY OR ASSUMPTIONS OR INTERPRETATIONS MADE BY THE CONTRACTOR OR HIS SUB-CONSULTANTS.
 - 9. IT IS THE SOLE RESPONSIBILITY OF THE CONTRACTOR TO NOTIFY VIKA MARYLAND LLC. IMMEDIATELY OF ANY OMISSIONS AND/OR ADDITIONS OF UTILITIES FOUND BY ANY CONTRACTOR ENGAGED IN EXCAVATION AT THIS SITE.
 - 10. CONTRACTOR SHALL TEST PIT AND PROVIDE ALL UTILITY CONNECTION LATERALS FROM THE STREET TO THE EDGE OF RIGHT OF WAY IN ADVANCE OF COMPLETING FINAL INTERNAL LATERAL AND VERTICAL PIPE CONSTRUCTION WITHIN EDGE OF RIGHT OF WAY AND VERIFY CONNECTION POINTS ARE COORDINATED BOTH VERTICALLY AND HORIZONTALLY BASED ON AS-BUILT STREET LATERAL CONDITIONS.
 - 11. CONSTRUCTION OF GRAVITY WET UTILITIES SHALL BE PROVIDED FROM LOWEST CONNECTION POINT UPSTREAM UNLESS OTHERWISE SPECIFICALLY SPECIFIED IN THE CONTRACT DOCUMENTS.
 - 12. WHERE AN EXISTING UTILITY IS FOUND TO CONFLICT WITH THE PROPOSED WORK, OR EXISTING CONDITIONS DIFFER FROM THOSE SHOWN SUCH THAT THE WORK CANNOT BE COMPLETED AS PROVIDED IN THE DESIGN, THE LOCATION, ELEVATION, AND SIZE OF THE UTILITY SHALL BE ACCURATELY DETERMINED WITHOUT DELAY BY THE CONTRACTOR, AND THE INFORMATION FURNISHED IN WRITING TO THE OWNER'S REPRESENTATIVE FOR THE RESOLUTION OF THE CONFLICT. THE CONTRACTOR ASSUMES ALL RESPONSIBILITY FOR CORRECT WORK PERFORMED PRIOR TO NOTIFYING THE OWNER'S REPRESENTATIVE OF THE CONFLICT.
 - 13. THE CONTRACTOR SHALL PROVIDE THE DEVELOPER PHOTOGRAPHIC RECORDS OF THE SITE PRIOR TO LAND DISTURBANCE ACTIVITIES
 - 14. THE CONTRACTOR SHALL OBTAIN APPROVAL OF THE FAA FOR ALL TEMPORARY STRUCTURES SUCH AS CRANES REQUIRED FOR CONSTRUCTION.
 - 15. THE CONTRACTOR SHALL PROVIDE AND COORDINATE THE INSTALLATION OF ALL DRY UTILITIES CONDUITS AND DUCT BANKS UNLESS
 - 16. THE CONTRACTOR SHALL REVIEW STRUCTURAL, GEOTECHNICAL, MECHANICAL AND ARCHITECTURAL PLANS FOR FOUNDATION TREATMENT INCLUDING, BUT NOT LIMITED TO, SHEETING AND SHORING FOR BUILDING EXCAVATION. WATERPROOFING FOR FILL AGAINST BUILDINGS,
 - 17. ALL EARTHWORK OPERATIONS AND EXCAVATION DEWATERING SHALL BE PERFORMED UNDER THE FULL TIME SUPERVISION OF A REGISTERED GEOTECHNICAL ENGINEER WITH GEOTECHNICAL TESTING PROVIDED IN ACCORDANCE WITH CONSTRUCTION SPECIFICATIONS AND SOILS REPORT REQUIREMENTS.
 - 18. THE FOLLOWING PROVISIONS SHALL APPLY TO THE USE OF SHEETING AND SHORING:
 - SHEETING AND SHORING OR OTHER APPROVED METHODS FOR TRENCH BRACING WILL BE REQUIRED ON THIS CONTRACT AS NEEDED
 - TO MEET ALL SAFETY REQUIREMENTS UNLESS OTHERWISE DIRECTED BY THE GEOTECHNICAL/STRUCTURAL ENGINEER, SHEETING AND SHORING WILL BE COMPLETELY REMOVED FROM ALL TRENCHES PRIOR TO BACKFILLING OPERATIONS.
 - C. UNLESS SPECIFICALLY IDENTIFIED IN THE CONTRACT DOCUMENTS, NO ADDITIONAL COMPENSATION SHALL BE ALLOWED FOR SHEETING
 - ALL EXCAVATION SUPPORT SHALL BE PROVIDED IN ACCORDANCE WITH THE PROJECT SPECIFICATIONS AND/OR CONTRACT DOCUMENTS. 19. ALL ELEVATIONS SHOWN ON THE PROFILES ARE INVERT ELEVATIONS UNLESS OTHERWISE NOTED. E. CONTRACTOR SHALL PROVIDE SHEETING AND SHORING FINAL DESIGN AND CONSTRUCTION PERMIT
 - 19. THE CONTRACTOR IS TO VERIFY THAT ALL REQUIRED EASEMENTS (ONSITE AND OFFSITE) HAVE BEEN OBTAINED PRIOR TO THE START OF CONSTRUCTION AND THE CONTRACTOR IS TO ALSO VERIFY THAT ALL EASEMENTS OR LETTERS OF PERMISSION ARE RECORDED PRIOR TO THE START OF ANY CONSTRUCTION.
 - 20. THE CONTRACTOR IS RESPONSIBLE TO NOTIFY THE HOLDER OF THE EASEMENT AS TO THE NATURE OF ANY WORK THAT IS PERFORMED 22. FOR UTILITIES INSTALLED UNDER ROADWAYS AND/OR EASEMENTS PLANNED FOR FUTURE ROADWAYS, BACKFILL SHALL BE COMPACTED WITHIN SAID EASEMENT AND TO FOLLOW ANY GUIDELINES OF STANDARDS WHICH ARE ASSOCIATED WITH OR REFERENCED IN THE
 - 21. CONSTRUCTION OF THESE PLANS SHALL BE IN ACCORDANCE WITH ALL PERMIT CONDITIONS AND SPECIFICATIONS AS WELL AS ALL APPLICABLE DISTRICT OF COLUMBIA DEPARTMENT OF TRANSPORTATION AND DEPARTMENT OF ENVIRONMENT STANDARDS AND
 - 22. THE CONTRACTOR SHALL MAKE CERTAIN THAT ALL PERMITS REQUIRED FOR THESE PLANS ARE OBTAINED PRIOR TO THE START OF
 - 23. MEASURES TO CONTROL EROSION AND SEDIMENT SHALL BE PROVIDED PURSUANT TO AND IN ACCORDANCE WITH CURRENT DISTRICT ORDINANCES AND STANDARDS AND THE APPROVED PLANS.
 - 24. ALL FINISHED GRADING, SEEDING AND SODDING SHALL BE PROVIDED IN SUCH A MANNER TO PRECLUDE THE PONDING OF THE WATER ON THE SITE, PARTICULARLY ADJACENT TO THE BUILDING OR STORM INLETS.
 - 25. CONTRACTOR SHALL ESTABLISH LOCATION OF TEMPORARY CONSTRUCTION ENTRANCE IN THE FIELD AS SHOWN ON APPROVED SEDIMENT AND EROSION CONTROL PLANS. LOCATION MUST BE APPROVED BY THE SEDIMENT CONTROL INSPECTOR PRIOR TO INSTALLATION.
 - 26. THE CONTRACTOR SHALL PROVIDE ALL TEMPORARY TRAFFIC CONTROL MEASURES AND PERSONNEL INCLUDING TEMPORARY PEDESTRIAN MEASURES REQUIRED TO MAINTAIN SIDEWALK CIRCULATION PER DISTRICT REQUIREMENTS. 27. ALL LAND, ON OR OFF SITE, WHICH IS DISTURBED BY THIS DEVELOPMENT AND WHICH IS NOT BUILT UPON OR SURFACED, SHALL
 - BE ADEQUATELY SEEDED AND STABILIZED TO CONTROL EROSION AND SEDIMENTATION IN ACCORDANCE WITH MDE STANDARDS. 28. THE CONTRACTOR SHALL REMOVE AND REPLACE TO THE CURRENT DISTRICT STANDARDS AND SPECIFICATIONS ANY EXISTING
 - ENTRANCES, CURB AND GUTTER OR SIDEWALK ALONG THE FRONTAGE OF THIS SITE WHICH IS DAMAGED DURING CONSTRUCTION.
 - 29. EXISTING IMPROVEMENTS TO BE REMOVED SHALL BE REMOVED TO NEAREST JOINT. NEW CONSTRUCTION SHALL BE PROVIDED AS SHOWN AND ANY DAMAGED AREA SHALL BE REPAIRED TO MATCH CONDITIONS EXISTING PRIOR TO CONSTRUCTION.
 - 30. THE CONTRACTOR SHALL PROVIDE A PEDESTRIAN GUARDRAIL/HANDRAIL (42" IN HEIGHT) WHERE ANY VERTICAL DROP IS MORE THAN 30" OR WHERE SLOPES EXCEED 2(H):1(V) AND THE TOP OF THE SLOPE IS HORIZONTALLY LESS THAN FOUR (4) FEET AWAY FROM THE EDGE OF THE SIDEWALK. THE HANDRAIL SHALL MEET DISTRICT STANDARDS AND SPECIFICATIONS UNLESS OTHERWISE SPECIFIED IN CONTRACT DOCUMENTS.
 - 31. ALL STEPS WITH 3 OR MORE RISERS SHALL BE PROVIDED WITH A HANDRAIL PER DISTRICT OF COLUMBIA STANDARDS AND SPECIFICATIONS.
 - 32. ALL CONSTRUCTION SHALL COMPLY WITH OSHA SAFETY STANDARD FOR EXCAVATION AND ALL OTHER APPLICATION OSHA REQUIREMENTS.
 - 33. CONTRACTOR SHALL PROVIDE ALL MAINTENANCE OF TRAFFIC MEASURES IN ACCORDANCE WITH THE CONTRACT DOCUMENTS
 - 34. ANY DEVIATION FROM THESE PLANS SHALL BE COMMUNICATED TO VIKA VIA A REQUEST FOR INFORMATION (RFI) PROCESS. THE DEVELOPER AND APPLICABLE INSPECTOR MUST BE NOTIFIED OF ANY PLANNED DURATIONS, CONCURRENT TO VIKA'S RFI PROCESS.
 - 35. ANY BLASTING NECESSARY TO INSTALL UTILITIES OR PROVIDE EXCAVATION SHALL REQUIRE A PERMIT AND SHALL BE PERMITTED AND PERFORMED IN ACCORDANCE WITH COUNTY STANDARDS AND THE PROJECT SPECIFICATIONS.
 - 36. NO PLANTINGS OR ERECTION OR OTHER OBSTRUCTIONS SHALL BE MADE WITHIN 5 FT OF ANY FIRE HYDRANT OR WITHIN 10 FT OF ANY FIRE DEPARTMENT CONNECTION.

- 37. NO EXISTING WATERMAIN OR FIRE HYDRANT SHALL BE TAKEN OUT OF SERVICE OR MADE INACCESSIBLE WITHOUT APPROVAL BY APPROPRIATE AGENCIES.
- 38. THE CONTRACTOR SHALL VERIFY THAT THE RELOCATION OF ALL EXISTING UTILITIES ABOVE AND BELOW GRADE IN CONFLICT WITH PROPOSED WORK HAS BEEN COMPLETED. INCLUDING BUT NOT LIMITED TO UTILITY POLES.
- 40. THE CONTRACTOR SHALL COORDINATE FINAL STORM DRAINAGE PIPING, SEWER AND WATER CONSTRUCTION DISCHARGE POINTS WITH FINAL MECHANICAL AND PLUMBING PLANS.
- 41. THE CONTRACTOR SHALL VERIFY INVERT, SIZE AND LOCATION OF BUILDING UTILITY CONNECTIONS TO THE MAINS WITH THE MECHANICAL PLANS AND WITH TEST PITS PRIOR TO PLACEMENT OF UNDERGROUND UTILITIES.
- 42. CONTRACTOR SHALL COORDINATE WITH ARCHITECTURAL AND STRUCTURAL PLANS AND DETAILED LANDSCAPE PLANS FOR CONSTRUCTION OF SITE IMPROVEMENTS.

GENERAL UTILITY AND PAVING NOTES

- THE WORD "PROPOSED" OR "PROP" SHALL MEAN "NEW" ON THESE CONTRACT DOCUMENTS.
- APPROVED SUB GRADE REFERENCED ON THE PLANS IS DEFINED AS THAT SOLID, UNDISTURBED EARTH CAPABLE OF SUPPORTING STREET LOADING WITHOUT DAMAGING SETTLEMENT AS DETERMINED BY THE GEOTECHNICAL ENGINEER. WHERE UNSTABLE SUB GRADE IS ENCOUNTERED, IT SHALL BE MADE STABLE BY COMPACTION OR REPLACEMENT AS REQUIRED.
- LOCATIONS OF ALL EXISTING UTILITIES INCLUDING THOSE OBTAINED FROM RECORDS AND SURFACE SURVEYS ARE APPROXIMATE ONLY. EXACT LOCATIONS OF ALL UTILITIES SHALL BE DETERMINED BY THE CONTRACTOR PRIOR TO THE BEGINNING OF ANY DRILLING. EXCAVATION, SHEETING AND SHORING, OR UTILITY WORK IN THE VICINITY OF SAID UTILITIES. ONCE UTILITIES HAVE BEEN LOCATED IN THE FIELD THE CONTRACTOR SHALL DIG TEST PITS AT ALL PROPOSED UTILITY CROSSINGS AND CONNECTION POINTS AND SHALL SUBMIT ALL RELATED DATA TO VIKA FOR EVALUATION AND COORDINATION PRIOR TO ORDERING MATERIALS.
- THE TEST PITS REQUIRED BY THESE PLANS SHALL BE PERFORMED BY THE CONTRACTOR WELL IN ADVANCE OF CONSTRUCTION AND PRIOR TO ORDERING PRECAST STRUCTURES IN THE VICINITY OF THE AFFECTED UTILITIES. ALL DATA RESULTING FROM TEST PITS SHALL BE SUBMITTED TO VIKA FOR EVALUATION AND PLAN COORDINATION. THE APPROPRIATE UTILITY COMPANIES SHALL BE NOTIFIED BY THE CONTRACTOR PRIOR TO TEST PITTING.
- i. A 4 FT HORIZONTAL SEPARATION SHALL BE MAINTAINED BETWEEN ALL WATER LINES AND SANITARY SEWER LINES UNLESS OTHERWISE SPECIFICALLY SPECIFIED ON THE CONTRACT DOCUMENTS
- 6. NEW UNDERGROUND UTILITIES SUCH AS ELECTRIC, TELEPHONE, CABLE AND GAS WHICH SERVE THE PROJECT SHALL BE LOCATED WITH A MINIMUM 5 FOOT HORIZONTAL SEPARATION FROM WATER, SEWER, AND STORM DRAIN.
- 7. THE CONTRACTOR SHALL VERIFY CLEARANCES BELOW EXISTING AERIAL UTILITY LINES TO REMAIN FOR VEHICULAR ACCESS
- 8. THE CONTRACTOR IS TO VERIFY THAT THE RELOCATION OF ANY UTILITY IN CONFLICT WITH PROPOSED WORK HAS BEEN COMPLETED, INCLUDING UTILITY POLES AND GUY WIRES.
- 9. REPAIRS TO UTILITIES OR PROPERTY DAMAGED AS A RESULT OF THE CONTRACTOR'S NEGLIGENCE OR METHOD OF OPERATION MUST BE MADE AT THE CONTRACTOR'S EXPENSE BEFORE PROCEEDING WITH CONSTRUCTION.
- 10. CONTRACTOR SHALL VERIFY THAT ALL UTILITIES, I.E., WATER, SEWER, GAS, ELECTRIC, TELEPHONE, CABLE ETC., ARE IN PLACE PRIOR TO CONSTRUCTION OF SUB BASE AND/OR PAVING.
- 11. IF PUBLIC WATER SERVICE IS PERMITTED FOR TEMPORARY VEHICLE WASH AREA, A BACKFLOW PREVENTER SHALL BE REQUIRED.
- 12. IF CONTRACTOR REQUIRES THE USE OF FIRE HYDRANTS AS A SOURCE OF WATER FOR CONSTRUCTION PURPOSES, IT SHALL BE UNDER THE AUTHORITY OF DCWATER.
- 13. ALL WATER AND SEWER TRENCH BEDDING TO BE IN ACCORDANCE WITH DCWATER STANDARDS UNLESS OTHERWISE NOTED.
- 14. ALL WATERMAIN AND SANITARY SEWER CONSTRUCTION AND MATERIALS TO BE IN ACCORDANCE WITH THE LATEST EDITION OF THE 4. THE STRUCTURE TOPS ARE TO BE SET AFTER FINE GRADING IS FINISHED TO AVOID UNNECESSARY ADJUSTING. DCWATER STANDARD SPECIFICATIONS, DESIGN MANUAL, STANDARD DETAILS, AND PLUMBING AND GAS FITTING REGULATIONS.
- 15. ALL STORM DRAIN SHALL BE CONSTRUCTED IN ACCORDANCE WITH THE DISTRICT OF COLUMBIA CONSTRUCTION SPECIFICATIONS AND THE LATEST EDITION OF THE GENERAL SPECIFICATIONS.
- 16. ALL STORM DRAIN STRUCTURES GREATER THAN 4 FEET DEEP SHALL BE INSTALLED WITH STEPS IN ACCORDANCE WITH DDOT DWG NO. 309.14.
- 17. ALL PROPOSED UNDERGROUND UTILITIES WITHIN THE RIGHTS-OF WAY SHALL BE INSTALLED IN ACCORDANCE WITH DISTRICT STANDARDS AND SPECIFICATIONS PRIOR TO INSTALLATION OF ANY SUB BASE MATERIAL, CURB AND GUTTER, OR SIDEWALK WITHIN SAID RIGHTS-OF-WAY.
- 18. THE CONTRACTOR SHALL MAKE FIELD ADJUSTMENTS TO STRUCTURES, WHEN NECESSARY TO MEET EXISTING CONDITIONS.
- 20. ALL EXISTING UTILITIES AND STRUCTURES NOT SHOWN TO BE REMOVED ARE TO REMAIN AND PRESERVED AS FUNCTIONAL AT ALL
- 21. ALL STORM DRAIN UNDER PAVEMENT THAT IS NOTED TO BE "ABANDONED" IS TO BE FILLED FULL WITH CONCRETE
- TO NOT LESS THAN 95% OF MAXIMUM DENSITY; (ASTM D-698) OR IN ACCORDANCE WITH DCDOT SPECIFICATIONS. WHERE ANY PART OF THE STORM DRAIN SYSTEM IS LOCATED IN FILL, THE CONTRACTOR IS TO PROVIDE BACKFILL COMPACTED TO 95% OF MAXIMUM DENSITY FROM APPROVED SUB GRADE TO THE STRUCTURE BOTTOM SLAB AND/OR THE PIPE BEDDING.
- 23. ALL STORM SEWER STRUCTURES SHALL BE PRECAST OR PREFABRICATED SO THAT TOPS AND/OR SLABS ARE JOINTED AND MAY BE ADJUSTED TO FINAL GRADES.
- 24. A WATERTIGHT CONNECTION SHALL BE MADE AT ALL PIPES ENTERING DRAINAGE STRUCTURES
- 25. LENGTHS OF STORM DRAIN PIPE SHOWN ON THE DRAWINGS ARE MEASURED FROM EDGE OF STRUCTURE TO EDGE OF STRUCTURE UNLESS INDICATED OTHERWISE.
- 26. CUT AND PATCH WORK IN EXISTING PUBLIC STREETS WHICH MUST BE PERFORMED DUE TO THE INSTALLATION OF UTILITIES SHALL BE PERFORMED IN ACCORDANCE WITH DISTRICT STANDARDS AND SPECIFICATIONS. SAW CUT JOINTS SHALL BE REQUIRED.
- 27. ALL UTILITY PATCH IN PAVEMENT SHALL BE DONE IN ACCORDANCE WITH DOOT STANDARD DWG NO. 215.01 28. EXISTING FEATURES TO REMAIN SUCH AS EXISTING MANHOLE FRAMES AND COVERS, VALVE BOXES AND COVERS, AND FIRE HYDRANTS SHALL BE ADJUSTED OR RECONSTRUCTED, AS NECESSARY, TO MATCH FINISHED GRADES.
- 29. RETAINING WALLS SHOWN HERON SHALL BE DESIGNED BY OTHERS. THE CONTRACTOR SHALL COORDINATE FINAL RETAINING WALL DESIGN WITH THE OWNER'S REPRESENTATIVE PRIOR TO CONSTRUCTION, AND SHALL SUBMIT SHOP DRAWINGS FOR APPROVAL OF FINAL RETAINING WALL DESIGN TO OWNER'S REPRESENTATIVE.
- 30. A BUILDING PERMIT IS REQUIRED PRIOR TO THE INSTALLATION OF ANY TYPE OF FENCE OR WALL OVER 30 INCH IN HEIGHT. ALL WALLS SHALL HAVE HANDRAILS UNLESS OTHERWISE NOTED ON THE SITE PLAN.
- 31. A MINIMUM OF 2 FOOT HORIZONTAL CLEARANCE IS REQUIRED BETWEEN THE WALKWAY EDGE AND ANY VERTICAL OBSTRUCTIONS SUCH AS TREES, UTILITY POLES, SIGNS, ETC., UNLESS OTHERWISE SPECIFICALLY NOTED ON THE PLANS AT EACH LOCATION.
- 32. ALL DRIVEWAYS AND ACCESS TO ADJACENT PROPERTIES AND PROPERTIES LOCATED ACROSS ALL PUBLIC ROADWAYS SHALL BE MAINTAINED AT ALL TIMES.
- 33. THE CONTRACTOR SHALL GRIND OR MILL EXISTING PAVEMENT ON ADJACENT ROADWAYS AS REQUIRED AND SHALL OVERLAY EXISTING 14. ALL WATER MAINS TO BE DUCTILE IRON PIPE, MEETING AWWA C11 REQUIREMENTS. PROVIDE DUCTILE IRON RETAINER GLANDS FOR JOINT RESTRAINT ON PAVEMENT AND PROVIDE HEELS AND SMOOTH FINISH SURFACE BETWEEN LIMIT OF OVERLAY AND EXISTING PAVEMENT SURFACE OVERLAY. LIMITS OF PAVEMENT WORK SHALL BE DETERMINED BY THE INSPECTOR AT TIME OF CONSTRUCTION. THE MINIMUM OVERLAY TO BE PROVIDED BY THE CONTRACTOR SHALL BE TO THE CENTERLINE OF ROADS UNLESS OTHERWISE INDICATED ON THE PLANS, DETAILS OR CONTRACT DOCUMENTS.
- 34. STANDARD GUARDRAIL SHALL BE REQUIRED BASED ON FINAL INSPECTION OF DISTRICT INSPECTOR AND PHYSICAL CONDITIONS AND OBSTRUCTIONS IN FIELD AND/OR AS SPECIFIED ON THE CONTRACT DOCUMENTS.
- 35. A 4 IN (MIN.) LAYER OF GRADED AGGREGATE STONE IS REQUIRED BENEATH CURB AND GUTTER AND SIDEWALKS UNLESS OTHERWISE SPECIFIED ON THE CONTRACT DOCUMENTS.
- 36. DISTURBED AREAS ADJACENT TO ESTABLISHED LAWNS SHALL BE SODDED. OTHER DISTURBED AREAS SHALL BE SEEDED AND MULCHED.
- 37. WHERE A PROPOSED PIPE CROSSES OR PARALLELS AN EXISTING STREET, THE ASPHALT SHALL BE NEATLY SAW CUT TO FULL DEPTH. AFTER INSTALLATION OF THE PIPE, THE ROADWAY SHALL BE PATCHED IN ACCORDANCE WITH THE DISTRICT REQUIREMENTS.
- 38. THE FIRST LAYER OF THE BITUMINOUS CONCRETE SURFACE COURSE MUST BE PLACED AS SOON AS FIELD CONDITIONS ALLOW AFTER THE BITUMINOUS CONCRETE BASE COURSE HAS BEEN PLACED. NO TRAFFIC IS ALLOWED ON THE BASE COURSE UNTIL THE FIRST SURFACE COURSE HAS BEEN PLACED.
- 39. TYPES OF STRUCTURES REFER TO THE STANDARD DETAILS OF THE DISTRICT OF COLUMBIA UNLESS OTHERWISE NOTED.

- 40. WHERE THE DROP ON THE MAIN LINE THROUGH A STRUCTURE CAN BE ACCOMMODATED BY A SLOPE OF 1-1/2:1 OR FLATTER, A ROUNDED CHANNEL LINED WITH SEWER BRICK ON EDGE SHALL BE BUILT TO THE CROWN OF THE PIPES.
- 41. ALL RCP STORM DRAIN PIPES SHALL BE INSTALLED ON APPROVED SUBGRADE AND BACKFILLED WITH APPROVED MATERIAL
- 42. ALL PIPES SHOWN AS RCP SHALL BE REINFORCED CONCRETE PIPE CLASS IV CONFORMING TO ASTM C-76 AND C-443, UNLESS INDICATE OTHERWISE ON THE CONTRACT DOCUMENTS.
- 43. PIPE SHALL NOT BE CONSTRUCTED INTO THE CORNER OF A SQUARE OR RECTANGULAR STORM DRAIN STRUCTURE. A MINIMUM CLEARANCE OF 6 (SIX) INCHES MUST BE PROVIDED BETWEEN ANY INSIDE CORNER OF THE STRUCTURE AND THE OUTSIDE DIAMETER OF THE PIPE. THIS 20251 CENTURY BOULEVARD SUITE #400 REQUIREMENT APPLIES TO ALL STORM DRAIN STRUCTURES WHETHER PRECAST OR CAST IN PLACE.
- 44. CUT AND PATCH WORK IN EXISTING PUBLIC STREETS WHICH MUST BE PERFORMED DUE TO INSTALLATION OF UTILITIES SHALL BE PERFORMED IN ACCORDANCE WITH DISTRICT STANDARDS AND SPECIFICATIONS. SAW CUT JOINTS SHALL BE REQUIRED.

GENERAL PAVING AND GRADING NOTES

- A TEN FOOT TRANSITION FROM STD. CURB AND GUTTER TO THE MODIFIED SPILL GUTTER WILL BE REQUIRED.
- CONTRACTOR SHALL ROUND ALL VERTICAL BREAKS OF THE CURB AND GUTTER WITH SMOOTH SPLINE CURBS
- 3. ALL CURB AND GUTTER TO BE CONCRETE PER STD. DWG NO. 609.01 UNLESS OTHERWISE NOTED ON PLAN
- 4. CONTRACTOR TO TIE INTO EXISTING CURB, SIDEWALK, AND PAVEMENT WITH A SMOOTH TRANSITION TO MEET EXISTING
- 5. ALL EXISTING CURB AND GUTTER AND SIDEWALK TO REMAIN ALONG THE FRONTAGE OF THIS SITE DAMAGED DURING CONSTRUCTION SHALL BE REMOVED AND REPLACED TO THE STANDARDS AND SPECIFICATIONS OF THE DISTRICT.
- ALL INTERNAL SIDEWALKS TO BE A MINIMUM OF 58ALL SIDEWALK RAMPS TO BE BUILT IN ACCORDANCE WITH DCDOT STD DWG NO. 609.05 AND 609.07 WITH DETECTABLE WARNING SURFACES (DWG NO. 609.07) AS NOTED ON DESIGN PLANS.
- 7. ALL ELEVATIONS SHOWN ON THE PLANS ARE TOP OF CURB UNLESS OTHERWISE NOTED.
- 8. CONTRACTOR IS TO VERIFY THAT ALL UTILITIES. I.E., WATER, SEWER, GAS, ELECTRIC, TELEPHONE, CABLE, ETC., ARE IN PLACE PRIOR TO CONSTRUCTION OF SUBBASE AND/OR PAVING.
- ALL EXISTING UTILITIES ARE TO BE ADJUSTED TO GRADE AS NECESSARY BY THE CONTRACTOR.
- 10. GRADING SHALL BE DONE IN SUCH A MANNER AS TO PROVIDE POSITIVE DRAINAGE AWAY FROM BUILDINGS.
- ALL FINISHED GRADING, SEEDING AND SODDING SHALL BE DONE IN SUCH A MANNER TO PRECLUDE THE PONDING OF THE WATER ON THE SITE, PARTICULARLY ADJACENT TO THE BUILDINGS OR STORM INLETS.
- 12. ALL LAND, ON OR OFF SITE, WHICH IS DISTURBED BY THIS DEVELOPMENT AND WHICH IS NOT BUILT UPON OR SURFACED, SHALL BE ADEQUATELY SEEDED AND STABILIZED TO CONTROL EROSION AND SEDIMENTATION.

GENERAL STORM DRAIN NOTES

- ALL EXISTING UTILITIES SHOWN ON THIS PLAN HAVE BEEN TAKEN FROM AVAILABLE RECORDS. THE CONTRACTOR IS REQUIRED TO DIG TEST PITS IN ADVANCE OF TRENCHING IN ORDER TO DETERMINE THE EXACT LOCATION AND ELEVATION AT CROSSINGS. IF A CONFLICT IS DISCOVERED, NOTIFY VIKA, INC. AT (301) 916-4100. PRIOR TO BEGINNING INSTALLATION OF UTILITIES, CONTRACTOR SHALL VERIFY INVERTS AT ALL CONNECTIONS WITH EXISTING UTILITIES PRIOR TO PURCHASING OR ORDERING ANY PRECAST STRUCTURES.
- ALL STORM DRAINS SHALL BE CONSTRUCTED IN ACCORDANCE WITH THE LATEST EDITION OF GENERAL SPECIFICATIONS AND STANDARDS OF DISTRICT OF COLUMBIA DEPARTMENT OF TRANSPORTATION.
- 3. CONTRACTOR SHALL SUBMIT DRAWINGS FOR ALL PRECAST STORM DRAIN STRUCTURES TO THE DEVELOPER/ENGINEER FOR APPROVAL PRIOR TO FABRICATION.
- 5. THE CONTRACTOR SHALL MAKE FIELD ADJUSTMENTS TO STRUCTURES, WHEN NECESSARY, TO MEET EXISTING CONDITIONS AS DIRECTED BY THE OWNER'S REPRESENTATIVE.
- ALL UTILITIES REQUIRED TO BE ABANDONED SHALL BE DONE IN ACCORDANCE WITH DOOT AND DCWATER STANDARDS
- 7. ALL BLASTING REQUIREMENTS TO INSTALL UTILITIES SHALL REQUIRE A PERMIT AND SHALL BE PERFORMED IN ACCORDANCE WITH THE DCDOT STANDARDS AND THE PROJECT SPECIFICATIONS.
- 8. ALL STORM DRAIN ARE PUBLIC, UNLESS OTHERWISE NOTED.

DISTRICT OF COLUMBIA GENERAL NOTES:

- NOTIFY DISTRICT OF COLUMBIA WATER AND SEWER AUTHORITY 48 HOURS PRIOR TO THE START OF CONSTRUCTION: MR. TED DYSON, ACTING CHIEF ENGINEERING INSPECTOR BRANCH 202-787-4299.
- CONTACT MISS UTILITY (1-800-257-7777) 48 HOURS PRIOR TO THE START OF CONSTRUCTION. THE EXCAVATOR MUST NOTIFY ALL PUE COMPANIES WITH UNDERGROUND FACILITIES IN THE AREA OF PROPOSED EXCAVATION AND HAVE THOSE FACILITIES LOCATED BY THE UTILITY COMPANIES PRIOR TO COMMENCING EXCAVATION.
- 3. SEWER AND WATER B.M. TO BE USED FOR CONSTRUCTION.
- 4. ALL PROPOSED WATER AND SEWER WORK TO BE PERFORMED UNDER THE INSPECTION OF THE DC WATER
- ALL PROPOSED WORK TO BE CONSTRUCTED IN ACCORDANCE WITH THE LATEST STANDARDS AND SPECIFICATIONS OF THE DC WATER.
- 6. USE MANHOLE ENTRY SEALS WHERE REQUIRED.
- 7. THIS PLAN DOES NOT IMPLY THAT ALL UNDERGROUND UTILITIES AND THOSE SHOWN ARE NECESSARILY APPROXIMATE. THE CONTRACTOR SHALL TAKE PREPARED OR APPROVED BY ME, AND THAT I AM A ALL AND WHATEVER STEPS NECESSARY TO ACCURATELY LOCATE AND PROTECT ALL EXISTING UTILITIES SUFFICIENTLY IN ADVANCE OF CONSTRUCTION DULY LICENSED PROFESSIONAL ENGINEER UNDER TO ENSURE THAT THE PLANS CAN BE EXECUTED. IN THE EVENT OF CONFLICT, THE CONTRACTOR SHALL HAND DIG TEST PITS AT ALL UTILITY CROSSINGS TO DETERMINE THE EXACT LOCATION AND DEPTH WELL IN ADVANCE OF CONSTRUCTION.
- THE CONTRACTOR SHALL CAREFULLY EXAMINE THE SITE AND MAKE ALL INSPECTIONS NECESSARY IN ORDER TO DETERMINE THE FULL EXTEND OF TH WORK REQUIRED TO MAKE THE COMPLETED WORK CONFORM TO THE DRAWINGS AND SPECIFICATIONS. THE CONTRACTOR SHALL SATISFY HIMSELF AS TO THE NATURE AND LOCATION OF THE WORK, CONDITIONS, THE CONFORMATION AND CONDITIONS OF THE EXISTING GROUND SURFACE AND THE CHARACTER OF EQUIPMENT AND FACILITIES NEEDED PRIOR TO AND DURING EXECUTION OF THE WORK. THE CONTRACTOR SHALL SATISFY HIMSELF AS TO THE CHARACTER, QUALITY, AND QUANTITY OF SURFACE AND SUBSURFACE MATERIALS OR OBSTACLES TO BE ENCOUNTERED. ANY INACCURACIES OR DISCREPANCIES BETWEEN THE DRAWINGS AND SPECIFICATIONS MUST BE BROUGHT TO THE OWNER'S ATTENTION IN ORDER TO CLARIFY THE EXACT
- NATURE OF THE WORK TO BE PERFORMED PRIOR TO THE COMMENCEMENT OF ANY WORK.
- 9. THE PROPOSED STORMWATER MANAGEMENT SYSTEMS SHALL BE PRIVATELY OWNED AND MAINTAINED INCLUDING ALL PIPING ON PRIVATE PROPERTY.
- 10. CONTRACTOR SHALL COORDINATE UTILITY POLE AND UNDERGROUND CONDUIT RELOCATIONS WITH PEPCO, WASHINGTON GAS, VERIZON AND COMCAST.
- 11. SCHEDULE AND HOLD PR-CONSTRUCTION MEETING WITH THE SEDIMENT CONTROL INSPECTOR, CALL 202-535-2240 FOR APPOINTMENT. 12. UNDER DCWATER CUSTOMER FEES AND CHARGES, CONTRACTOR, PLUMBERS, OWNERS ARE RESPONSIBLE FOR EXCAVATION, BACKFILLING, REPAVING AND RESTORATION OF PUBLIC SPACE FOR STREET AND SIDEWALK CUTS, FOR NEW UTILITIES, CONNECTIONS AND TAPS. REMOVALS, ABANDONMENTS, OF SERVICES MUST BE PERFORMED BY THE CONTRACTOR, AT THE WATER AND SEWER LINE WITHIN THE PUBLIC SPACE AND REPAIRED UNDER DCWATER INSPECTION. DCWATER IS NOT RESPONSIBLE FOR FINAL RESTORATION OF STREET AND SIDEWALK CUTS PERFORMED BY THE CONTRACTOR OR
- 13. NOTIFY DCWATER ONE WEEK PRIOR TO START OF CONSTRUCTION: UTILITY INSPECTION STATION 202-787-4299 WATER SERVICES 202-612-3400 OR 3460

SEWER SERVICES 202-264-3824 OR 3829

- ALL WATER MAIN, PIPE AND FITTINGS, INCLUDING VALVES AND FIRE HYDRANTS. RETAINER SHALL NOT BE USED ON EXISTING CAST IRON PIPE.
- 15. DEVELOPERS. CONTRACTORS AND PLUMBERS MUST SUBMIT FINAL CONSTRUCTION AS—BUILT INFORMATION TO THE APPROPRIATE DCWATER INSPECTOR(S) FOR REVIEW AND APPROVAL, UPON COMPLETION OF NEW AND EXISTING UTILITIES TO BE ABANDONED IN PUBLIC SPACE. AS-BUILT DRAWINGS MUST SHOW DIMENSIONS, ELEVATIONS AND RELOCATIONS OF ANY DCWATER UTILITIES AND PERTINENT INFORMATION.
- 16. ONCE DCWATER INSPECTOR APPROVES THE AS-BUILT, A COPY MUST BE SUBMITTED TO THE DOCUMENTS AND PERMITS OFFICE AND THE WATER AND
- SEWER DESIGN SECTION AT 5000 OVERLOOK AVENUE, S.W., 5TH FLOOR, WASHINGTON, DC. 17. IT IS CONTRACTOR'S RESPONSIBILITY TO OBTAIN THE MOST CURRENT APPROVED ARCHITECHTURAL/MEP PLAN AND COORDINATE SAME WITH THIS SITE PLAN PRIOR TO BEGINNING CONSTRUCTION OPERATIONS.
- 18. PERMANENT WATER CONNECTIONS MUST BE INSTALLED FOR ALL CONSTRUCTION PURPOSES.
- 19. ALL WATER DISTRIBUTION AND SANITARY SEWER MATERIALS AND CONSTRUCTION SHALL CONFORM TO THE LATEST DCWATER SPECIFICATIONS AND
- 20. ALL PUBLIC UTILITIES AND ROAD CONSTRUCTION SHALL CONFORM TO THE LATEST DDOT SPECIFICATIONS AND DETAILS.
- 21. DCWATER AND PLUMBING INSPECTORS MAY REQUIRE WATERLINE CONNECTIONS TO BE "CUT-IN" AT CERTAIN LOCATIONS DUE TO SIZE AND AGE OF EXISTING MAINS. CONTRACTOR SHOULD BE AWARE OF THIS AND CONDUCT TEST PITS AND INSPECTIONS OF EXISTING POINTS, WELL BEFORE
- 22. THE TEST PIT LOCATIONS SHOWN ARE PRELIMINARY AND SUBJECT TO REVISIONS. ADDITIONAL TEST PITS MAY BE REQUIRED, FOLLOWING "UTILITY MARK-OUT" PROCEDURES (i.e: TEST PITS FOR GAS, ELECTRIC, CABLE, TELEPHONE, ETC.) AS ORDERED BY THE CONTRACTOR VIA MISS UTILITY. ADDITIONAL TEST PITS LOCATIONS MAY BE REVISED PRIOR TO FINAL JURISDICTIONAL APPROVAL.



VIKA MARYLAND, LLO GERMANTOWN, MARYLAND 20874 PHONE: (301) 916-4100

FAX: (301) 916-2262

GERMANTOWN, MD. MCLEAN, VA PREPARED FOR: **ELM STREET** DEVELOPMENT, INC. 175 Admiral Cochrane Dr. **SUITE 112** Annapolis, MD, 21401 P. 410-266-9700

Mr. Stephen M. Horne

shorne@elmstreetdev.com

DATE REVISIONS

THE LAWS OF THE DISTRICT OF COLUMBIA.

JEFFREY B. AMATEAU LICENSE No. 905527 EXPIRATION DATE JULY 14, 2018

T. PAUL'S TOWNHOUSE

> **PARCEL** PART OF LOT 1067 PART OF LOT 915 SQUARE 3648 3015 4th STREET N.E.

WASHINGTON, D.C.

EGEND AND

NOTES


DRAWN BY: DESIGNED BY: <u>LK</u> DATE ISSUED: <u>SEPT. 2016</u>


PROJECT VM1453 G


C-02

LAYOUT: LEGEND & NOTES, Plotted By: kelso

ocated by the utility companies prior to commencing excavation.

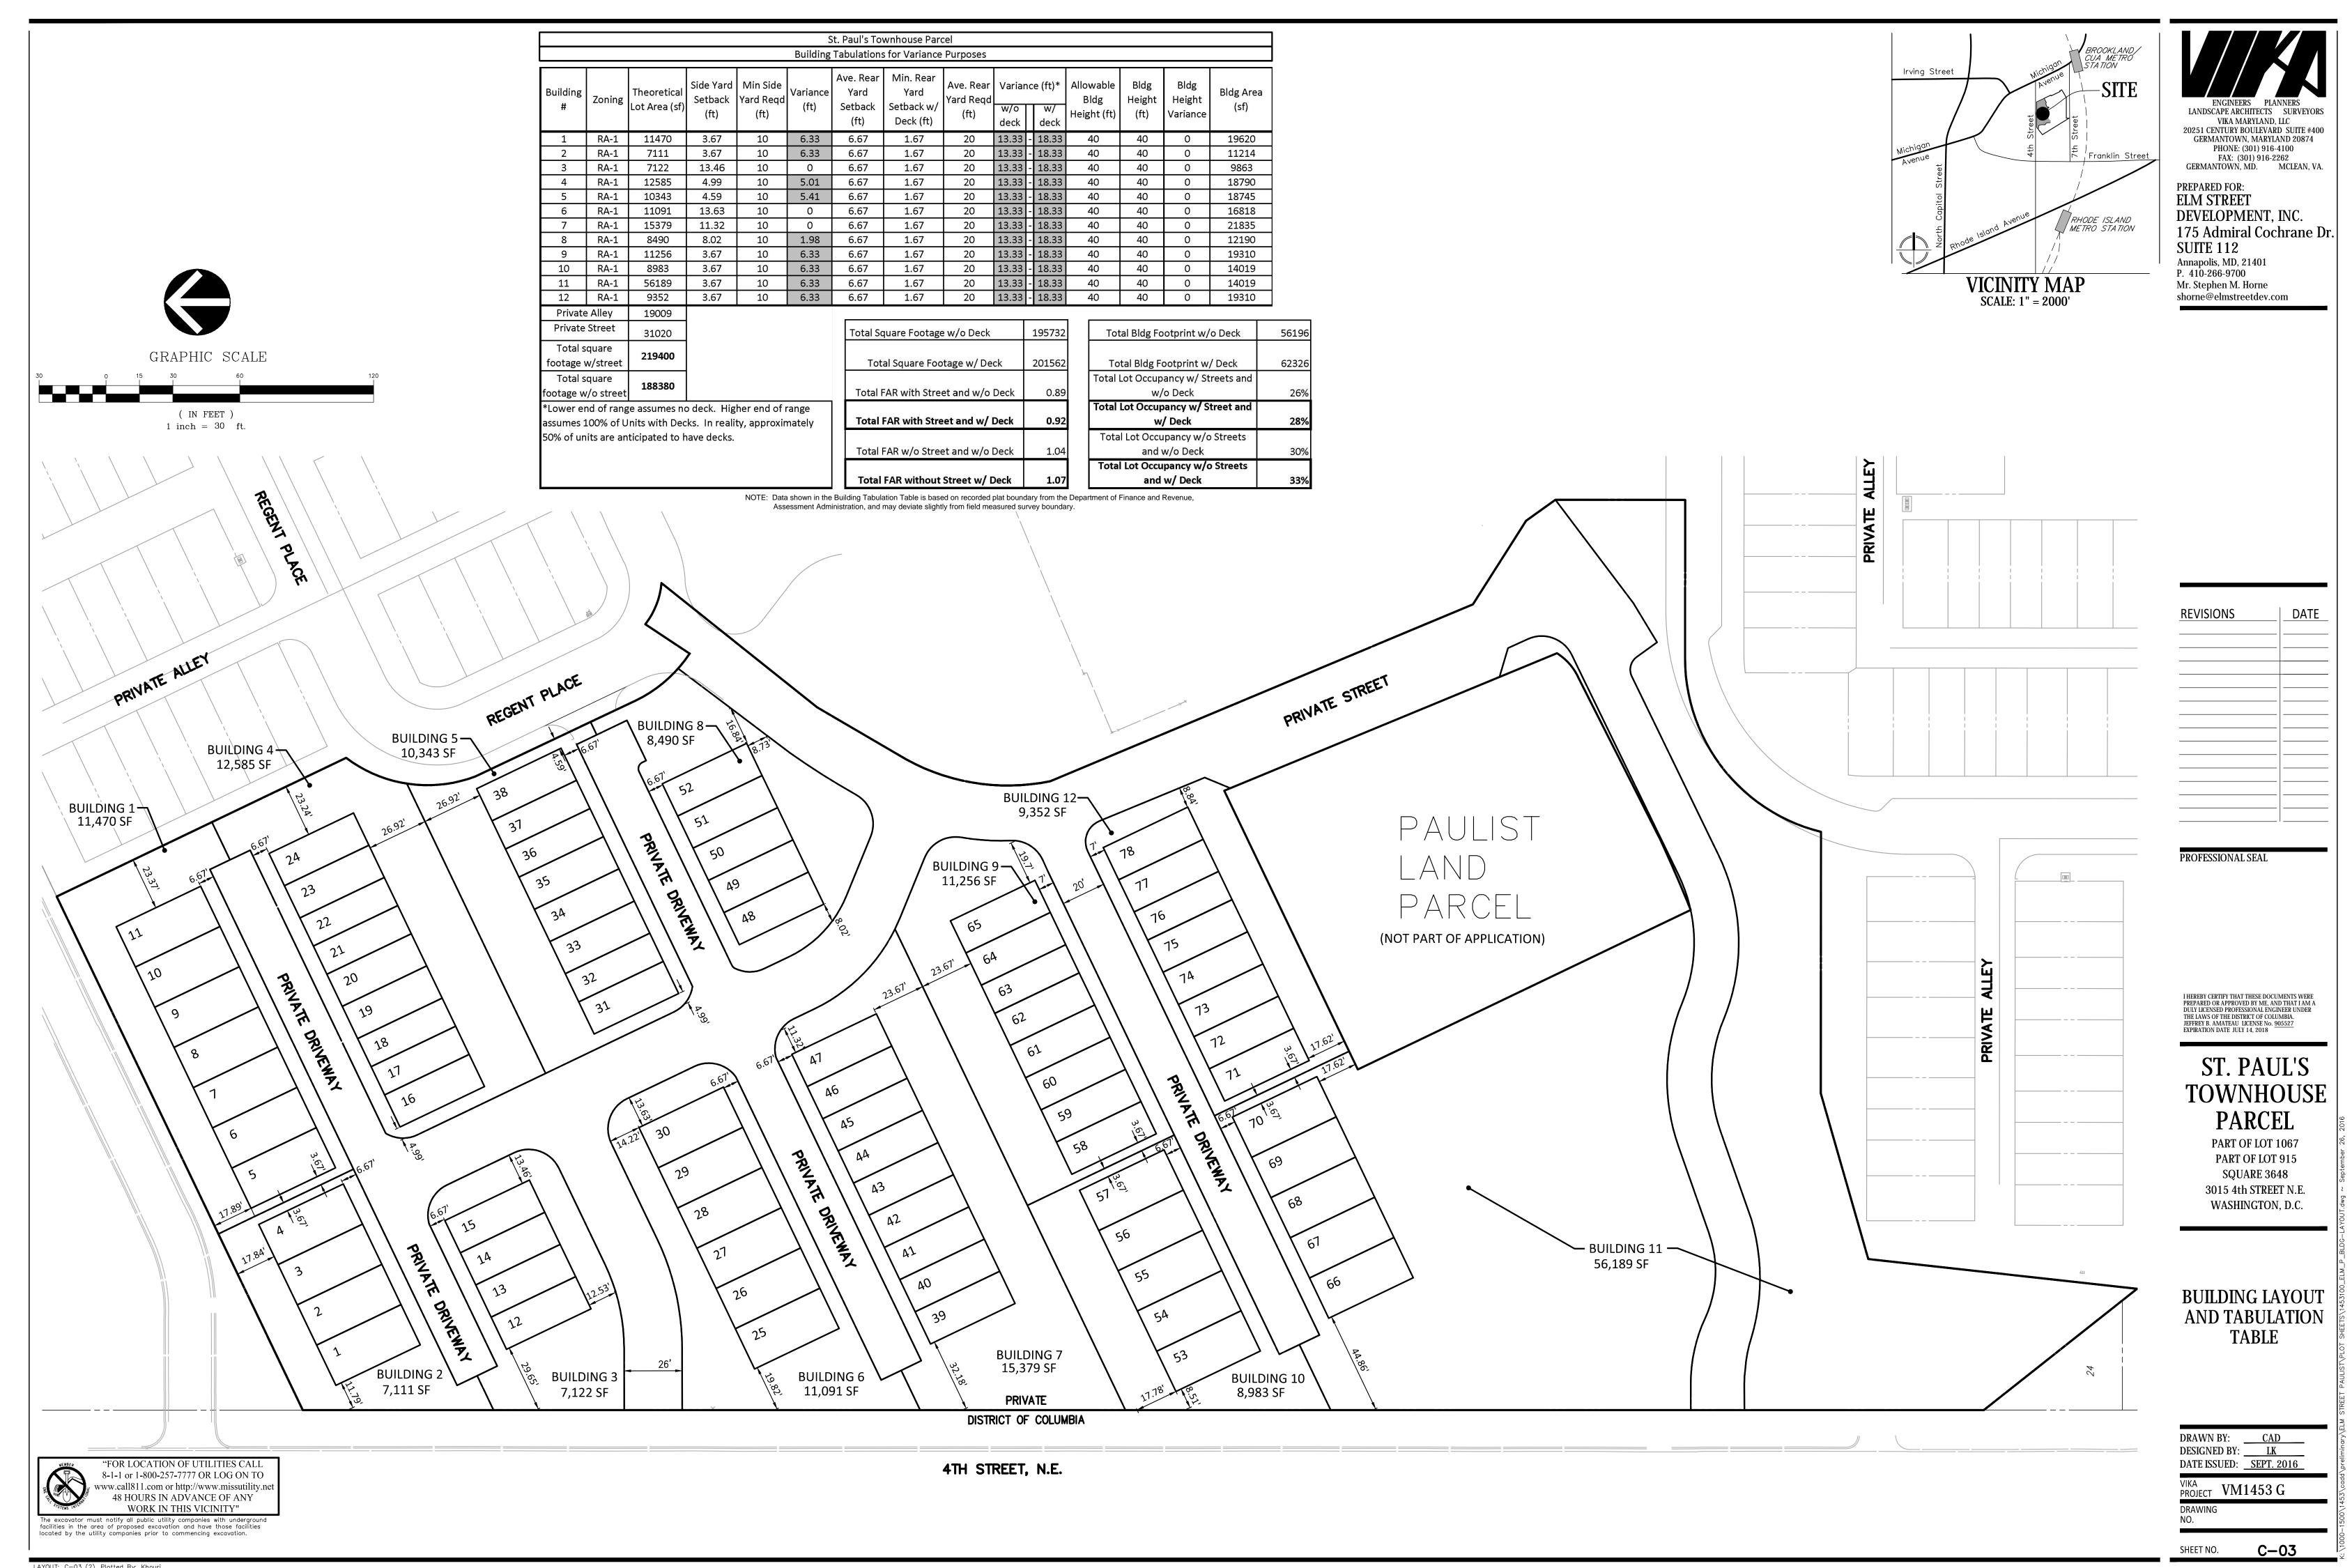

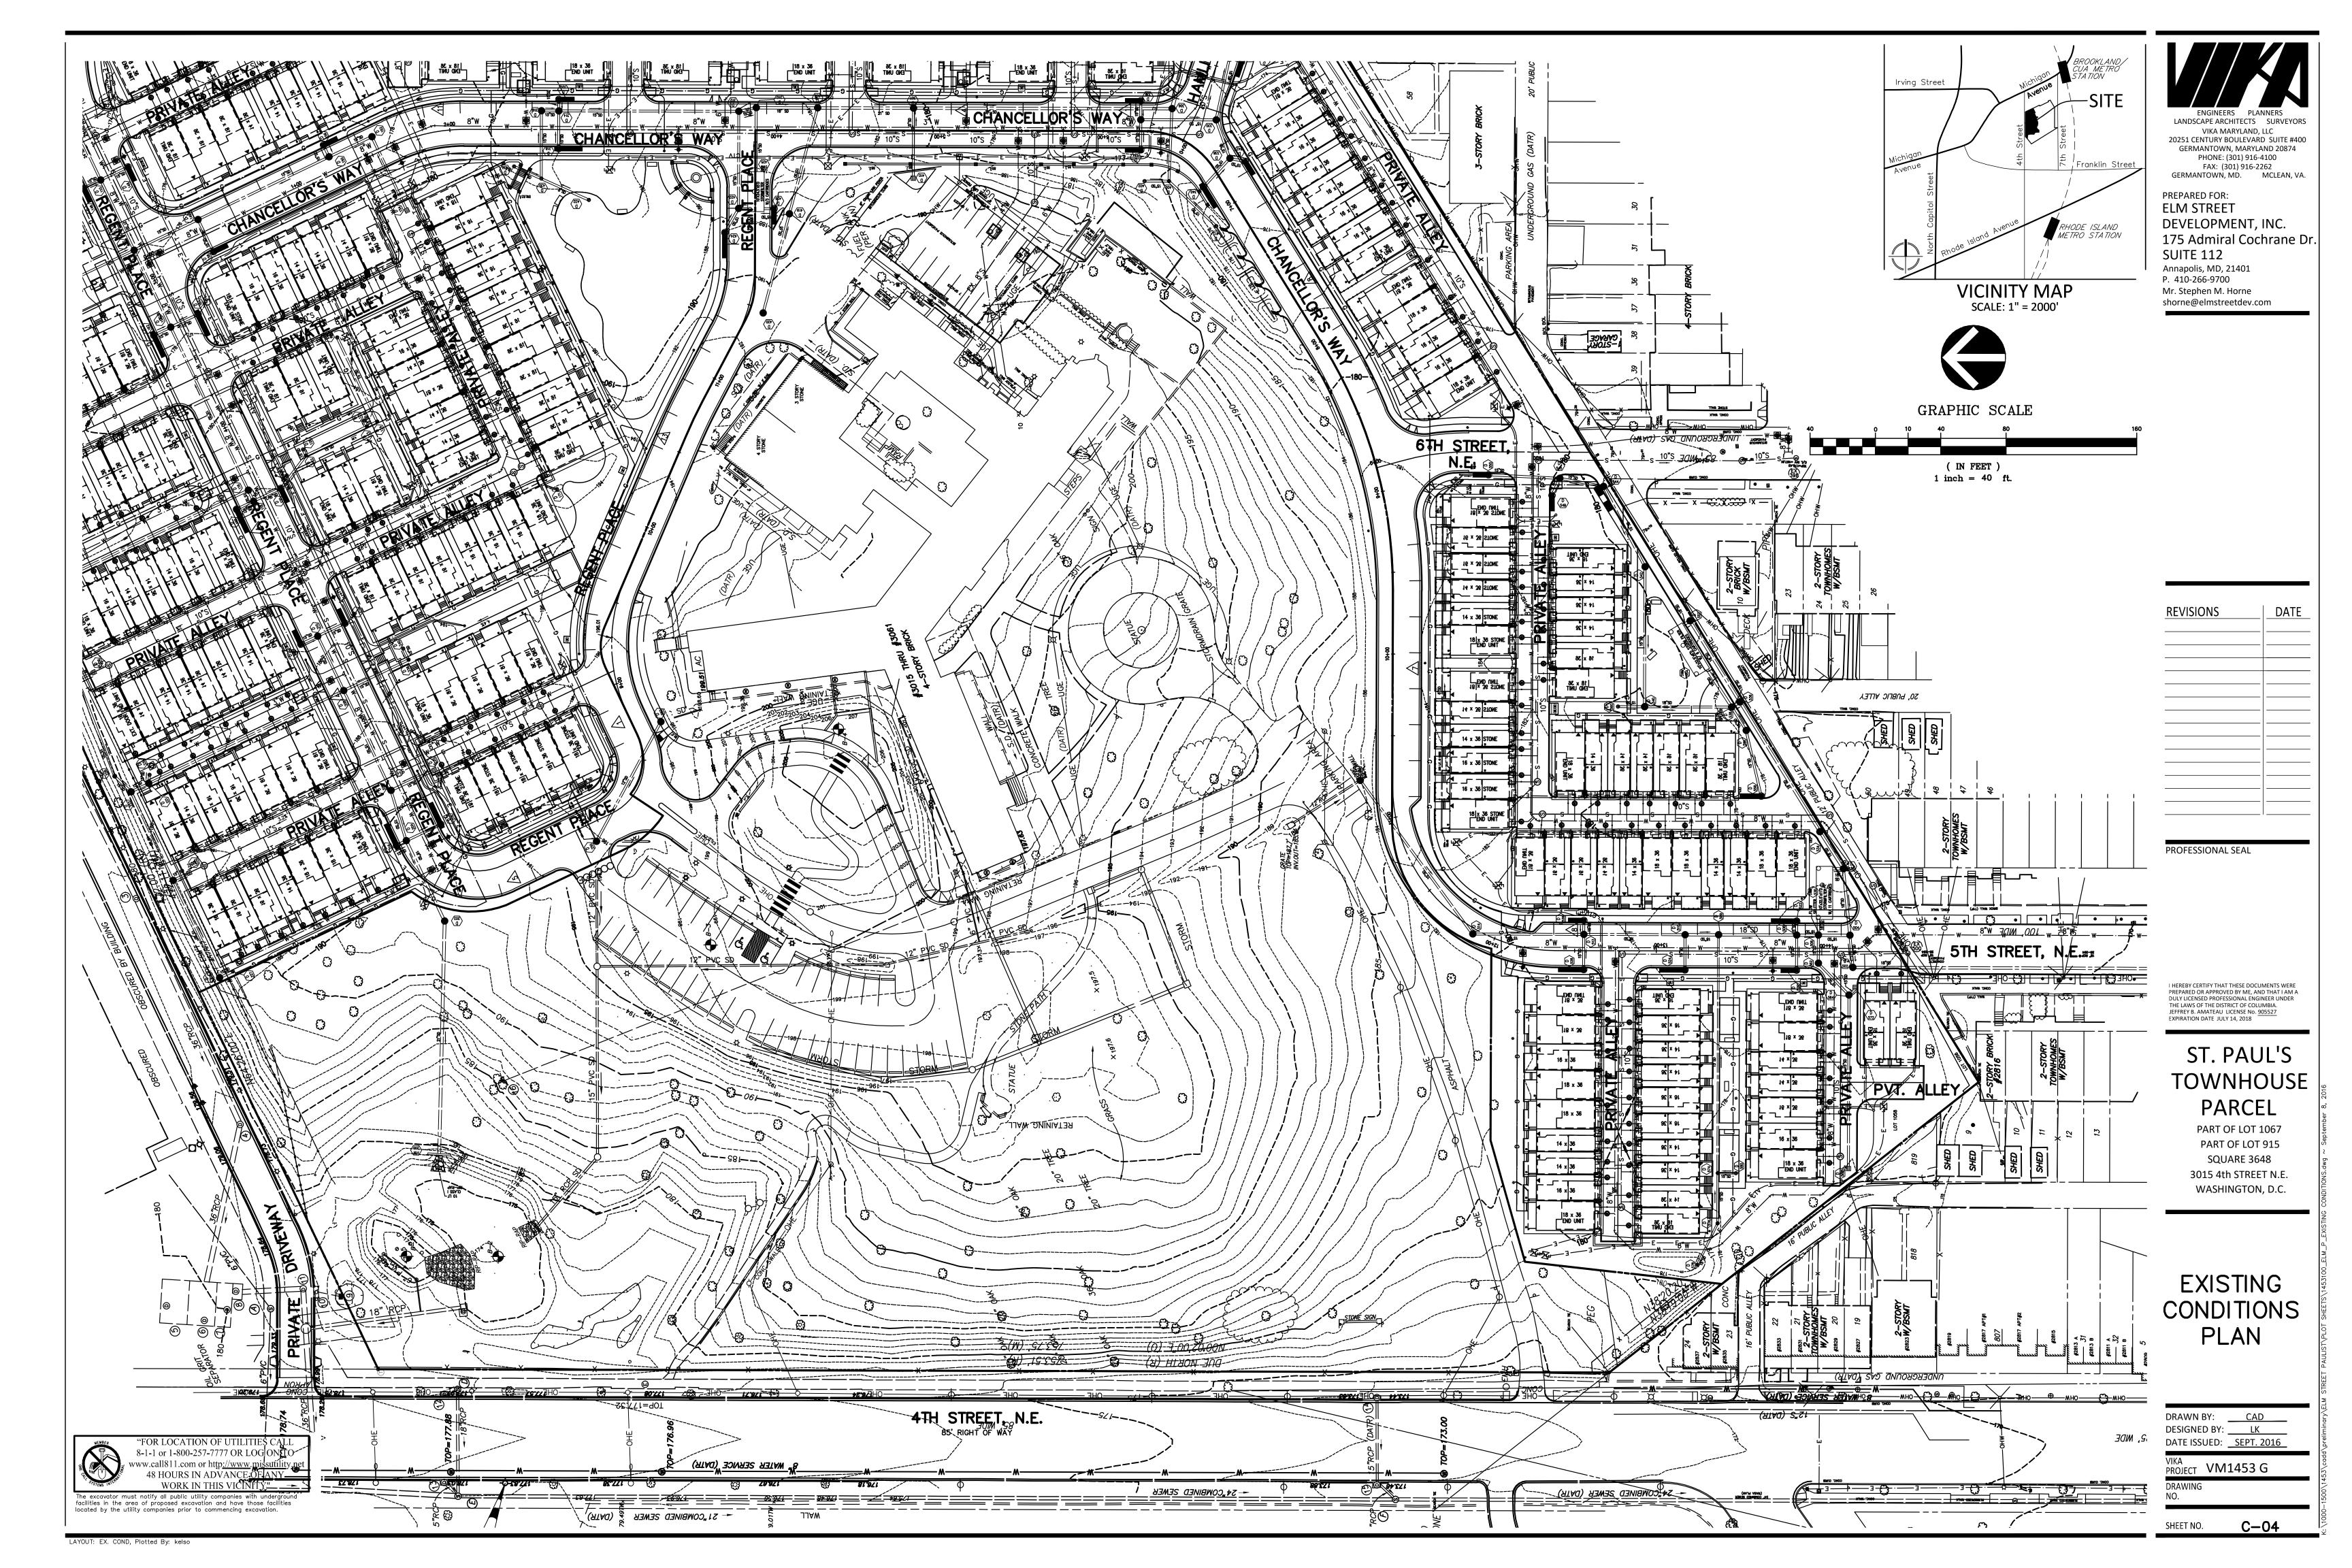

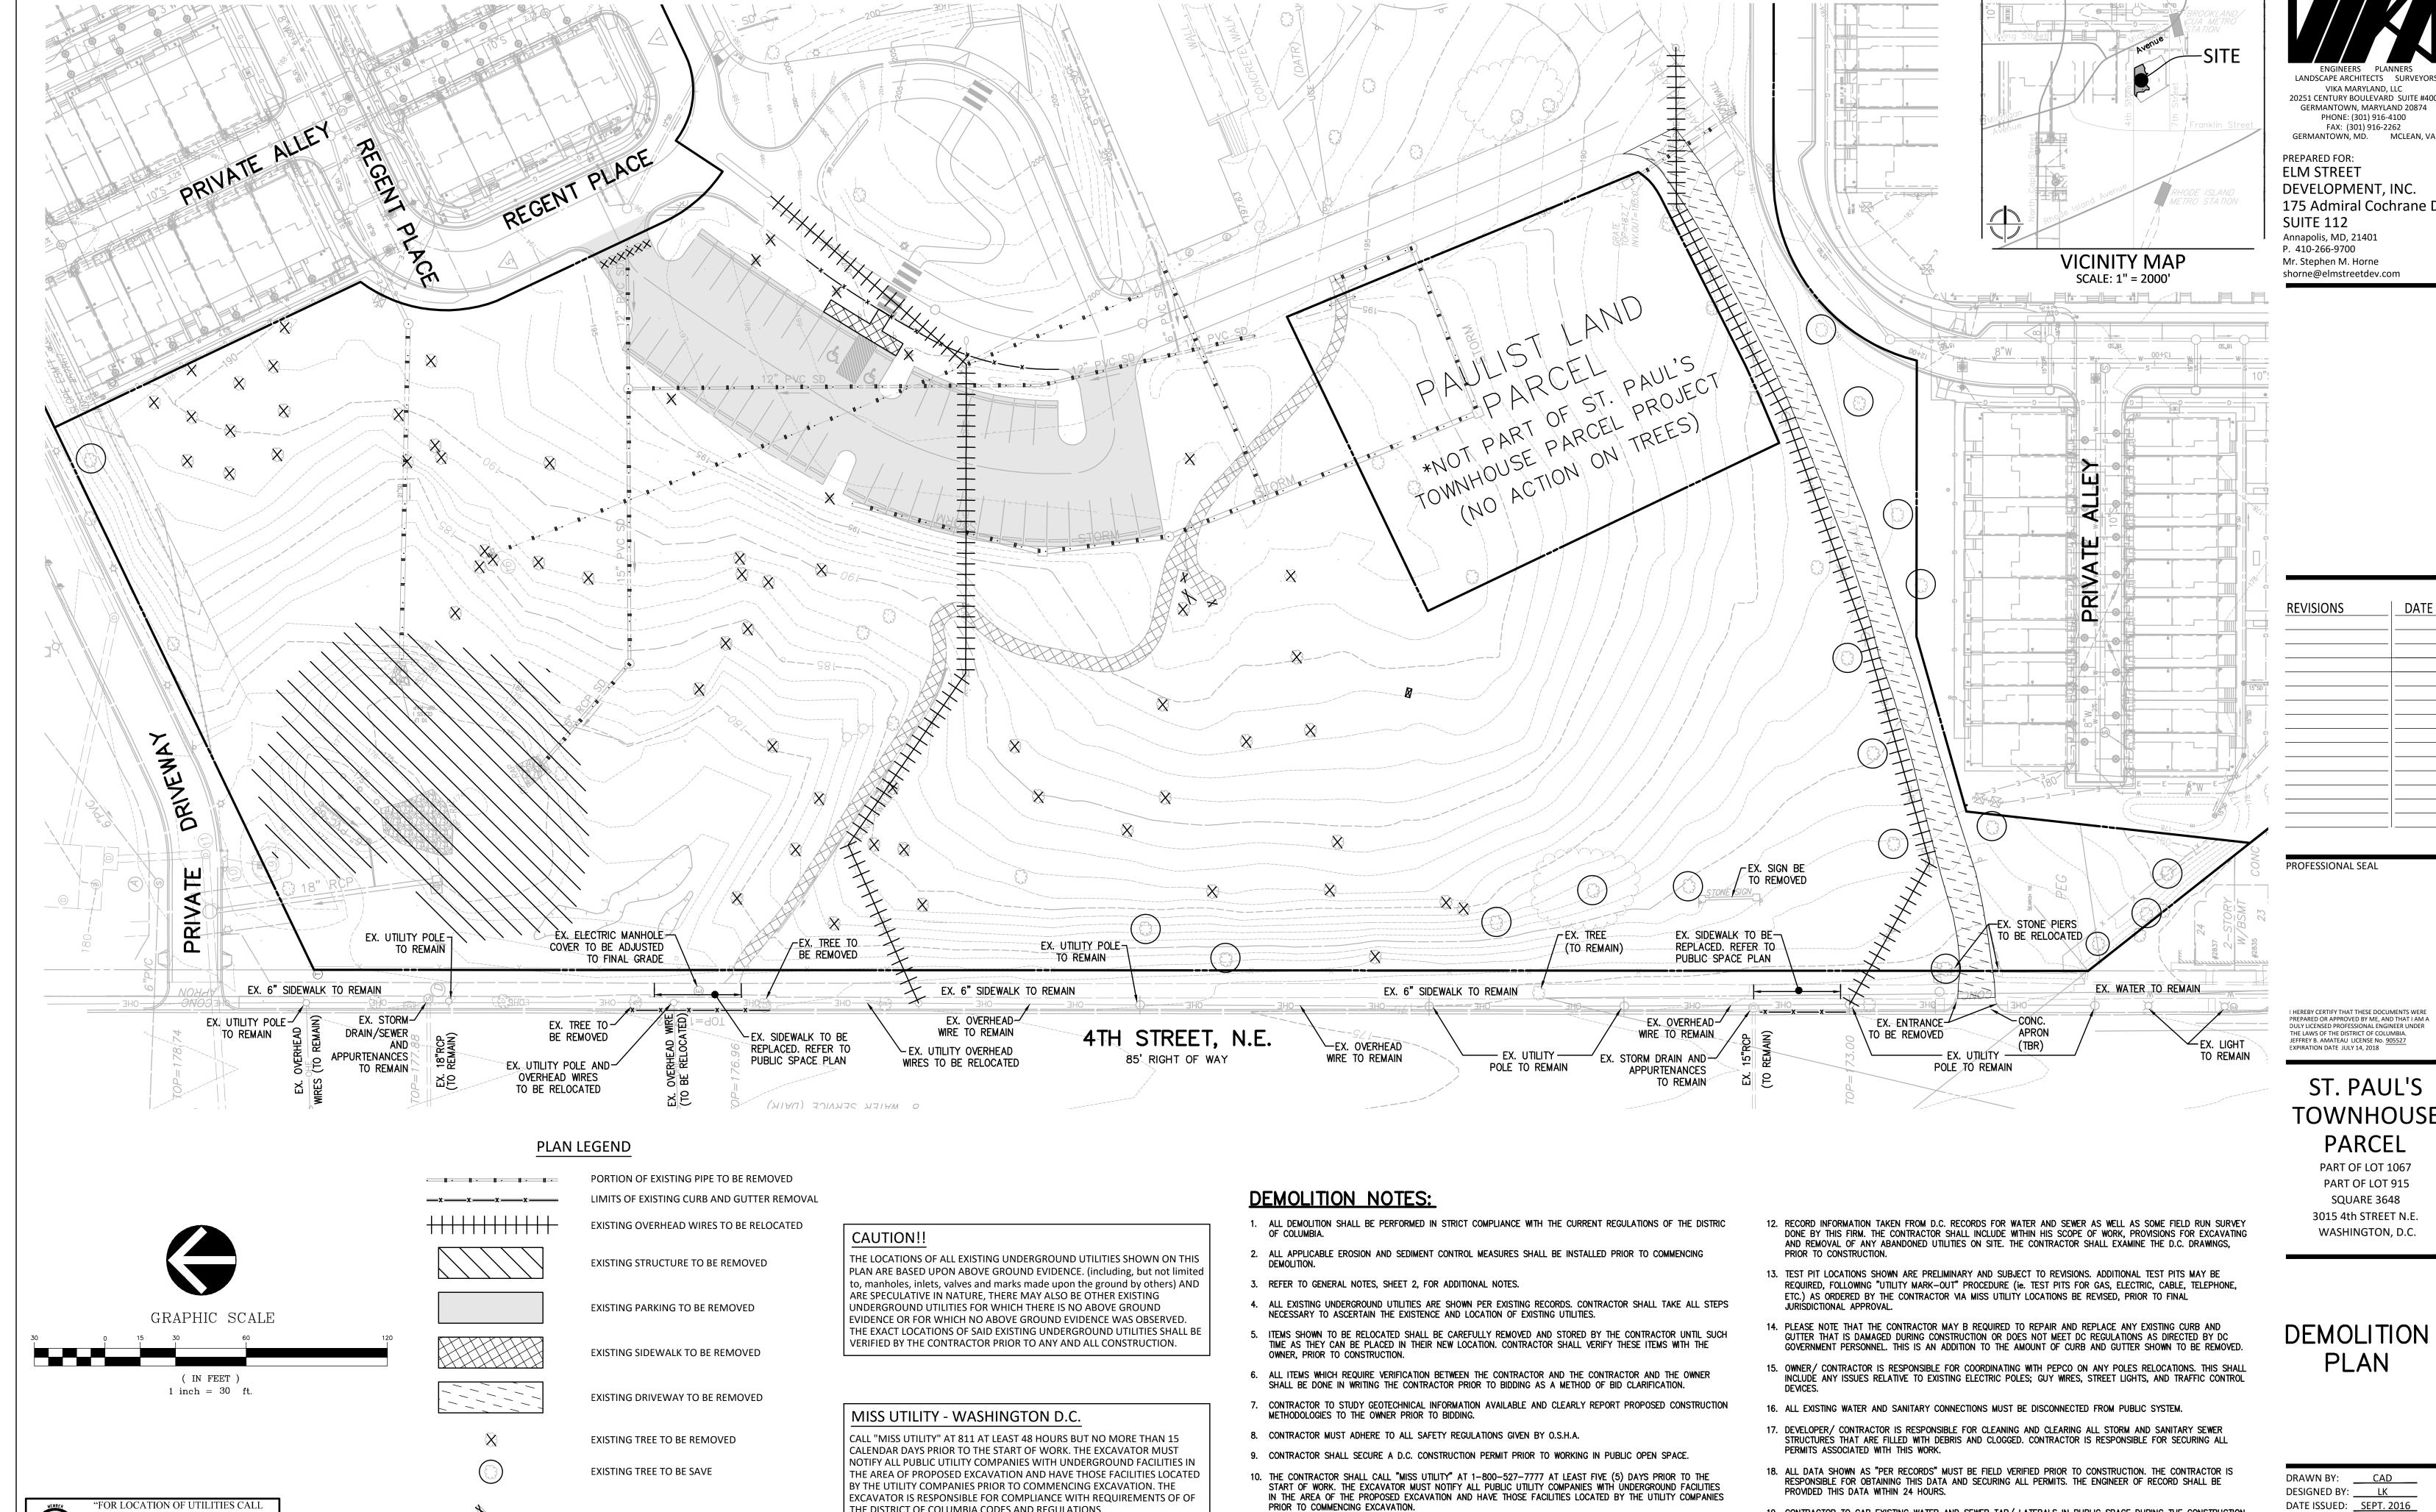

THE DISTRICT OF COLUMBIA CODES AND REGULATIONS.

EXISTING BENCHES TO BE REMOVED

EXISTING BOLLARDS TO BE REMOVED

EXISTING LIGHTS TO BE REMOVED

LANDSCAPE ARCHITECTS SURVEYOR 20251 CENTURY BOULEVARD SUITE #400 GERMANTOWN, MARYLAND 20874 PHONE: (301) 916-4100

DEVELOPMENT, INC. 175 Admiral Cochrane Dr.

I HEREBY CERTIFY THAT THESE DOCUMENTS WERE PREPARED OR APPROVED BY ME, AND THAT I AM A DULY LICENSED PROFESSIONAL ENGINEER UNDER THE LAWS OF THE DISTRICT OF COLUMBIA.

ST. PAUL'S **TOWNHOUSE**

PART OF LOT 1067 PART OF LOT 915 SQUARE 3648 3015 4th STREET N.E. WASHINGTON, D.C.

DEMOLITION

DATE ISSUED: <u>SEPT. 2016</u>

PROJECT VM1453 G DRAWING

LAYOUT: DEMO PLAN, Plotted By: kelso

8-1-1 or 1-800-257-7777 OR LOG ON TO

www.call811.com or http://www.missutility.ne

48 HOURS IN ADVANCE OF ANY

WORK IN THIS VICINITY"

The excavator must notify all public utility companies with undergroun facilities in the area of proposed excavation and have those facilities

located by the utility companies prior to commencing excavation.

19. CONTRACTOR TO CAP EXISTING WATER AND SEWER TAP/ LATERALS IN PUBLIC SPACE DURING THE CONSTRUCTION

OF THE NEW WATER AND SANITARY LATERALS.

11. IT IS THE RESPONSIBILITY OF THE CONTRACTOR TO REVIEW ALL OF THE DRAWINGS AND SPECIFICATIONS

DEFINED BY THE DRAWINGS AND IN FULL CONFORMANCE WITH LOCAL REGULATIONS AND CODES.

ASSOCIATED WITH THIS PROJECT WORK SCOPE PRIOR TO THE INITIATION OF CONSTRUCTION. SHOULD THE

THE START OF CONSTRUCTION. FAILURE BY THE CONTRACTOR TO NOTIFY THE PROJECT ENGINEER SHALL

CONTRACTOR FIND A CONFLICT WITH THE DOCUMENTS RELATIVE TO THE SPECIFICATIONS OR APPLICABLE CODES,

IT IS THE CONTRACTOR'S RESPONSIBILITY TO NOTIFY THE PROJECT ENGINEER OF RECORD IN WRITING PRIOR TO

CONSTITUTE ACCEPTANCE OF FULL RESPONSIBILITY BY THE CONTRACTOR TO COMPLETE THE SCOPE OF WORK AS

