

JEFFREY C. UTZ (202) 663-8715



January 18, 2008

By Hand Delivery

Mr. Anthony Hood, Chairman D.C. Zoning Commission 441 4th Street, N.W. Second Floor Washington, DC 20001

ZONING COMMISSION
District of Columbia

CASE NO.

EXHIBIT NO.

OFFICE OF ZONING

Re:

Zoning Commission Case No. 05-15A, Modification to a Consolidated PUD Application for 318 I Street, NE (Square 775, Lot 50 (formerly Lots 1, 22, 23, 32, 826 and 827)) – Twenty Day Submission

Dear Chairman Hood and Members of the Commission:

The applicant in Zoning Commission Case No. 05-15A, Broadway I Associates LLC (the "Applicant"), hereby submits its twenty day submission in connection with its application to modify the consolidated planned unit development ("PUD") approved by Zoning Commission Order No. 05-15.

The Applicant is still proposing to create an exciting residential project on an underutilized site that will contribute significantly to the Near Northeast residential neighborhood. The Applicant is applying for a modification to the initial PUD order due to shifting real estate market dynamics. As a result, the new project will contain a total of approximately 166 - 180 residential units (an increase from the originally approved 125 - 140 units), a height of 70 feet (an increase from the originally approved height of 65 feet), an FAR not to exceed 5.65 (no change), and a lot occupancy not to exceed 80% (a decrease from the originally approved lot occupancy of 85%). The total square footage of the building would not exceed 160,000 square feet. The building's design and site layout will remain significantly similar to the design and site layout of the building approved under Zoning Commission Order No. 05-15. The revised plans, elevations and drawings of the proposed modification to the PUD project are attached as Exhibit A.

In addition, the Applicant would like to offer a few further clarifications about the project:

o Affordable Unit Distribution - The Applicant has provided further specifics about the size, type, and location of the affordable units. As in the approved project under Order No. 05-15, the type and SERNING ENAMISSION

Mr. Anthony Hood, Chairman January 18, 2008 Page 2

> affordable units reflects the distribution of the units throughout the project. The affordable units will not be concentrated in any one area of the project, but rather will be located throughout the project. The location of the affordable units is shown on pages 12 and 13 of the updated plans attached as Exhibit A.

- o Green Features Although the project will not be LEED-certified, the final building would be able to claim between 22 and 30 LEED points. 26 points is the equivalent of being LEED certified.
- o District Department of Transportation Follow up Regarding the streetscape and alley improvements proposed as part of the project, the Applicant met with DDOT in a preliminary design review meeting (PRRM) on September 5, 2007 to define the project's programming for the public space. At that meeting, DDOT asked the Applicant to install a six foot exposed aggregate concrete sidewalk (similar to that installed at Senate Square), a six foot landscaped buffer and planting strip including trees, and a three foot brickwork carriageway (between the landscaped buffer and the curb along with walking paths corresponding to parking spots). The project's planting is installed between the sidewalk and the building. The result of this streetscape is Low Impact Development (LID) since water runoff charges back into the tree wells and planting areas. Such intricate treatment of the streetscape is shown on pages 9 and 11 of Exhibit A. The District requested bituminous asphalt paving in the alley. The project's resulting treatment of the public space is acceptable DDOT.

We look forward to the opportunity to present this modification to you on February 7, 2008.

Respectfully submitted,

PILLSBURY WINTHROP SHAW PITTMAN, LLP

Allison C. Prince /gea

Allison C. Prince

Jeffrey C. Uty

Jeffrey C. Utz

Enclosures

Certificate of Service

I certify that on January 18, 2008, I delivered a copy of the foregoing document via hand delivery or first class mail to the addresses listed below.

Arthur Jackson
Office of Planning
801 N. Capitol Street, NE

ANC 6C (eight copies) P.O. Box 77876 Washington, DC 20013-7787

Washington, DC 20002

Suite 4000

ANC 6C05 Commissioner Alan Kimber 228 Parker St., NE Washington DC

318 EYE STREET, NE

WASHINGTON, DC

ZONING COMMISSION CASE NO. 05-15A PROPOSED MODIFICATIONS TO ZONING COMMISSION ORDER NO. 05-15 DATED 07/21/06

PLANNED UNIT DEVELOPMENT



CONTENTS

ARCHITECTURAL DRAWINGS

Building Summary and Lot Plan

Aerial Site Photo Map of Zoning Matter of Right (MOR) and PUD Height

Neighborhood Photos - Alley to West of Site

Neighborhood Photos - Eye Street and 4th Street Neighborhood Photos of Site - Eye Street and 4th Street

Approved Entry Plan (1st Floor Plan)

Proposed Modified Entry Plan (2nd Floor Plan)

Approved Enlarged Site Plan

Proposed Modified Enlarged Site Plan

Proposed Modified Floor Plans (P3 - 3) / ADU Units

Proposed Modified Floor Plans (4 - 8) / ADU Units

Approved Site Plan / Roof Plan Proposed Modified Site Plan / Roof Plan

Approved Composite Street Elevation

Proposed Modified Composite Street Elevation

Proposed Modified Enlarged Elevations and Material Key

Proposed Modified Street Sections - Eye Street and 4th

Approved Enlarged 4th Street Elevation Proposed Modified Enlarged 4th Street Elevation

Shadow Study A - May 4, 10:00 AM

Shadow Study B - May 4, 2:00 PM

Shadow Study C - November 8, 10:00 AM Shadow Study D - November 8, 2:00 PM

CIVIL DRAWINGS.

Existing Condition Plan

Sediment & Ermion Control Plan.

Site Plan

Unley Plan

SWM Plan

Sediment & Erosion Control Details




BUILDING AREA SUMMARY					
Level	Residential Amenity and Service (SF)	Approximate Number of Units	Total FAR by Floor (SF)		
P-1 Floor	2,969	**	**		
First Floor	1,361	17	18,570		
Second Floor	7,840	18	19,101		
Third Floor	:**:	23	19,095		
Fourth Floor		23	19,823		
Fifth Floor		23	19,823		
Sixth Floor		23	19,823		
Seventh Floor	**	23	19,910		
Eighth Floor	**	17	17,998		
TOTAL	12,170	160 - 180	154,143		


Notes:

Parking Levels Below Grade: 76,678 SF.


KEY ELEMENTS OF PUD MODIFICATION						
Zone C-2-B	M.O.R.	Approved PUD	Modified PUD	Comment		
FAR	6.0	5.65	Not To Exceed 5.65	Final FAR directly proportional to final unit count.		
Height	65' (90' PUD)	65'	70'	20' Below PUD Allowable (5' set back at 60')		
Lot Occupancy	80%	85%	Not To Exceed 75%	Final Lot Occupancy directly proportional to final unit count.		
Parking	1:3	1 : 1 +12 Visitor	1:0.8 +12 Visitor	Exceeds M.O.R. and Market Demand. Total area of parking Increased.		
Unit Count	N/A	120-140	160-180	Number of units Increased. 167 units illustrated in proposed modified submission		
ADU by Area	N/A	9,120 SF	9,120 SF	Area of affordable units unchanged. 13 units illustrated, see Page 12 & 13 for locations.		
Recreation Space	15%*	15%	> 15%	* Requirement has been eliminated.		

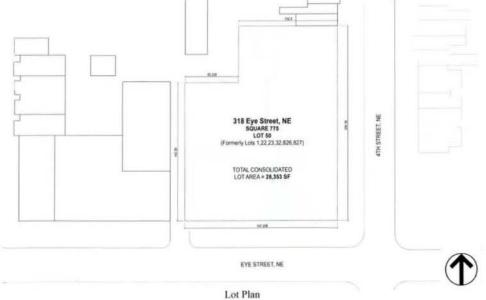

318 Eye Street, NE

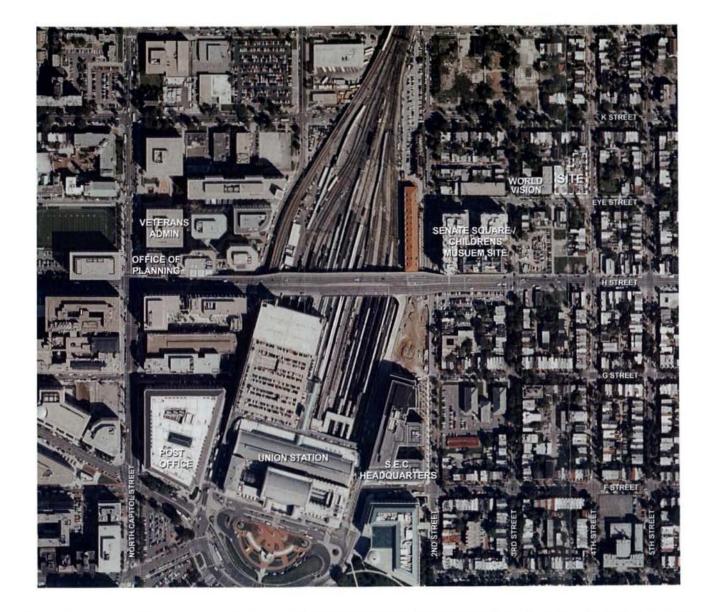




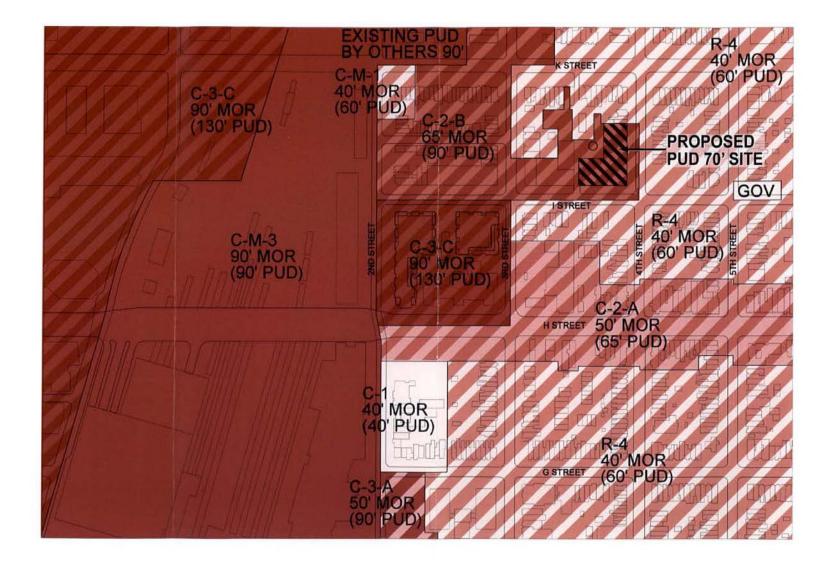



Map of Zoning Matter of Right (MOR) and PUD Height Allowances

318 Eye Street, NE

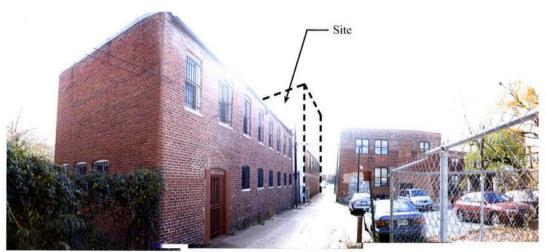

1 View of Alley Facing South



2 View of Alley Facing North



See Page 6 4

K STREET

Site

5 EYE STREET See Page 7

See Page 5 1

See Page 5 2

See Page 6 3

3RD STREET

€ See Page 7


4TH STREET



(3) 300 Block of Eye Street NE - South Side (Opposite Site)




4) 800 Block of 4th Street NE - East Side

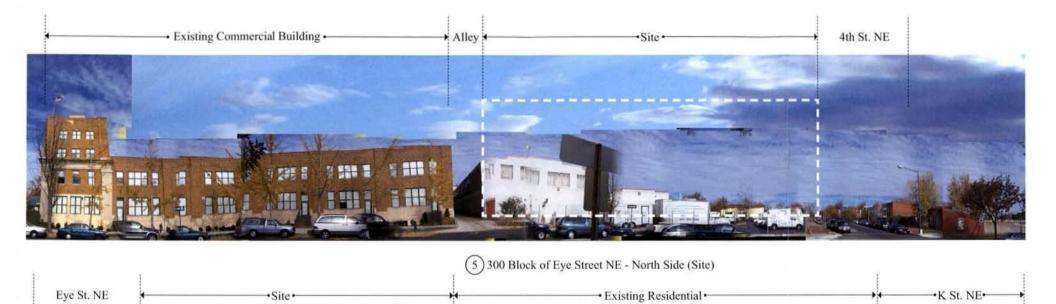




6 900 Block of 4th Street NE - West Side (Site)

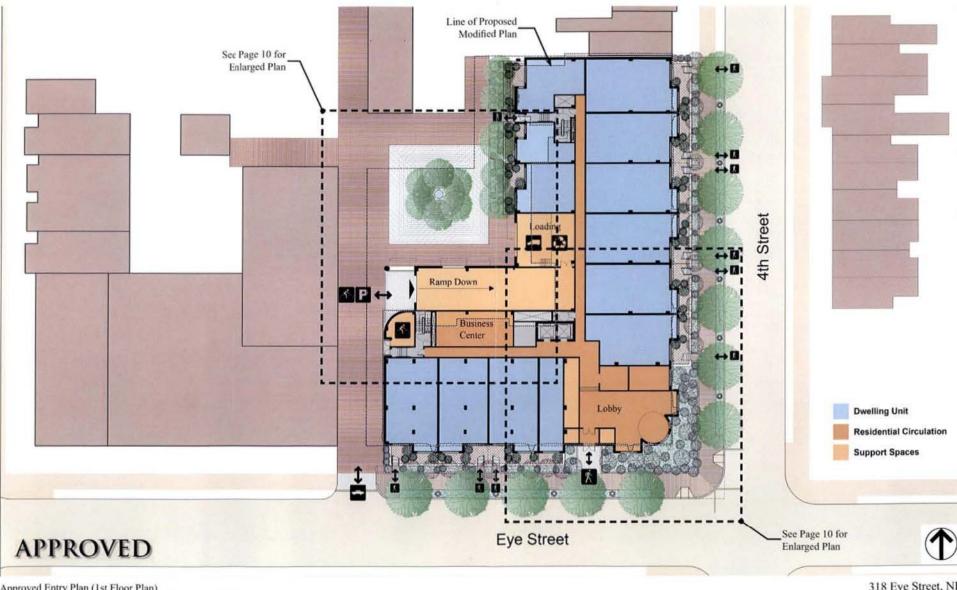

Approved Entry Plan (1st Floor Plan)

318 Eye Street, NE

SCALE: 1/32" = 1'-0"

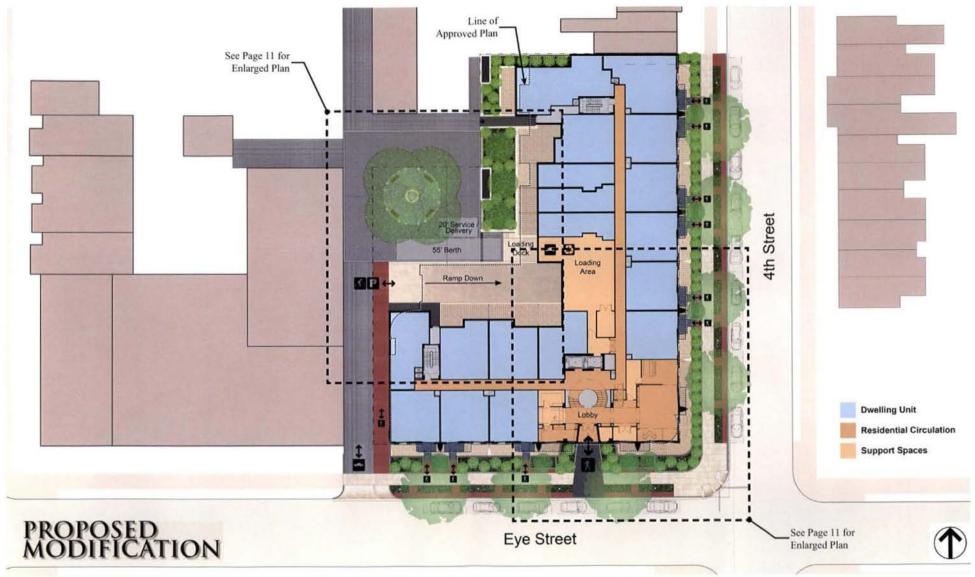



318 Eye Street, NE

* Streetscape and alley changes reflect PDRM comments of 09/05/07.

Proposed Modified Entry Plan (2nd Floor Plan)



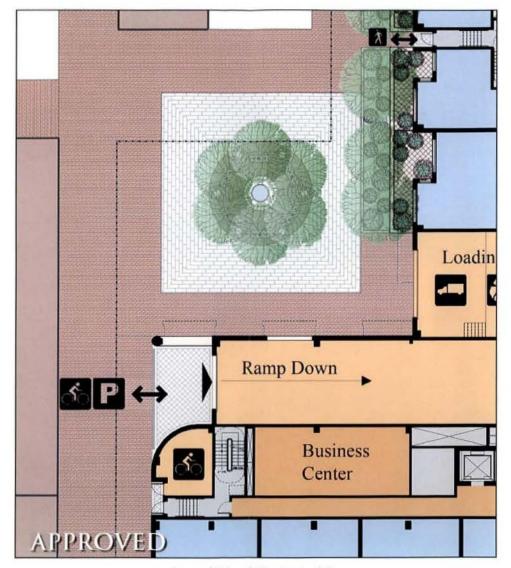

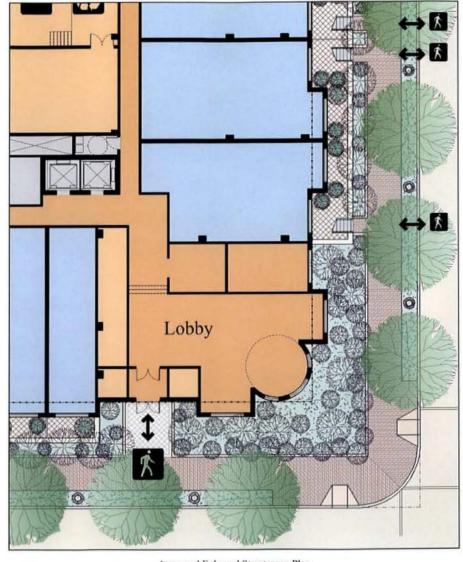

Approved Enlarged Alley Courtyard Plan

Approved Enlarged Streetscape Plan







Proposed Modified Enlarged Alley Courtyard Plan

Proposed Modified Enlarged Streetscape Plan


* Streetscape and alley changes reflect PDRM comments of 09/05/07.

Proposed Modified Enlarged Site Plan

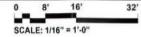

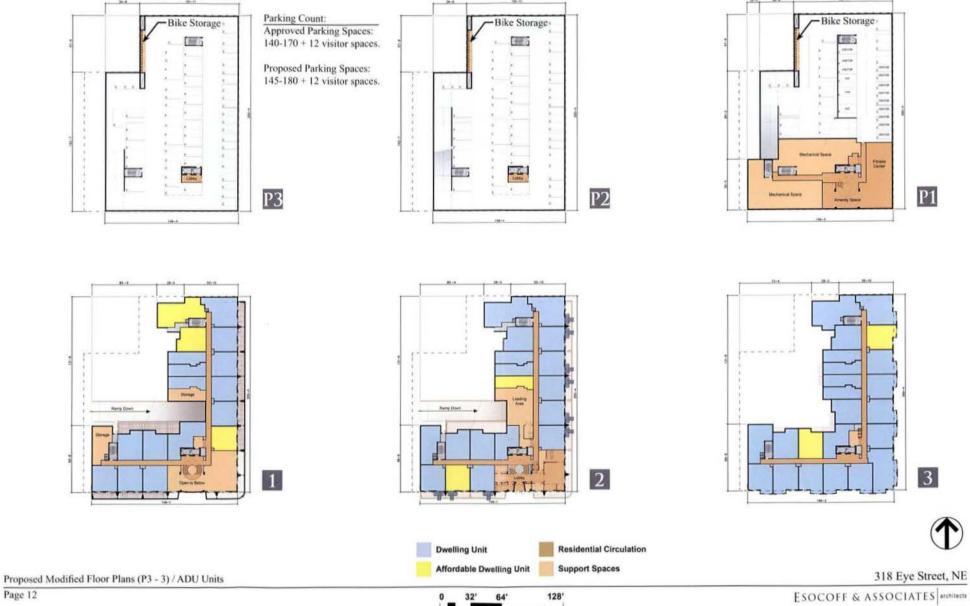

Page 12

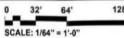




SCALE: 1/64" = 1'-0"



SCALE: 1/50" = 1'-0"

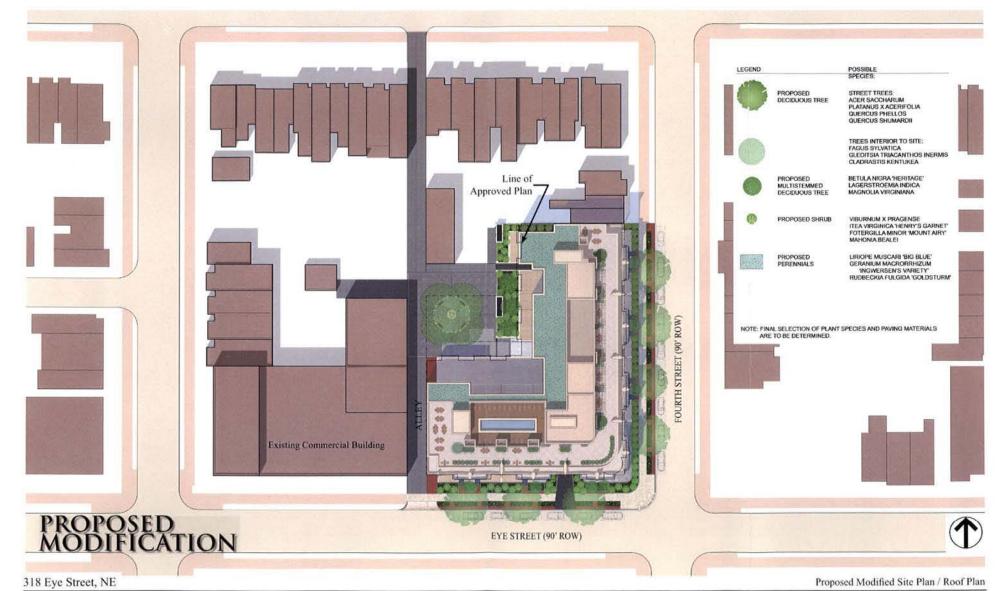

ESOCOFF & ASSOCIATES architects

0 25' 50' 100' SCALE: 1/50" = 1'-0" Page 15



Approved Eye Street Elevation



Approved 4th Street Elevation

Approved Composite Street Elevations

318 Eye Street, NE




Proposed Modified Eye Street Elevation



318 Eye Street, NE

Proposed Modified 4th Street Elevation

Proposed Modified Composite Street Elevations

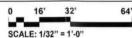



Proposed Modified Eye Street Elevation



Proposed Modified 4th Street Elevation



French Terra Cotta Tile Mediterranean Blue



French Terra Cotta Tile Montpelier Green



Architectural Cast Stone Buff



Brick
Velour
Bargello or similar ornamental
bonding pattern.



Brick Antique




Brick Harvard


Brick Cimaron



318 Eye Street, NE

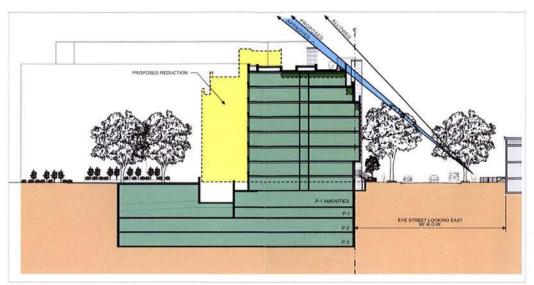

Proposed Modified Eye Street Section

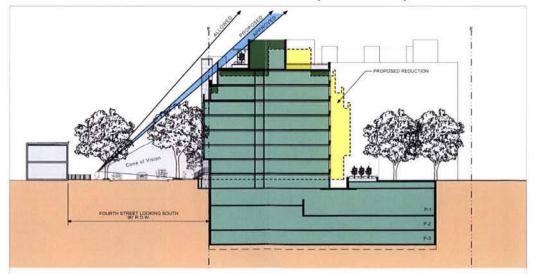

Proposed Modified 4th Street Section




Approved Enlarged Elevation at Adjoining Buildings along 4th Street Refer to page 19 for cone of vision.

Note: Varied window heights and sizes of new building and existing buildings have similar proportions, level of detail, and ornamentation.

Approved Enlarged 4th Street Elevation

318 Eye Street, NE

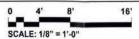





Proposed Modified Enlarged Elevation at Adjoining Buildings along 4th Street Refer to page 19 for cone of vision.

Note: Varied window heights and sizes of new building and existing buildings have similar proportions, level of detail, and ornamentation.

318 Eye Street, NE

Proposed Modified Enlarged 4th Street Elevation

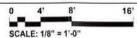


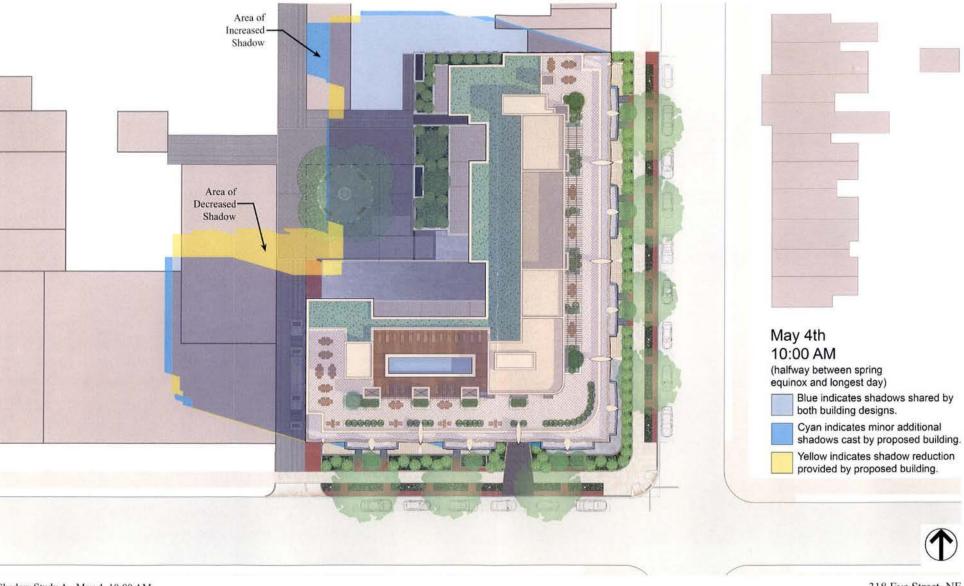

Shadow Study A - May 4, 10:00 AM

318 Eye Street, NE

0 16' 32' 6-SCALE: 1/32" = 1'-0"

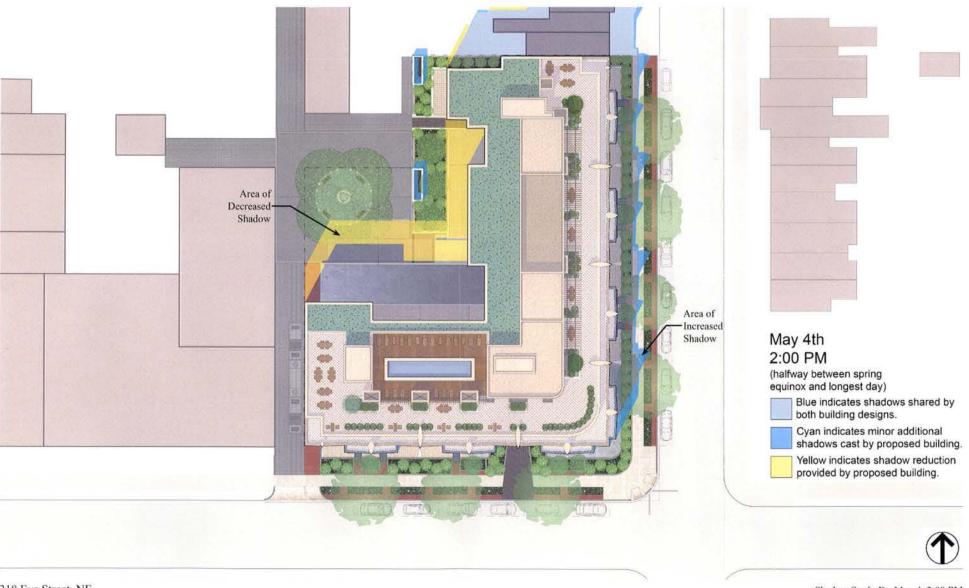

318 Eye Street, NE

Shadow Study B - May 4, 2:00 PM


0 16' 32' 6-SCALE: 1/32" = 1'-0"



Shadow Study C - November 8, 10:00 AM


318 Eye Street, NE

SCALE: 1/32" = 1'-0"

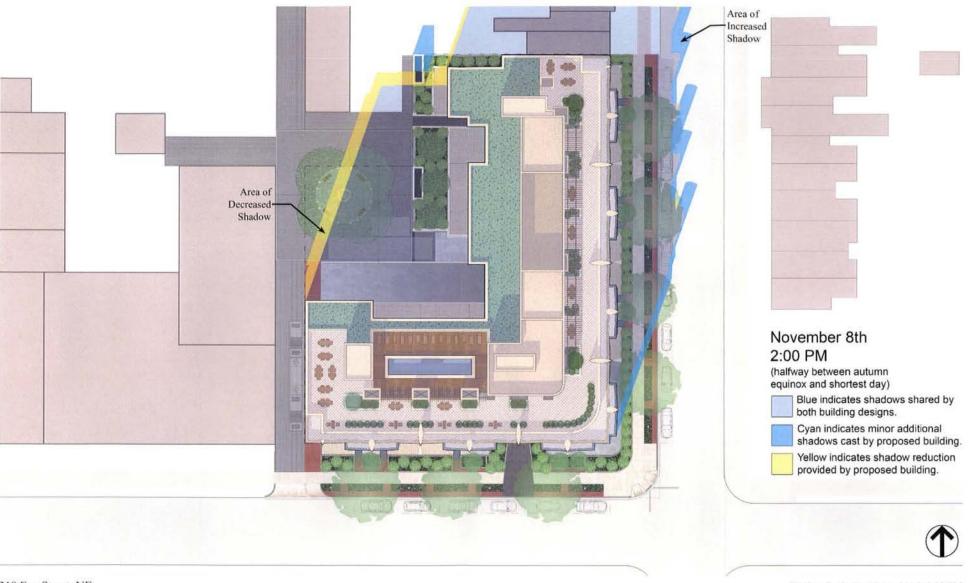

318 Eye Street, NE

Shadow Study D - November 8, 2:00 PM

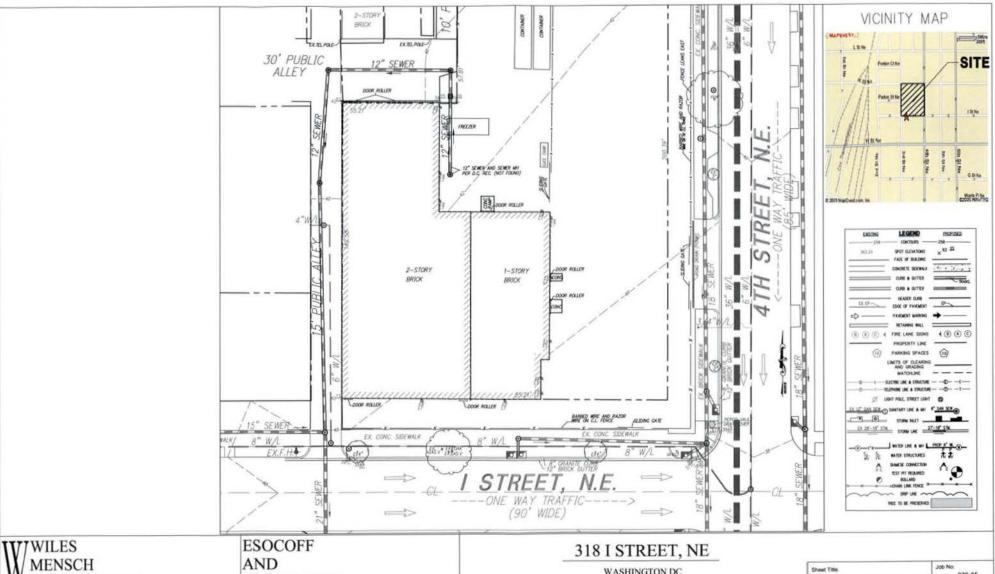


CORPORATION

Planning, Engineering, Surveying & Landscape Architecture 11860 Sunrise Valley Drive Suite 200 Reston, Virginia 20191 (T) 703.391.7600 (F) 703.264.0595 www.wilesmensch.com

ASSOCIATES

ARCHITECTS 1030 Fifteenth Street NW Suite 430, Washington DC 20005 (T) 202.682.1600 (F) 202.682.1672 www.esocoff.com


WASHINGTON DC

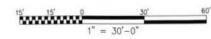


EXISTING CONDITION PLAN

Date: 05/23/05 Scale: 1:30

276-05 C.01

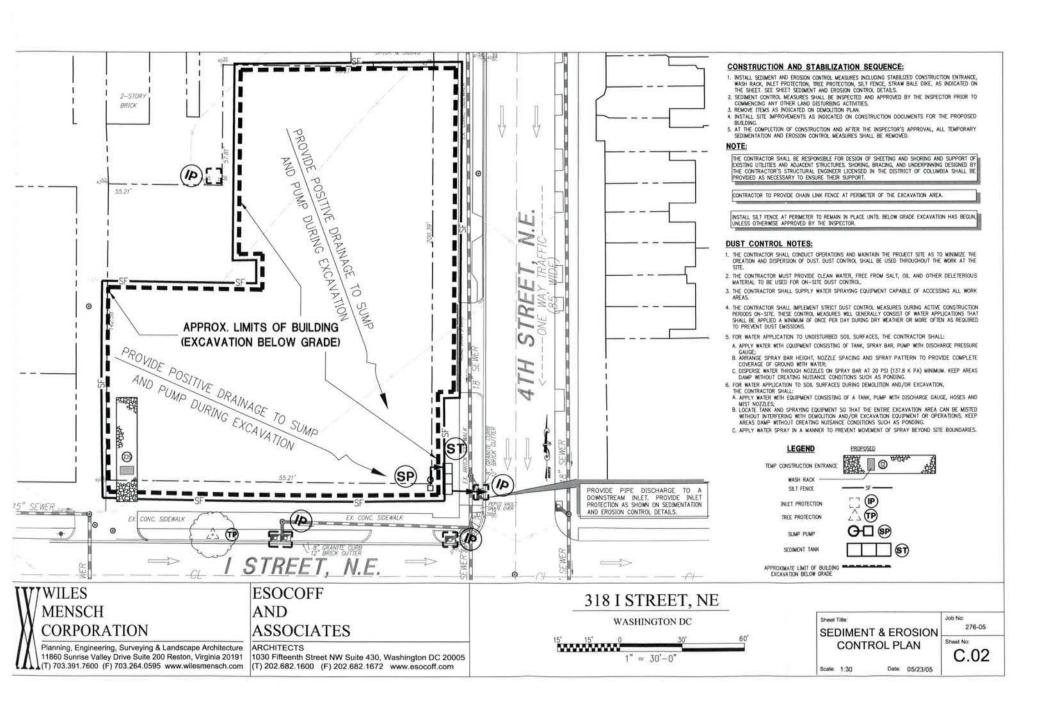

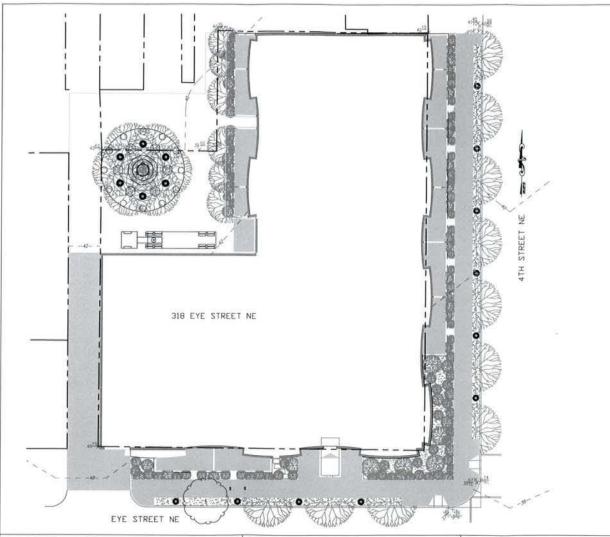

PLANTING LEGEND



MAJOR DECIDUOUS STREET TREE (2.5" CAL.)



MID-SIZE ORNAMENTAL DECIDUOUS TREE (2.5" CAL.)



EVERGREEN SCREEN TREES (10'-15') = SHRUBS (2'-3')



EXISTING TREE (TO BE REMAINED)



GROUND COVER (GRASS)


WILES **MENSCH** CORPORATION

> Planning, Engineering, Surveying & Landscape Architecture 11860 Sunrise Valley Drive Suite 200 Reston, Virginia 20191 (T) 703.391.7600 (F) 703.264.0595 www.wilesmensch.com

ESOCOFF AND ASSOCIATES

ARCHITECTS 1030 Fifteenth Street NW Suite 430, Washington DC 20005 (T) 202.682.1600 (F) 202.682.1672 www.esocoff.com 318 I STREET, NE

WASHINGTON DC

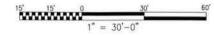

Sheet Title:

SITE **PLAN**


Scale: 1:30

Date: 05/23/05

Sheet No: C.03

276-05

Job No:

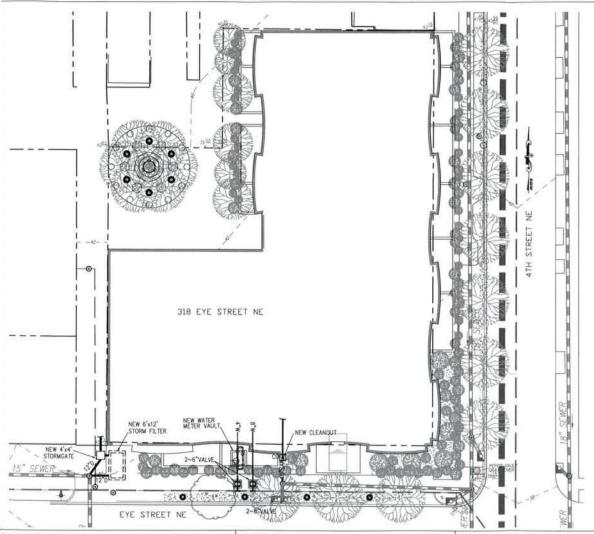

Somestic Water and Sewer Service Estimates - Residential Condominium

05072 00 5/18/2005 318 Eye Street, NW Washington, DC 120 Units, 7 Stories, approx. 160,000 GSF Sewer Unit Type SFU DFU/ea* Studio One Bedroom 7.8 215 12.0 331 28 One Bedroom Den 11.4 18.0 1080 Two Bedroom 7.5% 11.4 18.0 Two Bedroom Den Unit Totals 120 1217 Plus House Needs 10% SFU 1338 DFU 2099 TOTAL = Equivalent Flow Rates = > 10" 4" Equivalent Pipe Sizes ========>

*Fixture Units from IPC Tables:		
Kitchen Group	2.8	4.1
Laundry Group	1.4	2.0
Bath Group	3.6	6.0

TTT WILES **MENSCH** CORPORATION

> Planning, Engineering, Surveying & Landscape Architecture 11860 Sunrise Valley Drive Suite 200 Reston, Virginia 20191 (T) 703.391.7600 (F) 703.264.0595 www.wilesmensch.com

ESOCOFF AND ASSOCIATES

ARCHITECTS 1030 Fifteenth Street NW Suite 430, Washington DC 20005 (T) 202.682.1600 (F) 202.682.1672 www.esocoff.com

318 I STREET, NE

WASHINGTON DC




Sheel Title: UTILITY PLAN

Scale: 1:30 Date: 05/23/05

Job No: 276-05 Sheet No:

C.04

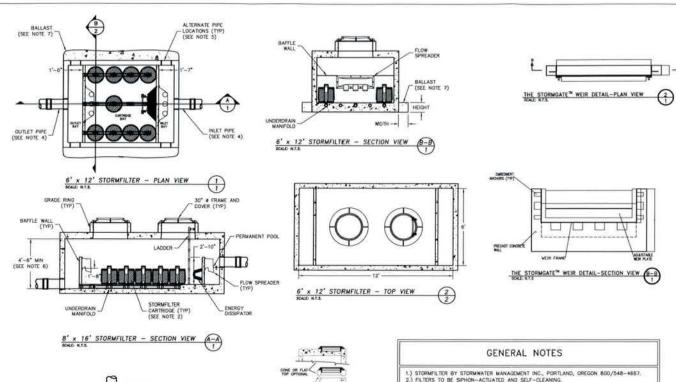

- 3.) PRECAST CONCRETE VAULT TO BE CONSTRUCTED IN ACCORDANCE WITH ASTM C857 AND C858.
- 4.) STORNFILTER REQUIRES 2.3' OF DROP FROM INLET TO OUTLET. INLET AND OUTLET PIPING TO BE SPECIFIED BY ENGINEER AND PROVIDED BY CONTRACTOR.
- 5.) PRECAST STORMFILTER EQUIPPED WITH EITHER CORED OPENINGS OR KNOCKOUTS AT INLET/OUTLET LOCATION
- 6.) RECOMMENDED MINIMUM CLEARANCE FOR MAINTENANCE ACCESS. CONTACT SMI FOR OTHER OPTIONS IF A SHALLOWER SYSTEM IS REQUIRED
- 7.) ANTI-FLOTATION BALLAST TO BE SPECIFIED BY ENGINEER IF NEEDED. BALLAST TO BE SET ALTINE ENTIRE LENGTH OF BOTH SDES OF VAULT. BALLAST MATERIALS TO BE PROVIDED BY CONTRACTOR.
- B.) ALL STORMFILTERS REQUIRE REGULAR MAINTENANCE. REFER TO OPERATION AND MAINTENANCE GUIDELINES FOR DETAILS.
- 9.) DETAIL REFLECTS DESIGN INTENT ONLY. ACTUAL VAULT DIMENSIONS AND CONFIGURATION WILL BE SHOWN ON PRODUCTION SHOP DRAWING.
- 10.) STANDARD DETAIL SHOWS MAXIMUM NUMBER OF CARTRIDGES. EXACT NUMBER REQUIRED TO BE SPECIFIED ON SITE PLANS.

STORMWATER MANAGEMENT CALCULATIONS:

FIRST FLOOR AREA = 0.60 AC

. PRE-DEVELOPED RUNOFF (15 YEAR STORM)

TC= 5 MINUTES, 115" 7.56 M/YR, C=0.75 APEA - 0.68 AC

Q₁₅ = Cl₁₅A = 0.75 x 7.58 x 0.60 = 3.40 cfs

· POST-DEVELOPMENT RUNOFF (15 YEAR STORN)

To- 5 MINUTES, 115- 7.56 IN/YR AREA = 0.60 AC

Q₁₅ = CI₁₅A = 0.9 x 7.56 x 0.60 = 4.68 cfs

SIZE CHART:

	STORMFILTER	NUMBER OF CARTRIDGES	NOMINAL EXTERIOR FOOTPRINT	
	VALLT SIZE	(100 m) (100 m)	WESTH (FT)	LENGTH (FT)
j	6 x 8	1 10 6	7	9
	6 x 12	7 10 11	.7	13
	8 x 16	12 10 26	9	17
ï	8 × 18	27 10 33	-9	.19

DETERMINE NO. OF CARTRIDGES:

AREA = 0.60 AC

1. Otreat = 0.90 x 0.5 in./hr. x 0.68 AC Qtreat = 0.27 cfs

2. Nflow = Qtreat (449 gpm/cfs / 15 gpm/cartridge)

Nflow = 0.27 cfs x 449 gpm/cfs 15 gpm/cartridge

Nflow = 8.68 cartridges *** USE 9 CARTRIDGES

GENERAL NOTES:

- STORMGATE BY STORMWATER MANAGEMENT, INC., PORTLAND, OREGON (800-548-4667). ALL WATER QUALITY FACILITIES REQUIRE REGULAR MAINTENANCE. MINIMUM ANNUAL MAINTENANCE INCLUDES INSPECTION OF COMPONENTS AND REMOVAL OF SEDIMENTS. FOLLOW ALL LOCAL, STATE, &
- FEDERAL SAFETY GUIDELINES. PRECAST CONCRETE MANHOLE CONSTRUCTED IN ACCORANCE WITH ASTM C858.
- EXTERNAL PIPING AND COUPLINGS PROVIDED BY OTHERS.
- FLEXIBLE COUPLINGS TO BE SET 18" OUTSIDE FACE OF WALL, FERNCO OR ENGINEER APPROVED. SEE PRECAST STORMGATE DATA BLOCK FOR MANHOLE SIZE AND WEIR SETTING.
- CONTRACTOR TO ADJUST WEIR TO DESIGN ELEVATION.
- WHEN SETTING SCREWS ON WEIR PLATE DO NOT EXCEED 5.0 FT-LBS TOURQUE
- SEAL WEIR WITH SILICONE SEALANT AFTER FINAL ADJUSTMENT.

TTTTWILES MENSCH CORPORATION

Planning, Engineering, Surveying & Landscape Architecture 11860 Sunrise Valley Drive Suite 200 Reston, Virginia 20191 (T) 703.391.7600 (F) 703.264.0595 www.wilesmensch.com

THE STORMGATE" - PLAN VIEW

ESOCOFF AND ASSOCIATES

THE STORMGATE " - SECTION VIEW

ARCHITECTS

1030 Fifteenth Street NW Suite 430, Washington DC 20005 (T) 202.682.1600 (F) 202.682.1672 www.esocoff.com

318 I STREET, NE

WASHINGTON DC


Sheet Title: Job No: 276-05 SWM PLAN Sheet No: C.05


Scale: N.T.S

Date: 05/23/05



- 2. FILTER CLOSE TO BE FASTINED SECURELY TO SCHOOL WHE FONCE WHITE THE SPACES EVENT OF AT TOP AND ME SECTION.
- I WEN THE SECTIONS OF FRENCHSON ASSEM-LICH STEER BELT SHALL BE OVER-LAMPED BY SEL NOVES AND FOUNDS FETER CLOTH FETER & MENTS STATE NO. THEN OR APPROVED COLIN.
- HE STANT SHELL BE PERCHAST AS MEDICO HE SECTION PROPERTY STANDS WITH SMILES, SCHOOL BY THE SECTION OF THE SECTI

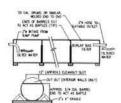

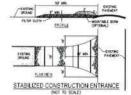

CONSTRUCTION RAMP SPECIFICATION

- THE THE WE Z' STAM, OF RELIANCE OF RECYCLES CONCRETE CONVARIANT LINEAR A 30 CONTRACTOR OF ROLL AND ANY Z'
- FOOT WINDOWS LIBERS WINDLE APPLYS.

 TO SHOWERS BUT LISS SHIME SIE (4) SHOWEL

 NEITH SIE (16) FOOT WINDOWS, BUT NOT LISE SHAW FULL MIDSH OF ALL POINTS OF SHOWESS ON
 FORESS OCCURS.


 FILTER DANN- MIL BE PLANED DURS THE SHIFTER AND A PRIOR TO PLANES OF STORE, FILTER MIL AND
 RESPONSED ON A STRUCK FAMILY RESIDENCE LOT!

- RUDGIC WELL'S SALL BE CLEMED TO REMOVE SCHINDLY FROM TO ENTRANCE ONTO PARILE FOUR-OF-RET. BUCK WORKERS OF RECORDS. IT SHALL BE ONE ON AN AREA STABLUED WITH STONE WHICH SHANG BYTO AN APPROVED SCHINCT SWAFFING CENCE. PERSONE REPORTED AND MECKED WANTOWNED SWALL BE PROVIDED AFTER CACH RAIN.




- BALES SANLI SE PLACED AT THE TOK OF A SLOPE OR ON THE CONTOUR AND SE A FIDN WITH DOES SEGRET ABSTERS THE ADJACEST BALES. LADI BALE SHALL OF EMPELOY ON THE SER, A MINIMAN OF (4) SHORES, AND PLACED SO THAT SHOREST AFE HORIZONIA.
- BALES SHIRL BE REMOVED WHEN THEY HAVE SERVED THEIR LITERALISES SO HIS NOT TO BLOCK OR SAFEDE STORM THOM OR DRIVANION.

STRAW BALE DIKE

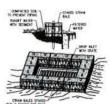

STRAW BALE DROP INLET SEDIMENT FILTER

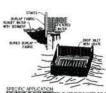


BURLAP DROP INLET





CURB INLET SEDIMENT FILTER

- 1. THE CONCRETE BLOCKS SHALL BE PLACED ON THEM SIDES ABUTTAGE THE DARK AT ETHER SIDE OF THE BLET STOCKE.
- 1 A 2 NOT BY A NOT THE BHALL OF CUT HIS PLACED THROUGH THE CITES HOLES OF CACH WASHINGTON TO HOLF HER THOM BLOOD IN MAJES
- I CONDICT BLOOK SHALL BE PLACED ON THEIR SERS ACROSS THE FRONT OF THE WILLT AND ARRESTMEN THE SPHOOT BLOOKS AS ELECTRATED. 4 MIR MISH SHALL BE PLACED ONED THE OUTSIDE WESTERN FACE (MERONIC OF THE CONCEPTE BLOCKS TO PROVIDE STOKE FROM MEMOR THEOLOGY THE PLACES OF THE BLOCKS CHEEKEN MIRE OF AMERICAN CLOTH WITH 1/2—PAYS SPECIAL BE USED.
- 5 TWO TO THREE MOST STORE SHALL HE PLED AGAINST THE MINE TO THE KIP OF THE EMPIRER AS SHOWN.

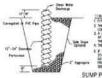

- FIT DESCRIBES HE STEMAN.

 THE CHARGES HAVE DESCRIBED IN PROPERATE A TOTAL OF DIMETER

 A ME OF A CONCESSION DESCRIBED IN SECTION IN LIGHT OF THE

 A ME OF A CONCESSION DESCRIBED IN SECTION IN LIGHT OF THE

 A ME OF A CONCESSION DESCRIBED IN SECTION OF THE PROPERTY SHOULD

 A ME OF A CONCESSION DESCRIPED IN THE SECTION OF THE

 A DESCRIPT SHOULD CHARGE IT IN THE SECTION OF THE

 CONCESSION DESCRIPT IN THE SECTION OF THE PROPERTY SHOULD

 THE SECTION OF THE SECTION OF THE SECTION OF THE SECTION OF THE

 SECTION OF THE SECTION OF THE SECTION OF THE SECTION OF THE

 SECTION OF THE SECTION OF THE SECTION OF THE SECTION OF THE

 SECTION OF THE SECTION OF THE SECTION OF THE SECTION OF THE

 SECTION OF THE

SUMP PIT


STANDARDS AND SPECIFICATIONS BRICKBAT GROUND COVER

CETECTION
TOPICATION CONTRIBUTION OF MICHIGANICS (1/2)
PECE OF SHALLEY PLACED OVER DENOTED EARTH. PLEASE PROVIDE A BARDWAY ORGAN COMP DAY BESSET PROVIDE A BARDWAY OF TRANSPORTATION OF STEWOOD FROM THE SITE.

CONCIONE WHEN PRACTICE MYCHEL BROSSATS MAY BE USED IN ANY BE IN MEED OF EMPORAN COMMON COMES.

BRICKBAT DETAIL


THE WALT monnonne - for man UUUUUUUUUUUUU TYPICAL TREE PROTECTION

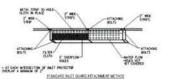



ETWO HO BLET OLAND CHOSE SECTION

GRADE INLET GUARD

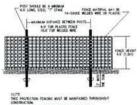

TREE PROTECTION FENCE INSTALLATION DETAIL

0 STANLING CONSTRUCTION DICTARG 065-1 WAY THE DATE TRACKS Ott-3 FIFT SLOPE IRM P90-12 DEATHS AND STREET LINED WATERWAY NOT BUILT PROTECTOR SERVICE SERVICE A.

LIST OF STANDARD SYMBOLS

EROSION AND SEDIMENT CONTROL MEASURES AND SEQUENCE

D-O GO

- I ALL CROSCH ME NOMEN CONTION MEASURES SHALL BE PLACED FROM TO UP AS THE FIRST STEP IN CHARGE L PROBE TWOOMS TONG CONTRACTOR DOWNERS AND MODERN OF AN INC FEST SIZE IS MAKED.

 AN INCE TO COM ALL COMPANY LISTING SIZE.

 INCELL, COMM IN COMPANY LISTING SIZE.

 IN COLUMN THE COMPANY LISTING SIZE.

SHEETING AND SHOPING

- A NO DITTURBED AREA WILL BE DENOTE FOR WORE THAN 7 CALIDISAN DAYS. NOTALL THE RECESSARY BUNDANCH OR PERMANENT WESTATIVE STABILIZATION WEASINES TO ACHEW ADJUSTE ERISION AND SEDMENT CONTROL
- ALL CONSTRUCTION TO BE DESPECTED SHAP BY THE CONSTRUCTOR, AND ANY SAWAKED SETATION OF EROSON CONTROL DEVICES OF MEXICIPES HELL BY REPARTS AT THE GLOSE OF THE GAT.
- E. ALL TITME BALL DICES TO BE MARKINGO IN MORPHIC COMPUTES.

 I. STABILLIZES CONSTRUCTION DATEMANCE TO BE PERSONNALL SUPPLEMENTED WITH ADDITIONAL STORE AS INSECTION.
- A CONTROL WILL BE REMOVED WITCH THEIR CONTRIBUTING BASINS HAVE BEEN FORWARDADY STABLESS.

SILTATION EROSION CONTROL NOTES

- Blindert and cholone control set vicini shall be rotalish before the "Ulwit of any cochanico.

 Our conductions in the "deviced in professions for set indicates the "seath control in a state of control in a state of the seath o
- AL MEDIALNY AND EXCHANGE CONTROL ACADLAGES TO BE INSPECTED DAILY BY THE CONTRACTOR ANY DAMAGES DEVICE OR MEASURE WILL BE REPORTED OF REPLACED BY THE ARCHITECT ALL MANUEL LEAVES TO THE THE PARK, DIT MODISM THE CONFIDENCE INTRACED THAT HAS SHALL BY MODIES TO BROAD HAS THE CONFIDENCE AS EVENT OF THE CONFIDENCE AS EVE
- ${\bf y}$ any catch basis of Dran Records Closed as a result of Dicambian or Construction, the compactor small be responsible for its marsians cleaned.
- CONSIDER DOLD HE DEST DOLD ANNE DIGINAL DIA MARKET SERVICE ME SERVICE L'ANNE DE L'ANNE

- A THE CONTROL OF CONTROL PROCESSOR STATEMENT OF MACH. ST.

 A THE CONTROL OF CONTROL PROCESSOR MICH. THE AND A CONTROL SOCIETY OF CONTROL SECRECAL APPROXICAL AND EMPERORY TO TAKEN, DELINEATIONS AND EMPERORY CONTROL SECRECAL TO SECRECAL THE CONTROL AND EMPERORY TO TAKEN AND EMPERORY STATEMENT AND EMPERORY STATEMENT.

TTTWILES MENSCH CORPORATION

Planning, Engineering, Surveying & Landscape Architecture 11860 Sunrise Valley Drive Suite 200 Reston, Virginia 20191 (T) 703.391.7600 (F) 703.264.0595 www.wilesmensch.com

ESOCOFF AND ASSOCIATES

1030 Fifteenth Street NW Suite 430, Washington DC 20005 (T) 202.682.1600 (F) 202.682.1672 www.esocoff.com

318 I STREET, NE

WASHINGTON DC

Sheet Title: SEDIMENT & EROSION

CONTROL DETAILS

Scale: N.T.S

Date: 05/23/05

C.06

276-05